3

4

2

CITY CLERK...

FAYETTE COUNTY BUCHANAN COUNTY

123

CORPORATELIMITS)

BOP BEGIN RESURFACING STA 65+03.2 MP 23.67

WISCONSIN ST

FAIRBANK ST≸

COREY SI VANDAELE ST

STOP RESURFACING

MATT COFFIN

RON WOODS

BRITTANY FULLER

ST

DAVIS

CIOWADOT

PLANS OF PROPOSED IMPROVEMENTS FOR THE PRIMARY ROAD SYSTEM Y OF FAIRBANK, IOWA BUCHANAN COUNTY

PCC PAVEMENT - REPLACE

IOWA 281 IN FAIRBANK

Refer to the Proposal Form for list of applicable specifications.

Value Engineering Saves. Refer to Article 1105.15 of the Specifications.

> 04-30-02 101 - 5DESIGN DATA URBAN 2023 AADT 2400 V.P.D. 2043 AADT <u>2600</u> V.P.D. TRUCKS __13__ % Total Design ESALs____

This project is covered by U.S. Army Corps of Engineers Nationwide Permit No. N/A

This project is covered by lowa DNR Floodplain Construction Permit No. 2022—1591FP—01

This project is covered by the lowa Department of Natural Resources NPDES General Permit No. 2. The contractor shall carry out the terms and conditions of General Perm No. 2 and the storm water pollution prevention plan which is part of these contract documents. Refer to Section 2602 of the Standard Specifications for additional





	STATE	FHWA REGION	F.Y.	SHEET	TOTAL			
	IOWA	7			132			
	PROJ	ECT IDENTIF	ICATION	NUN P	IBER			
20-10-281-010								
	R.O.W. PROJECT NUMBER							
	STPN-281-2(9)2J-10							
	PROJECT NUMBER							
	ST	PN-281-20	(10)	-2J-1	0			

FEHR GRAHAM

PROJ. No. 22-1100

11	NDEX OF SHEETS 105-3 10-18-05
No.	Description
A.01 A.02 A.03-A.04 B.01-B.08 C.01-C.04 C.05-C.17 D.01-D.09 D.10-D.14 G.01 H.01-H.05 J.01-J.15 L.01-L.23 M.01-M.04 M.05-M.13 P.01-P.10 RC.01-RC.04 U.01-U.04 U.05-U.08 W.01-W.10	TITLE SHEET LEGEND SITE MAP TYPICAL CROSS SECTION ESTIMATED PROJECT QUANTITIES & REFERENCE INFORMATION TABULATIONS GRADING PLAN & PROFILE PAVEMENT MARKINGS BENCHMARKS & CENTERLINE DATA RIGHT—OF—WAY AND ACQUISITIONS TRAFFIC CONTROL GEOMETRIC AND STAKING DETAILS WATER MAIN PLAN & PROFILE LIGHTING PLAN EROSION CONTROL PLAN REMOVAL PLAN DETAILS CROSS SECTIONS
132	TOTAL SHEETS

CITY OF FAIRBANK, IOWA

THIS ENGINEERING DOCUMENT IS RECOMMENDED FOR FILING WITH

10/27/2022

DATE



HEREBY CERTIFY THAT THIS ENGINEERING DOCUMENT WAS PREPARED BY ME OR UNDER MY DIRECT PERSONAL SUPERVISION AND THAT I AM A DULY LICENSED PROFESSIONAL ENGINEER UNDER THE LAWS OF THE STATE OF IOWA.

Tru Hapen ERIC HEYNEN

10/27/2022

P24706 MY LICENSE RENEWAL DATE IS DECEMBER 31, 2023.

PAGES OR SHEETS COVERED BY THIS SEAL:

"P" LIGHTING SHEETS



I hereby certify that this engineering document was prepared by me or under my direct personal supervision and that I am a duly licensed Professional Engineer under the laws of the State of Iowa.

10/27/2022

Jon Biederman Jon S. Biederman, P.E. License Number 13868

Date

My license renewal date is December 31, 2022. Pages or sheets covered by this seal: A-M and RC-W SHEETS

BUCHANAN COUNTY

PROJECT NUMBER STPN-281-2(10)--2J-10

SHEET NUMBER A.01

10/27/22 G:\C3D\22\22-1100 Fairbank Hwy 281\Plans\22-1100 PLANS.dwg

ENGLISH

RHONDA RIÓ

NORTH

FORES

MAIN

GROVE

SOUTH

ST

ST

문 PATTERSON

WASHINGTON ST


BEGIN RECONSTRUCTION


(FAIRBANK CORPORATE LIMETS)

FRONT

EOP END RECONSTRUCTION STA 103+51.5 MP 24.35

IOWA DOT DESIGN TEAM JSB/AFC

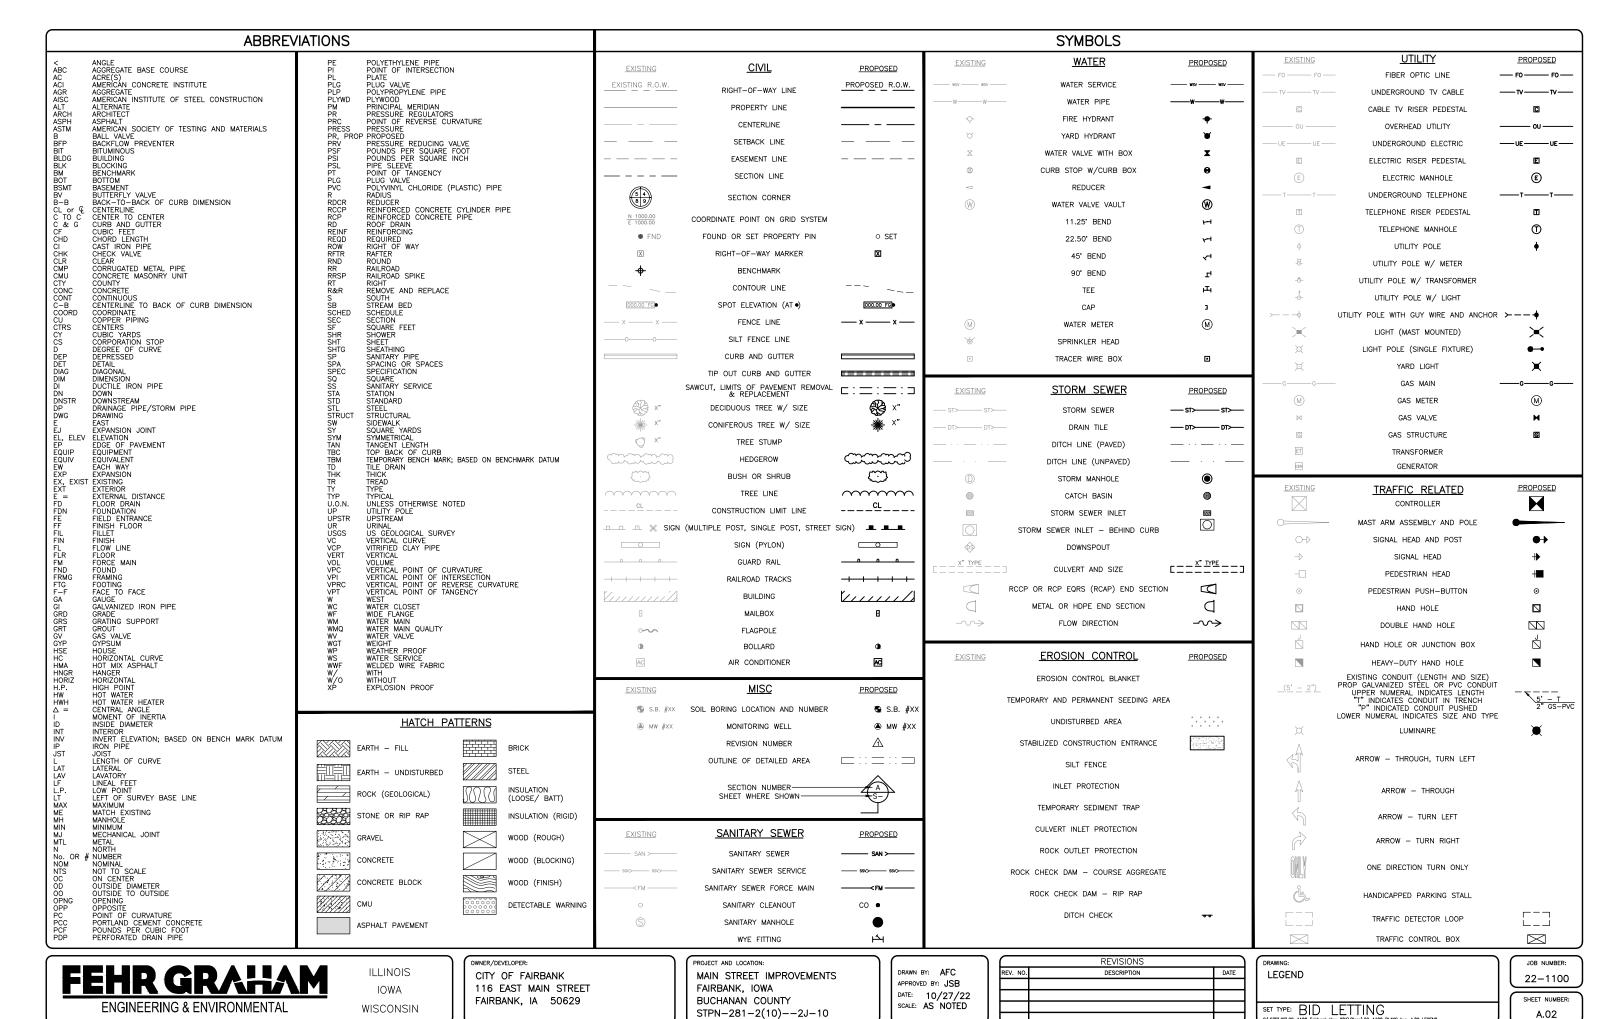

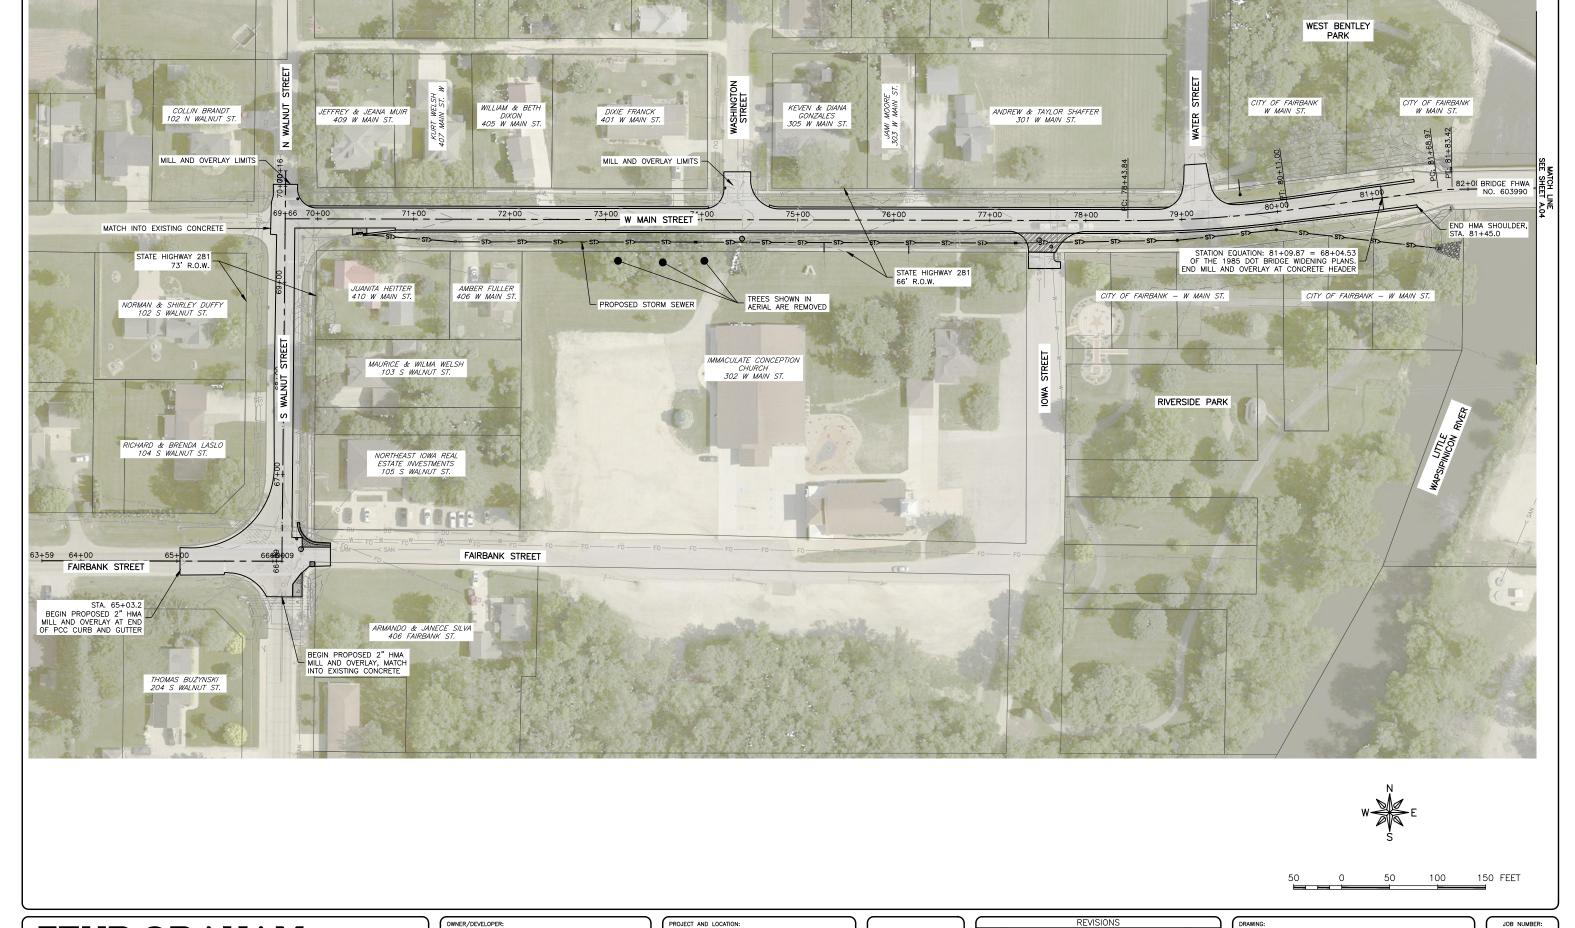

FEHR GRAHAM

ENGINEERING & ENVIRONMENTAL

ILLINOIS IOWA WISCONSIN

CITY OF FAIRBANK 116 EAST MAIN STREET FAIRBANK, IA 50629 PROJECT AND LOCATION:

MAIN STREET IMPROVEMENTS
FAIRBANK, IOWA
BUCHANAN COUNTY
STPN-281-2(10)--2J-10

DRAWN BY: AFC
APPROVED BY: JSB
DATE: 10/27/22
SCALE: AS NOTED

	REVISIONS	
REV. NO.	DESCRIPTION	DATE


DRAWING:
SITE MAP

SET TYPE: BID LETTING
SOLON 201 201 100 Enthrole May 201 Depart 72 - 1100 BIANS Ann. A01 SITE

22-1100

SHEET NUMBER:

A.03

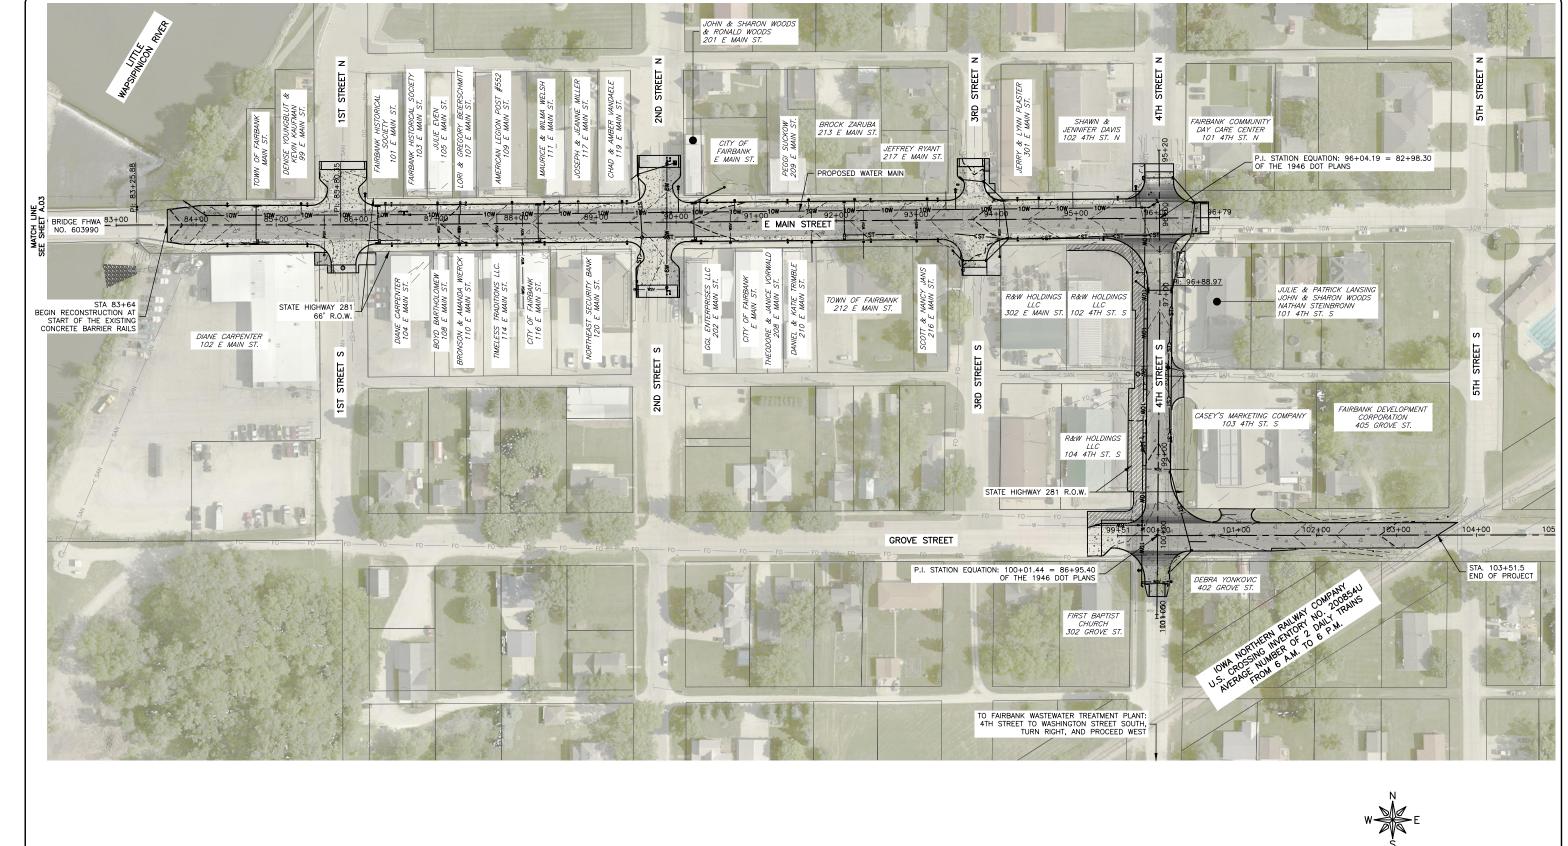



60 120 180 FEET

ENGINEERING & ENVIRONMENTAL

ILLINOIS IOWA WISCONSIN

OWNER/DEVELOPER: CITY OF FAIRBANK 116 EAST MAIN STREET FAIRBANK, IA 50629


PROJECT AND LOCATION: MAIN STREET IMPROVEMENTS FAIRBANK, IOWA BUCHANAN COUNTY STPN-281-2(10)--2J-10


DRAWN BY: AFC APPROVED BY: JSB DATE: 10/27/22 SCALE: AS NOTED

	REVISIONS	`
REV. NO.	DESCRIPTION	DATE

SITE MAP SET TYPE: BID LETTING


JOB NUMBER: 22-1100 SHEET NUMBER: A.04

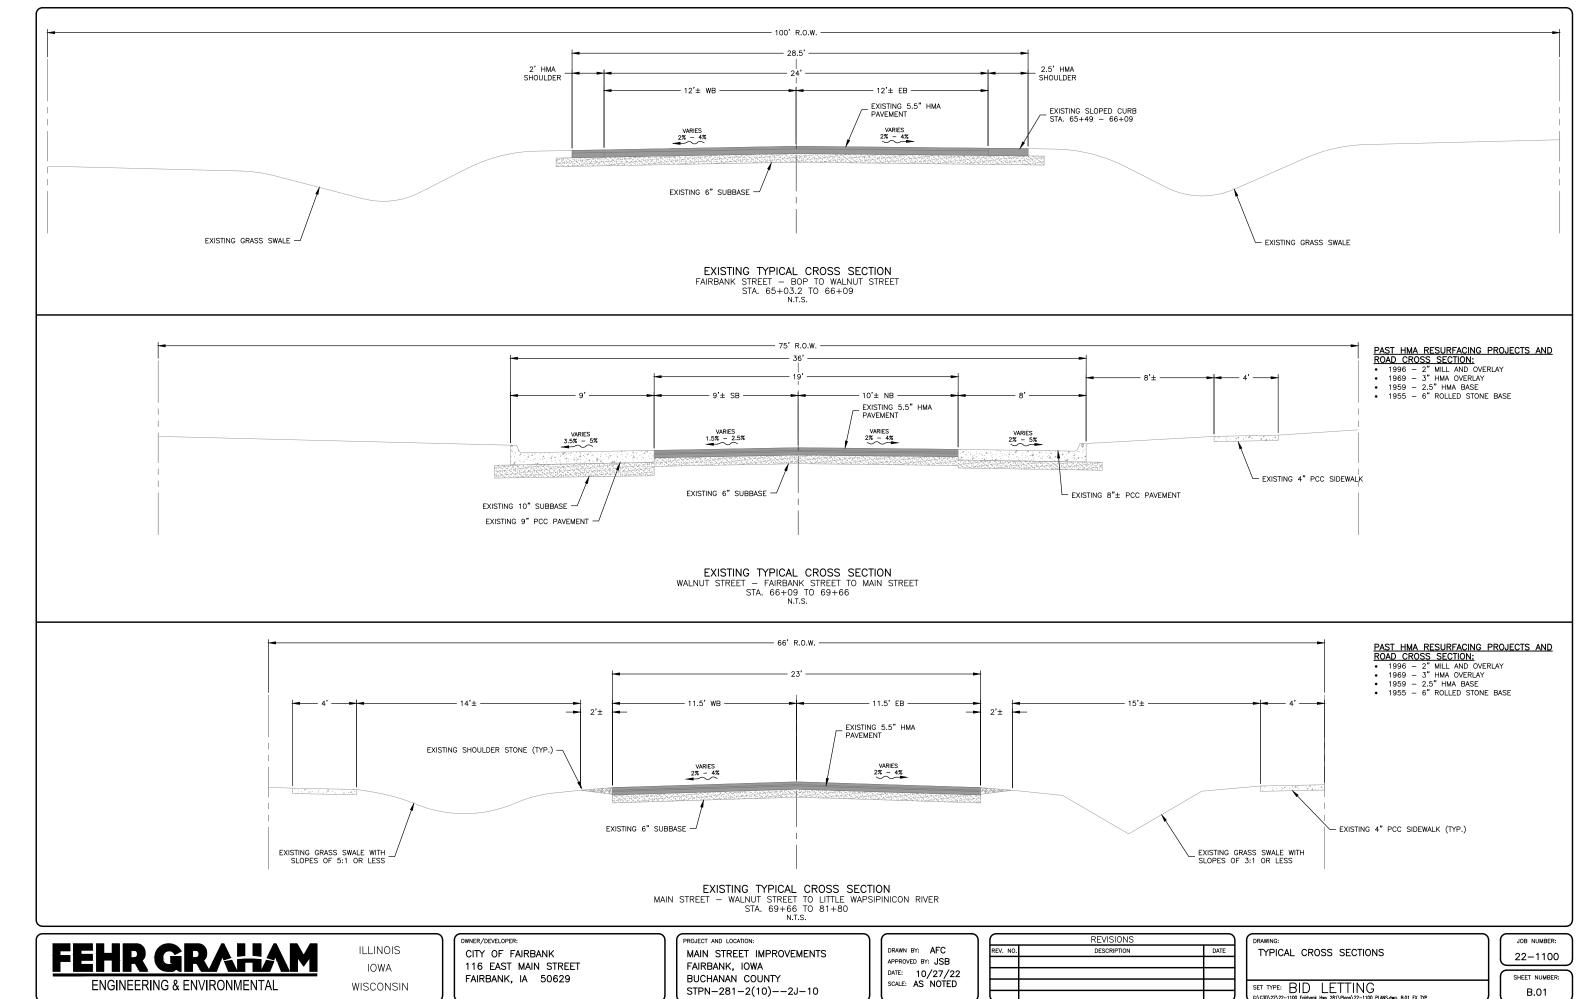

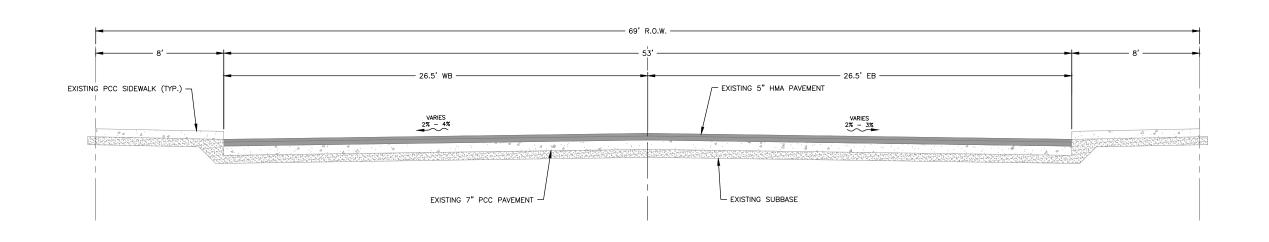

EXISTING TYPICAL CROSS SECTION

MAIN STREET - LITTLE WAPSIPINICON RIVER TO STA. 91+66
STA. 83+64 TO 91+66
N.T.S.

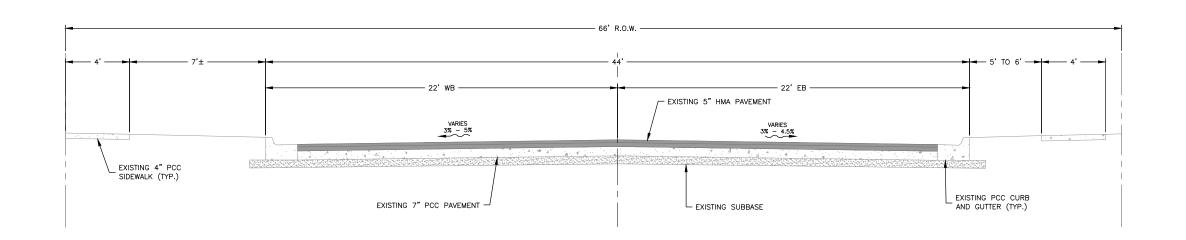

EXISTING TYPICAL CROSS SECTION
MAIN STREET - STA. 91+91 TO 4TH STREET
STA. 91+66 TO 96+04
N.T.S.



ILLINOIS IOWA WISCONSIN owner/developer:
CITY OF FAIRBANK
116 EAST MAIN STREET
FAIRBANK, IA 50629

PROJECT AND LOCATION:

MAIN STREET IMPROVEMENTS
FAIRBANK, IOWA
BUCHANAN COUNTY
STPN-281-2(10)--2J-10

DRAWN BY: AFC
APPROVED BY: JSB
DATE: 10/27/22
SCALE: AS NOTED

REVISIONS							
REV. NO.	DESCRIPTION	DATE]				
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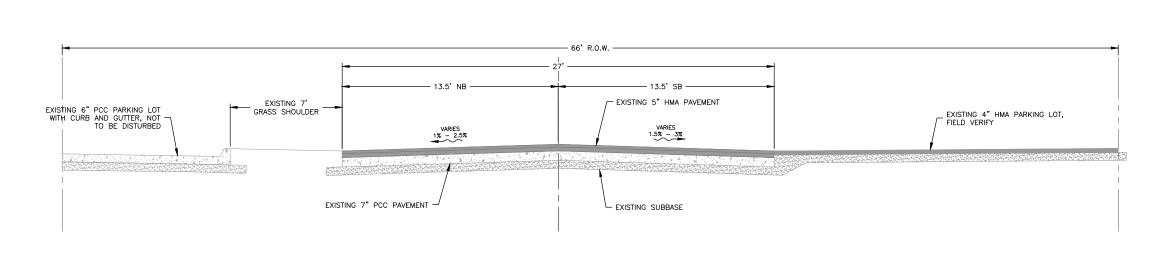
DRAWING:
TYPICAL CROSS SECTIONS

SET TYPE: BID LETTING


JOB NUMBER:
22-1100

SHEET NUMBER:

в.02



EXISTING TYPICAL CROSS SECTION
4TH STREET - MAIN STREET TO STA. 97+90
STA. 96+04 TO 97+90
N.T.S.

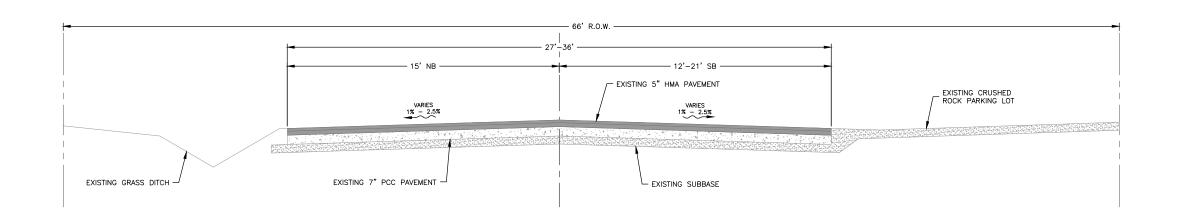

EXISTING TYPICAL CROSS SECTION
4TH STREET - STA. 97+90 TO GROVE STREET
STA. 97+90 TO 100+01.5
N.T.S.

FEHR GRALLAM
ENGINEERING & ENVIRONMENTAL

ILLINOIS IOWA WISCONSIN owner/developer:
CITY OF FAIRBANK
116 EAST MAIN STREET
FAIRBANK, IA 50629

PROJECT AND LOCATION:

MAIN STREET IMPROVEMENTS
FAIRBANK, IOWA
BUCHANAN COUNTY
STPN-281-2(10)--2J-10

DRAWN BY: AFC
APPROVED BY: JSB
DATE: 10/27/22
SCALE: AS NOTED

REVISIONS							
REV. NO.	NO. DESCRIPTION D						


DRAWING:
TYPICAL CROSS SECTIONS

SET TYPE: BID LETTING

22-1100 SHEET NUMBER:

JOB NUMBER:

B.03

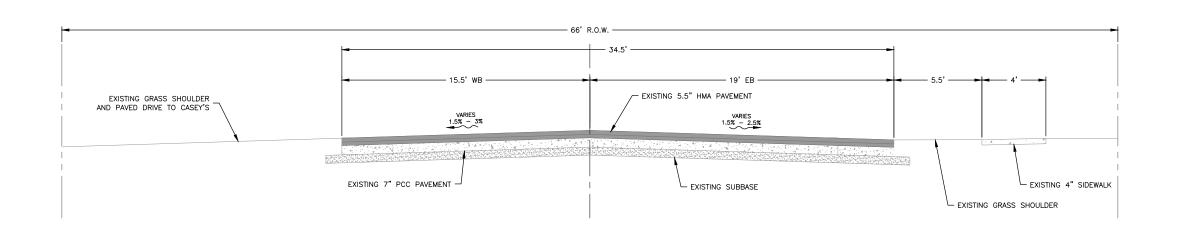


EXISTING TYPICAL CROSS SECTION

GROVE STREET - 4TH STREET TO EASTERLY 140'

STA. 100+01.5 TO 101+40

N.T.S.

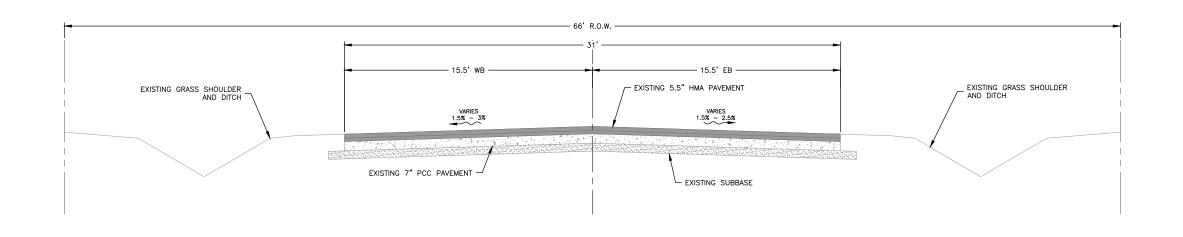

EXISTING TYPICAL CROSS SECTION

GROVE STREET - 4TH STREET TO EASTERLY 350'
STA. 101+40 TO 103+50
N.T.S.



ILLINOIS IOWA WISCONSIN owner/developer:
CITY OF FAIRBANK
116 EAST MAIN STREET
FAIRBANK, IA 50629

PROJECT AND LOCATION:

MAIN STREET IMPROVEMENTS
FAIRBANK, IOWA
BUCHANAN COUNTY
STPN-281-2(10)--2J-10

DRAWN BY: AFC
APPROVED BY: JSB
DATE: 10/27/22
SCALE: AS NOTED


REVISIONS								
REV. NO.	DESCRIPTION	DATE						


DRAWING:
TYPICAL CROSS SECTIONS

SET TYPE: BID LETTING
G:(C30)(22\22-1100 Fairbank Hay 281\Pana)(22-1100 PANS.dag, 8.04 EX TYP

JOB NUMBER: 22-1100

SHEET NUMBER: B.04

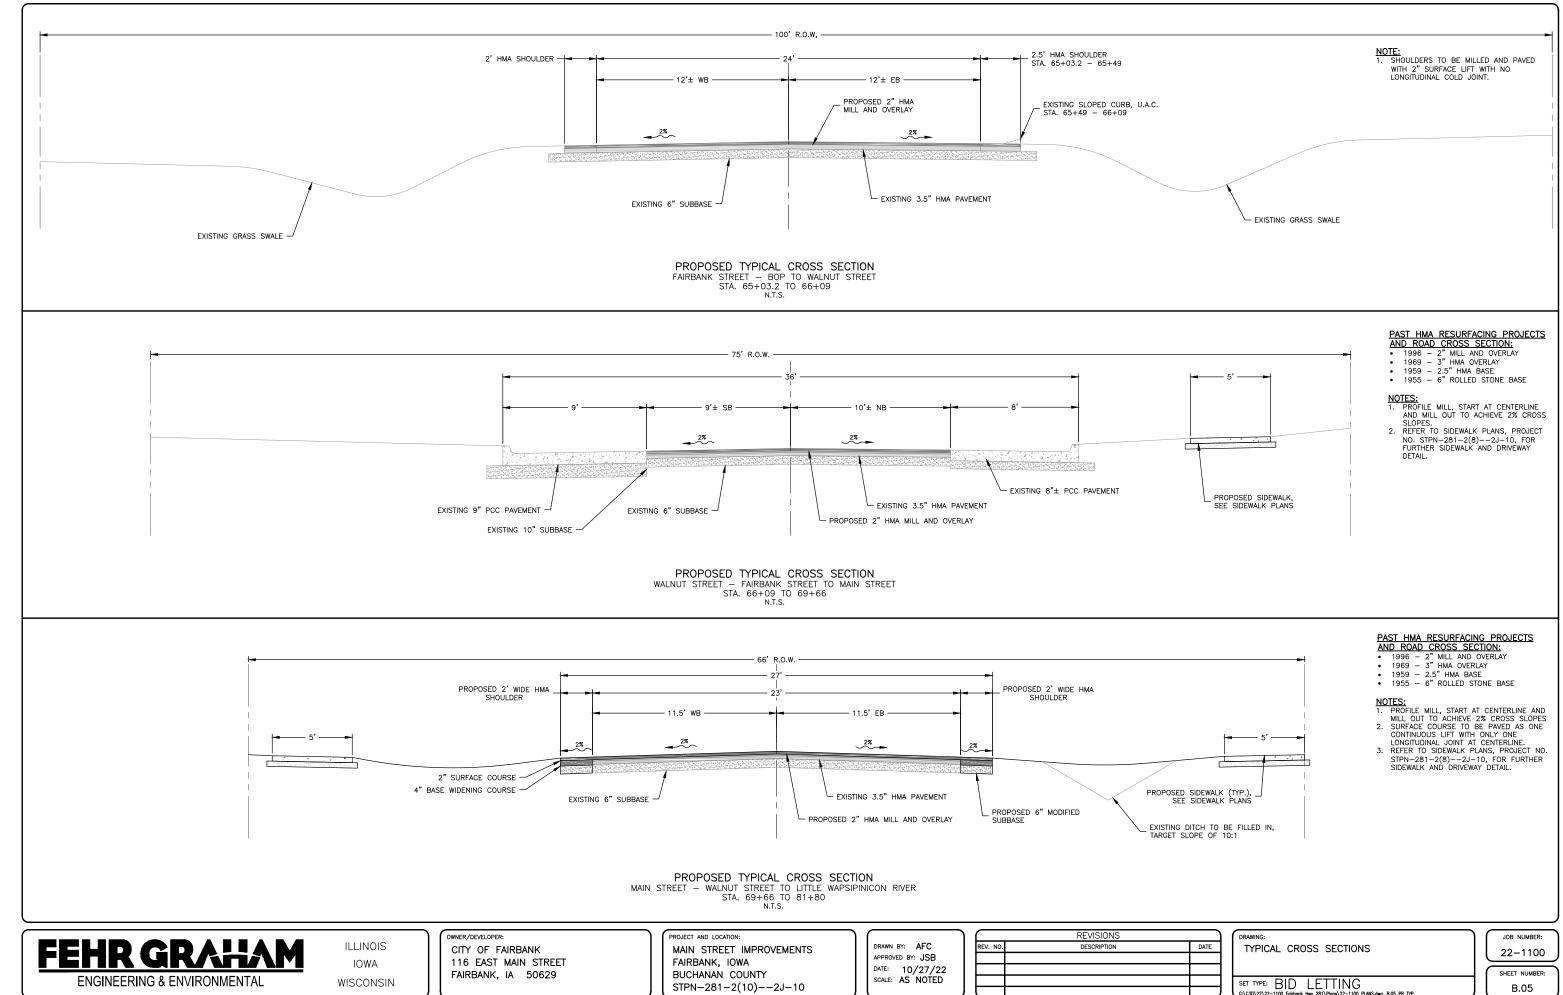


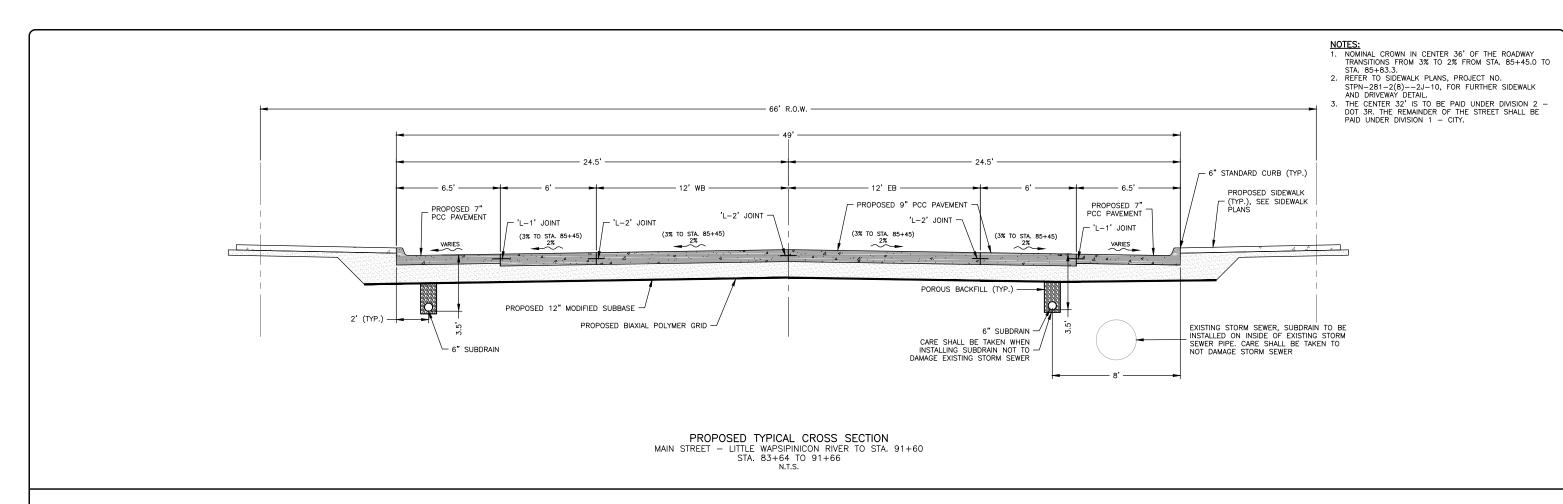

- NOTES:

 1. REFER TO SIDEWALK PLANS, PROJECT NO.
 STPN-281-2(8)—-2J-10, FOR FURTHER SIDEWALK
 AND DRIVEWAY DETAIL.

 2. THE CENTER 32' IS TO BE PAID UNDER DIVISION 2 —
 DOT 3R. THE REMAINDER OF THE STREET SHALL BE
 PAID UNDER DIVISION 1 CITY.

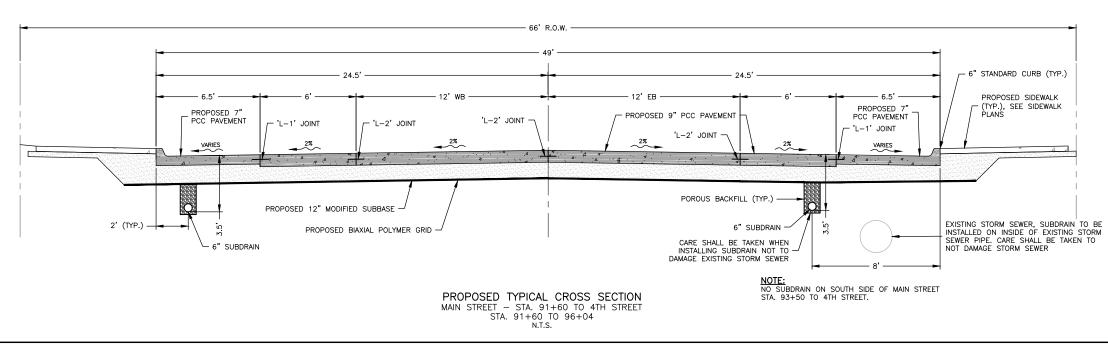

FEHR GRAHA **ENGINEERING & ENVIRONMENTAL**

ILLINOIS IOWA WISCONSIN OWNER/DEVELOPER: CITY OF FAIRBANK 116 EAST MAIN STREET FAIRBANK, IA 50629

PROJECT AND LOCATION MAIN STREET IMPROVEMENTS FAIRBANK, IOWA BUCHANAN COUNTY STPN-281-2(10)--2J-10

DRAWN BY: AFC APPROVED BY: JSB DATE: 10/27/22 SCALE: AS NOTED

REVISIONS DESCRIPTION DATE


TYPICAL CROSS SECTIONS

SET TYPE: BID LETTING


JOB NUMBER: 22-1100

SHEET NUMBER: B.06

NOTE: REFER TO SIDEWALK PLANS, PROJECT NO. STPN-281-2(8)--2J-10, FOR FURTHER SIDEWALK AND DRIVEWAY DETAIL.

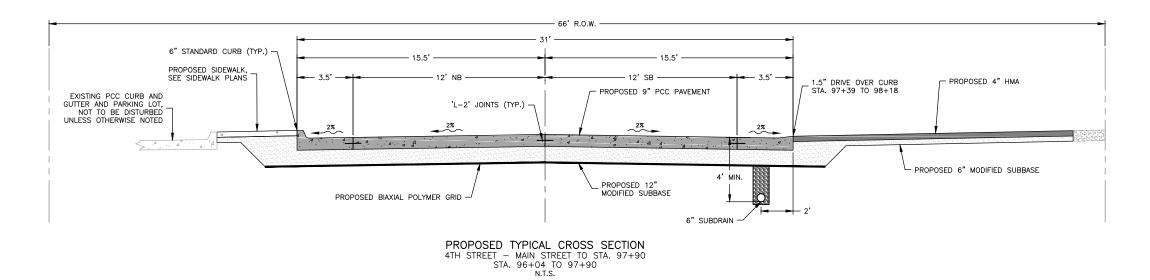

NOTE:
REFER TO SIDEWALK PLANS, PROJECT NO.
STPN-281-2(8)--2J-10, FOR FURTHER SIDEWALK AND
DRIVEWAY DETAIL.

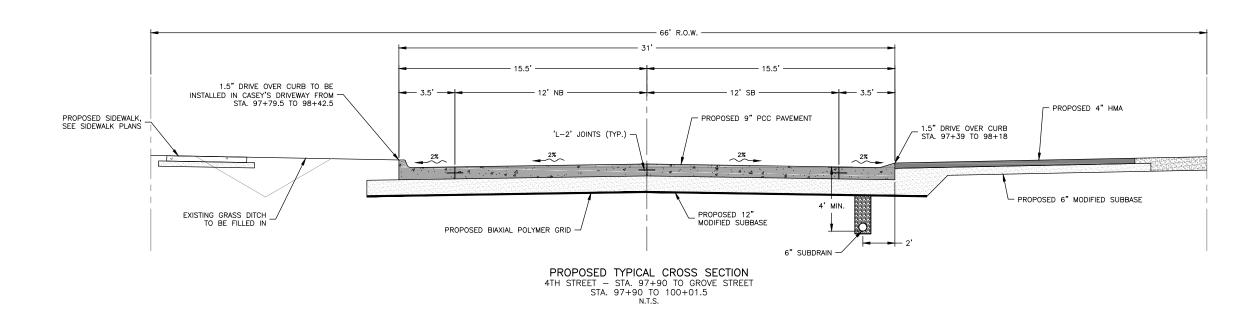

FEHR GRAHAM

ENGINEERING & ENVIRONMENTAL

ILLINOIS IOWA WISCONSIN owner/developer:
CITY OF FAIRBANK
116 EAST MAIN STREET
FAIRBANK, IA 50629

PROJECT AND LOCATION:

MAIN STREET IMPROVEMENTS
FAIRBANK, IOWA
BUCHANAN COUNTY
STPN-281-2(10)--2J-10

DRAWN BY: AFC
APPROVED BY: JSB
DATE: 10/27/22
SCALE: AS NOTED

REVISIONS							
REV. NO.	/. NO. DESCRIPTION						

DRAWING:
TYPICAL CROSS SECTIONS

SET TYPE: BID LETTING

6\C30\22\22-1100 Fidebank Hay 28\Plans\22-1100 PANS.dag, B.07 PR TYP


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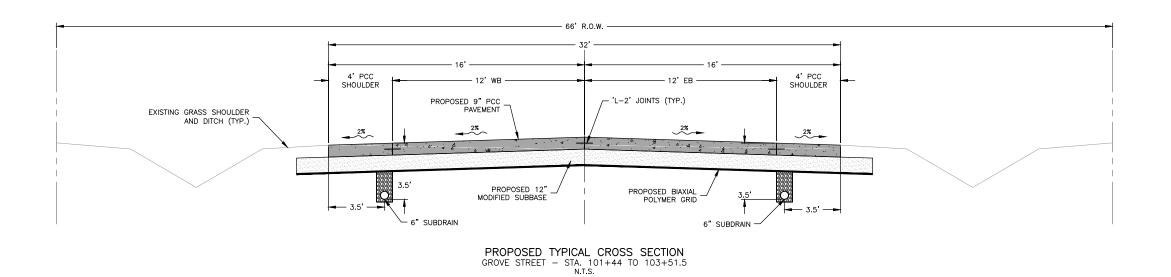
22-1100

SHEET NUMBER:

B.07

PLOT DATE: 10/31/22 © 2022 FEHR GRAHAM



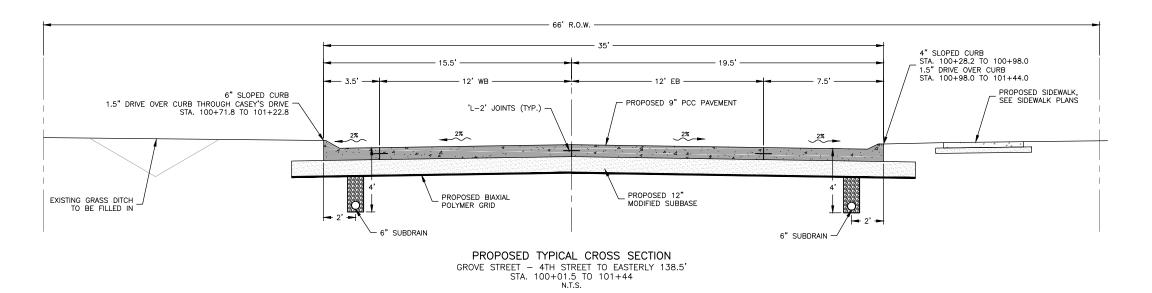



ILLINOIS IOWA WISCONSIN owner/developer: CITY OF FAIRBANK 116 EAST MAIN STREET FAIRBANK, IA 50629 PROJECT AND LOCATION:

MAIN STREET IMPROVEMENTS
FAIRBANK, IOWA
BUCHANAN COUNTY
STPN-281-2(10)--2J-10

DRAWN BY: AFC
APPROVED BY: JSB
DATE: 10/27/22
SCALE: AS NOTED

REVISIONS						
REV. NO.	DESCRIPTION	DATE				

DRAWING:
TYPICAL CROSS SECTIONS

SET TYPE: BID LETTING
G\C30\22\22-1100 Fairbonk Hny 281\Plans\22-1100 PANS.dng, B.08 PR TYP

JOB NUMBER:

22-1100

SHEET NUMBER:

B.08

PLOT DATE: 10/31/22 © 2022 FEHR GRAHAM

ESTIMATED PROJECT QUANTITIES AND REFERENCE NOTES

Item

2301-1033070 STANDARD OR SLIP FORM PORTLAND CEMENT CONCRETE PAVEMENT, CLASS C, CLASS 3 DURABILITY, 7 IN.

2301-1033090 STANDARD OR SLIP FORM PORTLAND CEMENT CONCRETE PAVEMENT, CLASS C. CLASS 3 DURABILITY, 9 IN.

2301-7000110 PAYMENT ADJUSTMENT INCENTIVE/DISINCENTIVE FOR PCC PAVEMENT THICKNESS (BY SCHEDULE)

2317-7000110 PAYMENT ADJUSTMENT INCENTIVE/DISINCENTIVE FOR PCC PAVEMENT SMOOTHNESS (BY SCHEDULE)

2303-1042500 HOT MIX ASPHALT HIGH TRAFFIC, INTERMEDIATE COURSE, 1/2 IN. MIX

2303-1043504 HOT MIX ASPHALT HIGH TRAFFIC, SURFACE COURSE, 1/2 IN. MIX, FRICTION L-4

1 2101-0850001 CLEARING AND GRUBBING	ACRE	0.1		CLEARING AND GRUBBING OF SHRUBS, BUSHES, AND TREES ESTIMATED TO BE 6-INCHES AND LESS IN DIAMETER ALONG THE LITTLE WAPSIPINICON RIVER BANK WHERE THE PROPOSED AND EXISTING STORM SEWER OUTLETS ARE LOCATED.
2 2102-2625000 EMBANKMENT-IN-PLACE	CY	692		ITEM FOR HAULING AND PLACEMENT OF EXCAVATED FILL MATERIAL TO BE PLACED IN THE EXISTING DITCH ALONG THE SOUTH SIDE OF W. MAIN STREET AND ALONG THE EAST SIDE OF 4TH STREET NEAR CASEY'S. FILL SHALL BE COMPACTED TO 95% OF MAXIMUM DENSITY AT 6 IN. LIFTS.
3 2102-2710090 EXCAVATION, CLASS 10, WASTE	CY	1,203	2,170	ITEM IS FOR THE EXCAVATION MATERIAL FOR THE PROPOSED STREET AND DRIVES, SEE SIDEWALK PLANS BY OTHERS FOR EXCAVATION FOR SIDEWALK AND DRIVEWAYS NOT INCLUDED IN THESE PLANS. EXCAVATION ESTIMATES DO NOT INCLUDE STRIPPING OR PLACING 6-INCHES OF TOPSOIL. ESTIMATES OF EARTHWORK FOR THE PROJECT ARE AS FOLLOWS: TOTAL EXCAVATION - 3373 CY; FILL REQUIRED (SHRINKAGE FACTOR OF 1.3 USED IN CALCULATING) - 692 CY; CUT MATERIAL - 3373 CY; BALANCE - 2681 CY OF CUT. SUITABLE EXCAVATED MATERIAL SHALL BE USED AS FILL FOR THE PROJECT, IF NEEDED. EXCESS SUITABLE MATERIAL TO BE HAULED TO THE CITY MASTEWATER TREATMENT AND STOCKPILED AT A LOCATION INDICATED BY THE JURISDICTION, LOCATED ON THE WEST END OF SOUTH WASHINGTON STREET OFF OF SOUTH 4TH STREET. UNSUITABLE MATERIAL SHALL BECOME

Quantities

Estimated

Division 2

5,860

10

152.4

4,861.1

7,771.1

36.5

Unit

CY

TON

CY

TON

SY

SY

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FACH

TON

TON

TON

SY

EACH

Division 1

3,450

3,352.7

3.6

981

12

16

0.67

1

11

10.67

3

5 2212-0475095 CLEANING AND PREPARATION OF BASE

6 2212-5070310 PATCHES, FULL-DEPTH REPAIR

7 2212-5070330 PATCHES BY COUNT (REPAIR)

8 3 60.33 FOR CLEANING AND PREPARATION OF BASE ALONG W. MAIN STREET FOR MILLING OPERATIONS. BRIDGE TO BE SWEPT CLEAN AFTER ASPHALT AND CONCRETE PAVING OPERATIONS.

8 2212-5070310 PATCHES, FULL-DEPTH REPAIR

8 5 15.5 ITEM FOR FULL DEPTH PATCHES AT THE INTERSECTION OF FAIRBANK STREET AND WALNUT STREET TO REPAIR A SINKHOLE AND REMOVE PCC WITH SEALCOAT OVER TOP. SEE SHEETS

8 2212-5070330 PATCHES BY COUNT (REPAIR)

L.01 AND R.01 FOR FURTHER DETAIL.

10 ITEM IS A CONTINGENT BID ITEM FOR ANY SURFACE PATCHES THAT MAY BE REQUIRED UPON COMPLETION OF MILLING OPERATIONS PRIOR TO PLACING THE 2-INCH HMA LIFT ALONG FAIRBANK STREET, WALNUT STREET, AND W. MAIN STREET.

152.4 ITEM IS FOR THE EXCAVATION MATERIAL FOR THE PROPOSED 2-FEET WIDE SHOULDER ALONG W. MAIN STREET, SEE B, D, AND L SHEETS FOR DETAILS. EXCAVATION ESTIMATES ARE FOR A 2-FEET WIDE TRENCH 1-FOOT DEEP IN ORDER TO PLACE 6-INCHES OF MODIFIED SUBBASE AND 6-INCHES OF HOT MIX ASPHALT FOR THE SHOULDER. TOTAL EXCAVATION - 152.4 CY; FILL REQUIRED - 0 CY; CUT MATERIAL - 152.4 CY; BALANCE - 152.4 CY OF CUT. SUITABLE EXCAVATED MATERIAL SHALL BE USED AS FILL FOR THE PROJECT, IF NEEDED. EXCESS SUITABLE MATERIAL TO BE HAULED TO THE CITY WASTEWATER TREATMENT AND STOCKPILED AT A LOCATION INDICATED BY THE JURISDICTION, LOCATED ON THE WEST END OF SOUTH WASHINGTON STREET OFF OF SOUTH 4TH STREET. UNSUITABLE MATERIAL SHALL BECOME PROPERTY OF THE CONTRACTOR AND SHALL BE REMOVED FROM THE LIMITS OF THE PROJECT AT THE COST OF THE CONTRACTOR.

Division 1 : City of Fairbank

Division 2 : Iowa DOT

Estimate Reference Notes

PROPERTY OF THE CONTRACTOR AND SHALL BE REMOVED FROM THE LIMITS OF THE PROJECT AT THE COST OF THE CONTRACTOR. EXCAVATION FOR THE CENTER 32-FEET OF E. MAIN

PREPARATION OF SUBGRADE SHALL BE INCIDENTAL TO THIS BID ITEM. MODIFIED SUBBASE SHALL BE 12 IN. DEPTH UNDER 9 IN. AND 7 IN. PCC PAVEMENT ALONG IA 281, 8 IN.

457 ITEM FOR 4 IN. THICK BASE WIDENING FOR THE 2-FEET WIDE SHOULDER ALONG W. MAIN STREET, SEE B, D, AND L SHEETS FOR DETAILS.

4,861.1 STREET TO BE PROFILE MILLED FROM CENTERLINE OUT TO ACHIEVE 2% CROWN, SEE D AND L SHEETS FOR FURTHER DETAIL. CONTRACTOR SHALL NOT LEAVE SCARRED HMA SURFACE EXPOSED FOR MORE THAN 5 CALENDAR DAYS. PAID PER SQUARE YARD OF MATERIAL REMOVED, REGARDLESS OF THICKNESS. PAVEMENT MILLINGS TO BE HAULED TO THE CITY WASTEWATER TREATMENT AND STOCKPILED AT A LOCATION INDICATED BY THE JURISDICTION, LOCATED ON THE WEST END OF SOUTH WASHINGTON STREET OFF OF SOUTH 4TH STREET HAULING MILLINGS, NEATLY STOCKPILING MILLINGS, AND REGRADING THE STOCKPILE SITE TO BE FREE OF ALL RUTS TO BE INCIDENTAL TO THE BID ITEM.

3.352.7 FOR PAVING THE DUTFER PARKING LANES AND TRANSITION AREA ALONG F. MAIN STREET AND FOR PAVING CITY SIDE STREETS. SEE R. D. AND I SHEETS FOR FURTHER DETAIL AND

3,352.7 FOR PAVING THE OUTER PARKING LANES AND TRANSITION AREA ALONG E. MAIN STREET AND FOR PAVING CITY SIDE STREETS, SEE B, D, AND L SHEETS FOR FURTHER DETAIL AND LOCATIONS. QUANTITY INCLUDES 6 IN. STANDARD CURB AS SHOWN ON THE B AND L SHEETS. CONTRACT UNIT PRICE PER SY, INCLUDING ALL REQUIRED REBAR AND DOWEL BAR REINFORCEMENT FOR JOINTS AND BOXOUTS, SHALL BE CONSIDERED FULL COMPENSATION FOR THE CONSTRUCTION OF PAVEMENT. NO ADDITIONAL PAYMENT WILL BE MADE IF FIELD ADJUSTMENTS ARE MADE TO JOINT OR BOXOUT LOCATIONS. CERTIFIED PLANT INSPECTION SHALL BE REQUIRED AS SPECIFIED IN SECTION 2521 OF THE IDOT STANDARD SPECIFICATIONS.

7,771.1 FOR PAVING THE MAINLINE PORTION OF THE STREET, SEE B, D, AND L SHEETS FOR FURTHER DETAIL AND LOCATIONS. QUANTITY INCLUDES 6 IN. STANDARD CURB AS SHOWN ON THE B AND L SHEETS. CONTRACT UNIT PRICE PER SY, INCLUDING ALL REQUIRED REBAR AND DOWNEL BAR REINFORCEMENT FOR JOINTS AND BOXOUTS, SHALL BE CONSTDERED FULL COMPENSATION FOR THE CONSTRUCTION OF PAVEMENT. NO ADDITIONAL PAYMENT WILL BE MADE IF FIELD ADJUSTMENTS ARE MADE TO JOINT OR BOXOUT LOCATIONS. CERTIFIED PLANT INSPECTION SHALL BE REQUIRED AS SPECIFIED IN SECTION 2521 OF THE IDOT STANDARD SPECIFICATIONS. THE CENTER 32-FEET ALONG E. MAIN STREET, 4TH STREET PAVING, AND PAVING ALONG GROVE STREET TO BE PAID UNDER COTTY DIVISON 1.

ITEM FOR PAVING THE 1.5 IN. INTERMEDIATE ASPHALT LIFT ON CITY SIDE STREETS.

620 ITEM FOR PAVING 2 IN. SURFACE LIFT ON W. MAIN STREET AND 1.5 IN. SURFACE LIFT ON CITY SIDE STREETS.

STREET, AND EXCAVATION FOR PAVEMENT ALONG 4TH STREET AND GROVE STREET TO BE PAID UNDER DIVISION 2.

DEPTH UNDER 7 IN. PCC PAVEMENT AND 3 IN. HMA ON SIDE STREETS, AND 6 IN. DEPTH UNDER DRIVEWAYS AND PARKING LOTS.

40.1 ITEM FOR INTERMEDIATE AND SURFACE COURSE HOT MIX ASPHALT MIXES FOR STREET PAVING. ITEM CALCULATED AT 6% OF THE ASPHALT TONNAGE.

ITEM FOR PAVING 3 IN. AND 4 IN. THICK HMA DRIVES AND PARKING AREAS IN TWO LIFTS. METHOD OF MEASUREMENT SHALL BE BY EACH SY OF HMA DRIVEWAY THAT IS PAVED, REGARDLESS OF THICKNESS. THE AREA OF MANHOLES, INTAKES, OR OTHER FIXTURES IN THE PAVEMENT WILL NOT BE DEDUCTED FROM THE MEASURED PAVEMENT AREA. BASIS OF PAYMENT SHALL BE AT THE CONTRACT UNIT PRICE PER SQUARE YARD OF HMA DRIVEWAY THAT IS PAVED.

2 ITEM FOR REMOVAL OF EXISTING CONCRETE LIGHT POLE FOOTINGS AND BASES, ESTIMATED TO BE 2-FEET BY 2-FEET, DEPTH IS UNKNOWN. NO MEASUREMENT SHALL BE MADE AS PAYMENT SHALL BE BY EACH FOOTING REMOVED, REGARDLESS OF SIZE AND MATERIAL. FOOTINGS TO BECOME THE PROPERTY OF THE CONTRACTOR AND DISPOSED OF PROPERLY. SEE TABULATIONS AND R SHEETS FOR LOCATIONS.

16 SEE TABULATIONS AND R SHEETS FOR LOCATIONS. ITEM TO INCLUDE DISCONNECTING ELECTRICAL, REMOVING LIGHT POLES, REMOVAL AND/OR PLUGGING CONDUIT. PAYMENT SHALL BE BY EACH LIGHT POLE THAT IS REMOVED.

TO BE INSTALLED ALONG THE WEST RIVER BANK SOUTH OF W. MAIN STREET, SEE TABULATIONS AND M SHEETS FOR LOCATION.

1 SEE TABULATIONS AND M SHEETS FOR LOCATIONS. USE MATERIALS MEETING REQUIREMENTS OF SECTION 4119 FOR PIPE BEDDING PER SW-102 OR SW-104 AS APPROPRIATE. CERTIFIED PLANT INSPECTION SHALL BE REQUIRED AS SPECIFIED IN SECTION 2521 OF THE IOWA DOT STANDARD SPECIFICATIONS.

1 SEE TABULATIONS AND M SHEETS FOR LOCATIONS. USE MATERIALS MEETING REQUIREMENTS OF SECTION 4119 FOR PIPE BEDDING PER SW-102 OR SW-104 AS APPROPRIATE. CERTIFIED PLANT INSPECTION SHALL BE REQUIRED AS SPECIFIED IN SECTION 2521 OF THE 10WA DOT STANDARD SPECIFICATIONS.

11 SEE TABULATIONS AND M SHEETS FOR LOCATIONS. USE MATERIALS MEETING REQUIREMENTS OF SECTION 4119 FOR PIPE BEDDING PER SW-102 OR SW-104 AS APPROPRIATE.

CERTIFIED PLANT INSPECTION SHALL BE REQUIRED AS SPECIFIED IN SECTION 2521 OF THE IOWA DOT STANDARD SPECIFICATIONS.

1 SW-503 INTAKE TO BE MODIFIED TO CONNECT THE EXISTING STORM SEWER MAIN WITH LITTLE TO NO PIPE DEFLECTION. SEE THE TABULATIONS, M, AND U SHEETS FOR FURTHER DEFINITION CONTROL TO SECTION 2521 OF THE TABLE TO SECTION 2521

DETAILS. CERTIFIED PLANT INSPECTION SHALL BE REQUIRED AS SPECIFIED IN SECTION 2521 OF THE IOWA DOT STANDARD SPECIFICATIONS.

SEE TABULATIONS AND M SHEETS FOR LOCATIONS. USE MATERIALS MEETING REQUIREMENTS OF SECTION 4119 FOR PIPE BEDDING PER SW-102 OR SW-104 AS APPROPRIATE.

CERTIFIED PLANT INSPECTION SHALL BE REQUIRED AS SPECIFIED IN SECTION 2521 OF THE 10WA DOT STANDARD SPECIFICATIONS.

SW-506 INTAKE TO BE MODIFIED TO CONNECT THE EXISTING STORM SEWER MAIN WITH LITTLE TO NO PIPE DEFLECTION. SEE THE TABULATIONS, M, AND U SHEETS FOR FURTHER DETAILS. USE MATERIALS MEETING REQUIREMENTS OF SECTION 4119 FOR PIPE BEDDING PER SW-102 OR SW-104 AS APPROPRIATE. CERTIFIED PLANT INSPECTION SHALL BE

REQUIRED AS SPECIFIED IN SECTION 2521 OF THE IOWA DOT STANDARD SPECIFICATIONS.

1 SEE THE TABULATIONS AND M SHEETS FOR LOCATION. USE MATERIALS MEETING REQUIREMENTS OF SECTION 4119 FOR PIPE BEDDING PER SW-102 OR SW-104 AS APPROPRIATE. CEPTITETED BLANT INSPECTION SHALL BE PERIUPPED AS SPECIFIED IN SECTION 251 OF THE TOWN DOT STANDARD SPECIFICATIONS.

CERTIFIED PLANT INSPECTION SHALL BE REQUIRED AS SPECIFIED IN SECTION 2521 OF THE IOWA DOT STANDARD SPECIFICATIONS.

SW-507 INTAKE TO BE MODIFIED BY ADDING A 6-INCH TALL AND A FEET WIDE OPENING ON THE BACK SIDE OF THE INTAKE TO ALLOW WATER FROM THE FOOD CENTER'S PARKING LOT

SW-507 INTAKE TO BE MODIFIED BY ADDING A 6-INCH TALL AND 4-FEET WIDE OPENING ON THE BACK SIDE OF THE INTAKE TO ALLOW WATER FROM THE FOOD CENTER'S PARKING LOT TO DRAIN INTO THE INTAKE. SEE THE TABLATIONS, M, AND U SHEETS FOR LOCATION AND FURTHER DETAILS. USE MATERIALS MEETING REQUIREMENTS OF SECTION 4119 FOR PIPE BEDDING PER SW-102 OR SW-104 AS APPROPRIATE. CERTIFIED PLANT INSPECTION SHALL BE REQUIRED AS SPECIFIED IN SECTION 2521 OF THE IOWA DOT STANDARD SPECIFICATIONS.

NEENAH R-4215-C CONVEX DITCH GRATE, OR APPROVED EQUAL, TO BE USED FOR THE INTAKES ALONG W. MAIN STREET. SEE TABULATIONS AND M SHEETS FOR LOCATIONS. USE MATERIALS MEETING REQUIREMENTS OF SECTION 4119 FOR PIPE BEDDING PER SW-102 OR SW-104 AS APPROPRIATE. CERTIFIED PLANT INSPECTION SHALL BE REQUIRED AS SPECIFIED IN SECTION 2521 OF THE IOWA DOT STANDARD SPECIFICATIONS.

SEE TABULATIONS AND M SHEETS FOR LOCATIONS. USE MATERIALS MEETING REQUIREMENTS OF SECTION 4119 FOR PIPE BEDDING PER SW-102 OR SW-104 AS APPROPRIATE. CERTIFIED PLANT INSPECTION SHALL BE REQUIRED AS SPECIFIED IN SECTION 2521 OF THE IOWA DOT STANDARD SPECIFICATIONS.

FEHR GRALLAM

ENGINEERING & ENVIRONMENTAL

ILLINOIS IOWA WISCONSIN CITY OF FAIRBANK
116 EAST MAIN STREET
FAIRBANK, IA 50629

MAIN STREET IMPROVEMENTS FAIRBANK, IOWA BUCHANAN COUNTY STPN-281-2(10)--2J-10 DRAWN BY: AFC
APPROVED BY: JSB
DATE: 10/27/22
SCALE: AS NOTED

	REVISIONS	IONS		
REV. NO.	DESCRIPTION	DATE		

ESTIMATED PROJECT QUANTITIES AND REFERENCE NOTES

SET TYPE: BID LETTING
G:\C30\22\22-1100 Fairbank Hwy 281\Plans\22-1100 C SHEETS.dwg,

JOB NUMBER:

22-1100

SHEET NUMBER:

C.01

Item Code

2115-0100000 MODIFIED SUBBASE

2212-5075001 HOT MIX ASPHALT SURFACE PATCHES

2213-2713300 EXCAVATION, CLASS 13, FOR WIDENING

2213-8200000 BASE WIDENING, HOT MIX ASPHALT MIXTURE

2301-6911722 PORTLAND CEMENT CONCRETE PAVEMENT SAMPLES

2303-1258284 ASPHALT BINDER, PG 58-28H, HIGH TRAFFIC

2401-6745356 REMOVAL OF CONCRETE FOOTINGS OF LIGHT POLES

2303-9093010 HOT MIX ASPHALT, DRIVEWAY

2401-6745765 REMOVAL OF LIGHT POLES

2435-0250310 INTAKE, SW-503 MODIFIED

2435-0250610 INTAKE, SW-506 MODIFIED

2435-0250710 INTAKE, SW-507 MODIFIED

2435-0251110 INTAKE, SW-511 MODIFIED

2435-0250100 INTAKE, SW-501

2435-0250500 INTAKE, SW-505

2435-0250700 INTAKE, SW-507

33 2435-0251230 INTAKE, SW-512, 30 IN.

2416-0100018 APRONS, CONCRETE, 18 IN. DIA.

2435-0140148 MANHOLE, STORM SEWER, SW-401, 48 IN.

2435-0140160 MANHOLE, STORM SEWER, SW-401, 60 IN

2214-5145150 PAVEMENT SCARIFICATION

ESTIMATED PROJECT OUANTITIES AND REFERENCE NOTES

Item	Unit		Estimated		Estimate Reference Notes
		Division 1	Division 2	Total	
E ADJUSTMENT, MINOR	EACH	2	3		FOR ADJUSTMENT OF EXISTING STRUCTURES LOCATED WITHIN PROPOSED ROADWAY AND DRIVEWAY PAVING. SEE TABULATIONS, D AND L SHEETS FOR LOCATIONS AND FURTHER DETAIL. EXISTING MANHOLE CASTINGS TO BE SALVAGED FOR THE JURISDICTION TO TAKE INTO THEIR POSSESSION. REINFORCED PCC FOR BOXOUTS TO BE 9-INCHES THICK, CERTIFIED PLANT

2435-0600010 MANHOLE A INSPECTION SHALL BE REQUIRED AS SPECIFIED IN SECTION 2521 OF THE IOWA DOT STANDARD SPECIFICATIONS. 2502-8212306 SUBDRAIN, STANDARD, PERFORATED, 6 IN., AS PER PLAN LF 123.5 3,233,4 3,356.9 SEE TABULATIONS AND D AND M SHEETS FOR LOCATIONS AND ADDITIONAL INFORMATION. SUBDRAIN SHALL BE DUAL WALL HDPE WITH SLOTS OR PERFORATIONS ACCORDING TO AASHTO M 252, TYPE SP. SUBDRAIN OUTLETS SHALL BE CONNECTED TO PROPOSED STORM SEWER STRUCTURES, CONNECTIONS TO INTAKE STRUCTURES SHALL BE PAID FOR SEPARATELY UNDER

Ouantities

16

115

258

13

24

49.9

0.4

62.32

3

124.3

7,567.2

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348.1

18

64

989

1,099

195

2,069

117

12

211

35

155

315

0.6

135.36

1,411.7

4,402.1

390

BID ITEM DR-303 FOR SUBDRAIN OUTLETS. 348.1 SEE TABULATIONS AND D AND M SHEETS FOR LOCATIONS AND ADDITIONAL INFORMATION. SUBDRAIN SHALL BE DUAL WALL HOPE WITH SLOTS OR PERFORATIONS ACCORDING TO AASHTO M 252, TYPE SP. SUBDRAIN OUTLETS SHALL BE CONNECTED TO PROPOSED STORM SEWER STRUCTURES, CONNECTIONS TO INTAKE STRUCTURES SHALL BE PAID FOR SEPARATELY UNDER BID ITEM DR-303 FOR SUBDRAIN OUTLETS.

ITEM FOR CONNECTING SUBDRAIN AND DOWNSPOUT TILES TO STORM SEWER STRUCTURES, CONNECTIONS MADE TO NEW INTAKES SHALL BE COMPLETED PER IOWA DOT STANDARD

Division 1 : City of Fairbank

Division 2 : Iowa DOT

SPECIFICATION 2502 AND IONA DOT STANDARD ROAD PLAN DR-303. SUBDRAIN OUTLETS INTO DITCHES SHALL BE PAID FOR SEPARATELY UNDER THE DR-306 BID ITEM. SUBDRAIN CLEANOUTS TO BE PAID FOR SEPARATELY UNDER THE '('EACH' ITEM) SUBDRAIN CLEANOUT' BID ITEM. SEE TABULATIONS AND D AND M SHEETS FOR LOCATIONS AND ADDITIONAL ITEM ALSO FOR CORE DRILLING AND CONNECTING SUBDRAIN AND DOWNSPOUT TILES TO EXISTING OR PROPOSED RCP STORM SEWER PIPES. SOIL TIGHT CONNECTIONS TO BE MADE

INSERTA TEE CONNECTION, PREFABRICATED TEE, OR APPROVED EQUAL SHALL BE USED TO CONNECT DRAIN TILE AND STORM SEWER LATERALS TO ADJACENT PROPOSED OR EXISTING SEE TABULATIONS AND M SHEETS FOR LOCATIONS. INSULATION REQUIRED TO BE INSTALLED BETWEEN PROPOSED STORM SEWER AND EXISTING SANITARY SEWER SHALL BE INCIDENTAL

TO THE INSTALLATION OF THE STORM SEWER. C-COLLAR CONNECTIONS TO EXISTING STORM SEWER PIPES TO BE INCIDENTAL TO THE STORM SEWER PIPE INSTALLATION. USE MATERIALS MEETING REQUIREMENTS OF SECTION 4119 FOR PIPE BEDDING PER SW-102 AS APPROPRIATE. CERTIFIED PLANT INSPECTION SHALL BE REQUIRED AS SPECIFIED IN SECTION 2521 OF THE IOWA DOT STANDARD SPECIFICATIONS SEE TABULATIONS AND M SHEETS FOR LOCATIONS. INSULATION REQUIRED TO BE INSTALLED BETWEEN PROPOSED STORM SEWER AND EXISTING SANITARY SEWER SHALL BE INCIDENTAL

TO THE INSTALLATION OF THE STORM SEWER. C-COLLAR CONNECTIONS TO EXISTING STORM SEWER PIPES TO BE INCIDENTAL TO THE STORM SEWER PIPE INSTALLATION. USE MATERIALS MEETING REQUIREMENTS OF SECTION 4119 FOR PIPE BEDDING PER SW-102 AS APPROPRIATE. CERTIFIED PLANT INSPECTION SHALL BE REQUIRED AS SPECIFIED IN SECTION 2521 OF THE IOWA DOT STANDARD SPECIFICATIONS. SEE TABULATIONS AND M SHEETS FOR LOCATIONS. INSULATION REQUIRED TO BE INSTALLED BETWEEN PROPOSED STORM SEWER AND EXISTING SANITARY SEWER SHALL BE INCIDENTAL

TO THE INSTALLATION OF THE STORM SEWER, C-COLLAR CONNECTIONS TO EXISTING STORM SEWER PIPES TO BE INCIDENTAL TO THE STORM SEWER PIPE INSTALLATION, USE MATERIALS MEETING REQUIREMENTS OF SECTION 4119 FOR PIPE BEDDING PER SW-102 AS APPROPRIATE. CERTIFIED PLANT INSPECTION SHALL BE REQUIRED AS SPECIFIED IN SECTION 2521 OF THE IOWA DOT STANDARD SPECIFICATIONS.

SEE TABULATIONS AND M SHEETS FOR LOCATIONS. INSULATION REQUIRED TO BE INSTALLED BETWEEN PROPOSED STORM SEWER AND EXISTING SANITARY SEWER SHALL BE INCIDENTAL TO THE INSTALLATION OF THE STORM SEWER. C-COLLAR CONNECTIONS TO EXISTING STORM SEWER PIPES TO BE INCIDENTAL TO THE STORM SEWER PIPE INSTALLATION. USE MATERIALS MEETING REQUIREMENTS OF SECTION 4119 FOR PIPE BEDDING PER SW-102 AS APPROPRIATE. CERTIFIED PLANT INSPECTION SHALL BE REQUIRED AS SPECIFIED IN SECTION 2521 OF THE IOWA DOT STANDARD SPECIFICATIONS.

SEE TABULATIONS AND M SHEETS FOR LOCATIONS. INSULATION REQUIRED TO BE INSTALLED BETWEEN PROPOSED STORM SEWER AND EXISTING SANITARY SEWER SHALL BE INCIDENTAL THE INSTALLATION OF THE STORM SEWER. C-COLLAR CONNECTIONS TO EXISTING STORM SEWER PIPES TO BE INCIDENTAL TO THE STORM SEWER PIPE INSTALLATION. USE MATERIALS MEETING REQUIREMENTS OF SECTION 4119 FOR PIPE BEDDING PER SW-102 AS APPROPRIATE. CERTIFIED PLANT INSPECTION SHALL BE REQUIRED AS SPECIFIED IN SECTION 2521 OF THE IOWA DOT STANDARD SPECIFICATIONS.

2,069 SEE TABULATIONS AND R SHEETS FOR LOCATIONS.

SEE TABULATIONS AND R SHEETS FOR LOCATIONS.

TO BE PLACED UNDER CLASS C REVETMENT STONE AT THE STORM SEWER OUTLETS ALONG THE BANKS OF THE LITTLE WAPSIPINICON RIVER. 33% OF THE QUANTITY ALONG THE WEST 130 RIVER BANK TO BE PAID UNDER DIVISION 2 DOT, THE REMAINDER ON THE WEST BANK AND 100% OF THE QUANTITY ON THE EAST BANK TO BE PAID UNDER DIVISION 1 CITY.

TO BE PLACED AROUND THE CLASS C REVETMENT STONE AT THE STORM SEWER OUTLETS ALONG THE BANKS OF THE LITTLE WAPSIPINICON RIVER. 33% OF THE QUANTITY ALONG THE WEST RIVER BANK TO BE PAID UNDER DIVISION 2 DOT, THE REMAINDER ON THE WEST BANK AND 100% OF THE QUANTITY ON THE EAST BANK TO BE PAID UNDER DIVISION 1 CITY. ANY TEMPORARY DIVERSION OF WATER FROM THE LITTLE WAPSIPINICON RIVER REQUIRED TO ALLOW FLOWABLE MORTAR TO CURE SHALL BE INCIDENTAL TO THIS BID ITEM.

TO BE PLACED AT THE STORM SEWER OUTLETS ALONG THE BANKS OF THE LITTLE WAPSIPINICON RIVER. SEE M SHEETS FOR LOCATIONS. 33% OF THE QUANTITY ALONG THE WEST RIVER BANK TO BE PAID UNDER DIVISION 2 DOT, THE REMAINDER ON THE WEST BANK AND 100% OF THE QUANTITY ON THE EAST BANK TO BE PAID UNDER DIVISION 1 CITY. 11,969.3 FOR REMOVAL OF STREET PAVEMENTS AND SECTIONS OF CURB AND GUTTER. SEE TABULATIONS AND R SHEETS FOR LOCATIONS. CARE SHALL BE TAKEN NOT TO DAMAGE PAVEMENT THAT TO REMAIN IN PLACE, DOUBLE, FULL-DEPTH SAW CUTS ARE TO BE MADE AT REMOVAL POINTS. PAVEMENT AND CURB AND GUTTER SHALL BE REMOVED TO THE NEAREST JOINT,

UNLESS NOTED OTHERWISE. 35 SEE TABULATIONS AND R SHEETS FOR LOCATIONS. INTAKE CASTINGS TO BE SALVAGED FOR THE JURISDICTION

204.9 SEE TABULATIONS AND D AND L SHEETS FOR LOCATIONS AND ADDITIONAL INFORMATION. GUTTER SECTIONS SHALL BE 9-INCHES THICK ON THE NORTHEAST QUADRANT OF FAIRBANK WALNUT STREET, ALL OTHER CURB AND GUTTER SECTIONS ON SIDE STREETS SHALL BE 7-INCHES THICK. CERTIFIED PLANT INSPECTION SHALL BE REQUIRED AS SPECIFIED IN SECTION 2521 OF THE IOWA DOT STANDARD SPECIFICATIONS.

315 SEE TABULATIONS AND L SHEETS FOR LOCATIONS AND ADDITIONAL INFORMATION FOR DRIVEWAY ALONG 4TH STREET, SEE SIDEWALK PLANS BY OTHERS FOR ALL OTHER DRIVES. CERTIFIED PLANT INSPECTION SHALL BE REQUIRED AS SPECIFIED IN SECTION 2521 OF THE IOWA DOT STANDARD SPECIFICATIONS.

1,411.7 SEE TABULATIONS AND R SHEETS FOR LOCATIONS. CONTRACTOR SHALL PROVIDE 48-HOUR NOTICE TO PROPERTY OWNERS BEFORE REMOVING DRIVEWAYS. REPLACE DRIVEWAY PER PLAN WITHIN 10 WORKING DAYS OF BEING REMOVED.

124.3 ESTIMATED 105 IF OF HDDE SURDRAIN, SURDRAIN CLEANOUT AND SURDRAIN OUTLET FOR THE RAILROAD APPROACH SHALL BE INCLUDED IN THIS RID ITEM PER THE TOWA DOT TANDARD SPECIFICATION. ITEM ALSO TO INCLUDE FURNISHING, PLACING, AND FINISHING PCC, AS PCC WILL NOT BE PAID FOR UNDER THE PCC PAVING BID ITEM FOR RAILROAD APPROACH SECTION. CERTIFIED PLANT INSPECTION SHALL BE REQUIRED AS SPECIFIED IN SECTION 2521 OF THE IOWA DOT STANDARD SPECIFICATIONS. SEE D AND L

FOR REMOVAL AND REINSTALLATION OF SIGNS ALONG W. MAIN STREET TO PERFORM THE STORM SEWER WORK AND ALONG 4TH STREET TO PERFORM WATER MAIN AND DRIVEWAY WORK. SEE SIDEWALK PLANS BY OTHERS FOR ALL OTHER SIGNS. SEE TABULATIONS FOR LOCATIONS, METHOD OF MEASUREMENT SHALL BE FOR EACH SIGNED REMOVED TO PERFORM THE COSNTRUCTION WORK AND SET BACK AFTER COSNTRUCTION. PAYMENT SHALL BE FOR EACH SIGN THAT IS REMOVED AND RESINTALLED AND SHALL INCLUDE ALL WORK REQUIRED TO REMOVE AND REINSTALL THE SIGN. SIGNS SHALL BE CLEANED AFTER CONSTUCTION BEFORE BEING RESINSTALLED, ANY SIGNS DAMAGED DURING REMOVAL, COSNTRUCTION, OR REINSTALLATION SHALL BE REPLACED BY THE CONTRACTOR AT NO COST TO THE OWNER.

1 SEE SIDEWALK PLANS FOR SIDEWALK STAKING, PROJECT NUMBER STPN-281-2(8)--2J-10

197.68 STB6 SHALL DENOTE CURB AND GUTTER TO BE PAINTED BLUE TO INDICATE ADA ACCESSIBLE PARKING SPACES. SEE TABULATIONS AND D SHEETS FOR LOCATIONS AND MARKING TYPES 9 SEE TABULATIONS AND D SHEETS FOR LOCATIONS AND SYMBOL TYPES.

8 TO MAINTAIN SAFE ROAD CLOSERS, ANTICIPATED TO BE USED AT ROAD CLOSURES TO RESTRICT ACCESS TO HIGHWAY 281 AT 4TH STREET AND GROVE STREET, NOT FOR SIDE

TRAFFIC SIGNALS SHALL BE USED FOR STAGES 1A AND 1B. 25% OF PAYMENT SHALL BE PAID UPON THE SUCCESSFUL OPERATION OF THE SIGNALS AT THE BEGINNING OF STAGE 1A

25% OF PAYMENT SHALL BE MADE AT THE END OF STAGE 1A TO DEACTIVATE THE SIGNALS, 25% OF PAYMENT SHALL BE MADE UPON THE SUCCESSFUL OPERATION OF THE SIGNALS AT THE BEGINNING OF STAGE 1B, AND 25% OF PAYMENT SHALL BE MADE WHEN THE SIGNALS ARE REMOVED FROM THE SITE. ONE SIGNAL SHALL BE PAID FOR UNDER DIVISION 1 - CITY AND ONE UNDER DIVISION 2 - DOT 3R.

SEE SHEET J.01 FOR THE TRAFFIC CONTROL PLAN AND PROPOSED PROJECT STAGING

TRAFFIC CONTROL FOR DIVISION 1 TO COVER ITEMS FOR THE LOCAL DETOUR WITHIN THE CITY OF FAIRBANK. ITEM IS FOR SETTING UP, MAINTAINING, AND REMOVING SIGNAGE AND TRAFFIC CONTROL FOR THE DETOURS WITHIN THE CITY OF FAIRBANK FOR THE VARIOUS CONSTRUCTION STAGES, AS DENOTED BY SHEETS J.06 THROUGH J.10 FOR STAGES 1 THROUGH

TRAFFIC CONTROL FOR DIVISION 2 IS FOR SETTING UP. MAINTAINING, AND REMOVING SIGNAGE AND TRAFFIC CONTROL FOR THE STATE HIGHWAY DETOUR AROUND THE CITY OF FAIRBANK ON THE COUNTY ROADS. ITEM ALSO FOR SETTING UP, MAINTAINING, AND REMOVING ROAD CLOSURES FOR IOWA HIGHWAY 281 WITHIN THE CITY OF FAIRBANK. AS WELL AS SIGNAGE NEEDED FOR FLAGGERS TO COMPLETE SHOULDER WORK AND MILLING AND PAVING OPERATIONS ALONG WEST MAIN STREET. THE PROJECT DETOUR IS DENOTED BY SHEETS J.02 THROUGH J.05 AND SHEETS J.11 THROUGH J.14 FOR THE STORM SEWER AND SHOULDER WORK ALONG W. MAIN STREET.

FNGINFFRING & FNVIRONMENTAL

ILLINOIS IOWA WISCONSIN

CITY OF FAIRBANK 116 FAST MAIN STREET FAIRBANK, IA 50629

PROJECT AND LOCATIO MAIN STREET IMPROVEMENTS FAIRBANK, IOWA BUCHANAN COUNTY STPN-281-2(10)--2J-10

DRAWN BY: AFC APPROVED BY: JSB DATE: 10/27/22 SCALE: AS NOTED

\subseteq	REVISIONS	
REV. NO.	DESCRIPTION	DATE
\Box		

ESTIMATED PROJECT QUANTITIES AND REFERENCE NOTES

SET TYPE: BID LETTING

JOB NUMBER 22-1100 SHEET NUMBER

C.02

Item

no.

45

48

49

51

59

Item Code

2502-8212406 SUBDRAIN, STANDARD, NON-PERFORATED, 6 IN., AS PER PLAN

2503-0200036 REMOVE STORM SEWER PIPE LESS THAN OR EQUAL TO 36 IN.

2507-4011100 CONCRETE GROUT FOR REVETMENT OR GABION

2510-6750600 REMOVAL OF INTAKES AND UTILITY ACCESSES

2512-1725256 CURB AND GUTTER, P.C. CONCRETE, 2.5 FT.

2515-2475008 DRIVEWAY, P.C. CONCRETE, 8 IN.

2517-4225210 RAILROAD APPROACH SECTION, P.C.C.

2524-6765010 REMOVE AND REINSTALL SIGN AS PER PLAN

2527-9263109 PAINTED PAVEMENT MARKING, WATERBORNE OR SOLVENT-BASED

2527-9263137 PAINTED SYMBOLS AND LEGENDS, WATERBORNE OR SOLVENT-BASED

2515-6745600 REMOVAL OF PAVED DRIVEWAY

2520-3350015 FIELD OFFICE

2526-8285000 CONSTRUCTION SURVEY

2528-8400256 TEMPORARY TRAFFIC SIGNALS

2528-2518000 SAFETY CLOSURE

2528-8445110 TRAFFIC CONTROL

2503-0114212 STORM SEWER GRAVITY MAIN, TRENCHED, REINFORCED CONCRETE PIPE (RCP), 2000D (CLASS III), 12 IN.

2503-0114215 STORM SEWER GRAVITY MAIN, TRENCHED, REINFORCED CONCRETE PIPE (RCP), 2000D (CLASS III), 15 IN.

2503-0114218 STORM SEWER GRAVITY MAIN, TRENCHED, REINFORCED CONCRETE PIPE (RCP), 2000D (CLASS III), 18 IN.

2503-0114224 STORM SEWER GRAVITY MAIN, TRENCHED, REINFORCED CONCRETE PIPE (RCP), 2000D (CLASS III), 24 IN.

2503-0114230 STORM SEWER GRAVITY MAIN, TRENCHED, REINFORCED CONCRETE PIPE (RCP), 2000D (CLASS III), 30 IN.

2503-0200341 STORM SEWER ABANDONMENT, FILL AND PLUG, LESS THAN OR EQUAL TO 36 IN. DIA.

2502-8221303 SUBDRAIN OUTLET, DR-303

2507-3250005 ENGINEERING FABRIC

2507-6800032 REVETMENT, CLASS C

2510-6745850 REMOVAL OF PAVEMENT

Division 1 : City of Fairbank ESTIMATED PROJECT QUANTITIES AND REFERENCE NOTES Division 2 : Iowa DOT Quantities Item Item Code Item Unit **Estimate Reference Notes Estimated** no. Division 1 Division 2 2528-8445113 FLAGGERS EACH SEE PROPOSAL. ITEM IS FOR THE USE OF FLAGGERS ALONG W. MAIN STREET DURING STORM SEWER AND SHOULDER WORK PER TC-213. TRAFFIC CONTROL TO BE SET UP DURING THE WORKING DAY TO REDUCE TRAFFIC TO ONE LANE AND REMOVED AT THE END OF EACH WORKING DAY TO ALLOW TWO-WAY TRAFFIC UNTIL THE START OF THE NEXT WORKING DAY. ONE LANE ROAD CLOSURES ALONG W. MAIN TO BE BROKEN INTO TWO SEGMENTS AS TO REDUCE THE AMOUNT OF ONE LANE ROAD TO ONLY BE WITHIN THE AREA OF CONSTRUCTION FOR THE GIVEN WORK DAY. FLAGGERS ALSO TO BE USED DURING MILLING AND ASPHALT PAVING OPERATIONS ALONG W. MAIN STREET. FLAGGERS NEEDED FOR STORM SEWER WORK ALONG THE SOUTH SIDE OF W. MAIN STREET SHALL BE PAID UNDER DIVISION 1 - CITY. THE REMAINDER OF FLAGGERS REQUIRED FOR SHOULDER AND PAVING WORK SHALL BE PAID FOR UNDER EACH 2528-8445115 PILOT CARS 0 SEE PROPOSAL. ITEM TO BE USED DURING MILLING AND ASPHALT PAVING OPERATIONS ALONG W. MAIN STREET CDAY TWO SIGNS SHALL BE PROVIDED. ONE SIGN SHALL BE PLACED AT EACH END OF THE PROJECT. SIGNS SHALL BE IN PLACE AND OPERATIONAL A MINIMUM OF 7 DAYS PRIOR TO 2528-9290050 PORTABLE DYNAMIC MESSAGE SIGN (PDMS) CLOSURE OF 10WA 281. SIGNS ARE TO NOTIFY MOTORISTS OF UPCOMING CONSTRUCTION OF 10WA 281 IN FAIRBANK. SIGNS SHALL READ, "281 CLOSED IN FAIRBANK MONTH DAY'", 2533-4980005 MOBILIZATION LS 0.6 0.4 2552-0000300 TRENCH COMPACTION TESTING LS CONTRACTOR RESPONSIBLE FOR PROVIDING TRENCH COMPACTION TESTING RESULTS TO THE ENGINEER FOR WATER MAIN AND STORM SEWER TRENCHES LOCATED UNDER THE PAVED ROAD PRIOR TO BEGINNING PAVING OPERATIONS. TRENCH COMPACTION TESTING IS NOT REQUIRED ON CITY SIDE STREETS OR IN DITCHES AND OTHER AREAS BEHIND BACK OF CURB. 2554-0112004 WATER MAIN, TRENCHED, DUCTILE IRON PIPE (DIP), 4 IN. LF SEE TABULATIONS AND M SHEETS FOR LOCATIONS. NITRILE GASKETS AND V-BIO ENHANCED POLYETHYLENE ENCASEMENT WRAP WITH A MINIMUM THICKNESS OF 8 MIL TO BE USED ON ALL DUCTILE TRON PIPE. FITTINGS. AND APPURTENANCES TO PREVENT CONTACT RETWEEN THE PIPE AND REDDING MATERIAL. BUT NEED NOT BE ATRITIGHT OR WATERITIGHT. REPAIR ALL CUTS AND TEARS AND INSTALL IN ACCORDANCE WITH AWWA C105. ANY INSULATION REQUIRED TO BE PLACED AROUND THE PROPOSED WATER MAIN SHALL BE INCIDENTAL TO THE INSTALLATION OF THE WATER MAIN, USE MATERIALS MEETING REQUIREMENTS OF SECTION 4119 FOR CLASS P-1 PIPE REDDING IN A DRY TRENCH PER SW-104 AS APPROPRIATE. IN THE CASE OF A WET TRENCH, CLASS P-2 BEDDING SHALL BE USED PER SW-104, CLASS I BEDDING MATERIAL SHALL BE IOWA DOT GRADATION NO. 3 AND SHALL BE USED IN A WET TRENCH. THE REMAINDER OF THE TRENCH BACKFILL FOR THE HAUNCH SUPPORT, PRIMARY BACKFILL, SECONDARY BACKFILL, AND FINAL TRENCH BACKFILL UP TO THE BOTTOM OF PAVEMENT SUBGRADE PER SW-101 SHALL BE EXISTING MATERIALS REMOVED FROM THE TRENCH. EXISTING MATERIALS ARE EXPECTED TO BE SUITABLE FOR BACKFILL. SEE TABULATIONS AND M SHEETS FOR LOCATIONS. NITRILE GASKETS AND V-BIO ENHANCED POLYETHYLENE ENCASEMENT WRAP WITH A MINIMUM THICKNESS OF 8 MIL TO BE USED ON LF 238 2554-0112006 WATER MAIN, TRENCHED, DUCTILE IRON PIPE (DIP), 6 IN. ALL DUCTILE IRON PIPE, FITTINGS, AND APPURTENANCES TO PREVENT CONTACT BETWEEN THE PIPE AND BEDDING MATERIAL, BUT NEED NOT BE AIRTIGHT OR WATERTIGHT. REPAIR ALL CUTS AND TEARS AND INSTALL IN ACCORDANCE WITH AWWA C105. ANY INSULATION REQUIRED TO BE PLACED AROUND THE PROPOSED WATER MAIN SHALL BE INCIDENTAL TO THE INSTALLATION OF THE WATER MAIN. USE MATERIALS MEETING REQUIREMENTS OF SECTION 4119 FOR CLASS P-1 PIPE BEDDING IN A DRY TRENCH PER SW-104 AS APPROPRIATE. IN THE CASE OF A WET TRENCH, CLASS P-2 BEDDING SHALL BE USED PER SW-104, CLASS I BEDDING MATERIAL SHALL BE IOWA DOT GRADATION NO. 3 AND SHALL BE USED IN A WET TRENCH. THE REMAINDER OF THE TRENCH BACKFILL FOR THE HAUNCH SUPPORT, PRIMARY BACKFILL, SECONDARY BACKFILL, AND FINAL TRENCH BACKFILL UP TO THE BOTTOM OF PAVEMENT SUBGRADE PER SW-101 SHALL BE EXISTING MATERIALS REMOVED FROM THE TRENCH. EXISTING MATERIALS ARE EXPECTED TO BE SUITABLE FOR BACKFILL. 2554-0112008 WATER MAIN, TRENCHED, DUCTILE IRON PIPE (DIP), 8 IN. LF 8 SEE TABULATIONS AND M SHEETS FOR LOCATIONS. NITRILE GASKETS AND V-BIO ENHANCED POLYETHYLENE ENCASEMENT WRAP WITH A MINIMUM THICKNESS OF 8 MIL TO BE USED ON ALL DUCTILE IRON PIPE, FITTINGS, AND APPURTENANCES TO PREVENT CONTACT BETWEEN THE PIPE AND BEDDING MATERIAL, BUT NEED NOT BE AIRTIGHT OR WATERTIGHT. REPAIR ALL CUTS AND TEARS AND INSTALL IN ACCORDANCE WITH AWWA C105. ANY INSULATION REQUIRED TO BE PLACED AROUND THE PROPOSED WATER MAIN SHALL BE INCIDENTAL INSTALLATION OF THE WATER MAIN, USE MATERIALS MEETING REQUIREMENTS OF SECTION 4119 FOR CLASS P-1 PIPE BEDDING IN A DRY TRENCH PER SW-104 AS APPROPRIATE. IN THE CASE OF A WET TRENCH, CLASS P-2 BEDDING SHALL BE USED PER SW-104, CLASS I BEDDING MATERIAL SHALL BE IOWA DOT GRADATION NO. 3 AND SHALL BE USED IN A WET TRENCH. THE REMAINDER OF THE TRENCH BACKFILL FOR THE HAUNCH SUPPORT, PRIMARY BACKFILL, SECONDARY BACKFILL, AND FINAL TRENCH BACKFILL UP TO THE BOTTOM OF PAVEMENT SUBGRADE PER SW-101 SHALL BE EXISTING MATERIALS REMOVED FROM THE TRENCH. EXISTING MATERIALS ARE EXPECTED TO BE SUITABLE FOR BACKFILL. LF SEE TABULATIONS AND M SHEETS FOR LOCATIONS. NITRILE GASKETS AND V-BIO ENHANCED POLYETHYLENE ENCASEMENT WRAP WITH A MINIMUM THICKNESS OF 8 MIL TO BE USED ON 2554-0112010 WATER MAIN, TRENCHED, DUCTILE IRON PIPE (DIP), 10 IN. 1,691 DUCTILE IRON PIPE, FITTINGS, AND APPURTENANCES TO PREVENT CONTACT BETWEEN THE PIPE AND BEDDING MATERIAL, BUT NEED NOT BE AIRTIGHT OR WATERTIGHT. REPAIR ALL CUTS AND TEARS AND INSTALL IN ACCORDANCE WITH AWWA C105. ANY INSULATION REQUIRED TO BE PLACED AROUND THE PROPOSED WATER MAIN SHALL BE INCIDENTAL TO THE INSTALLATION OF THE WATER MAIN. USE MATERIALS MEETING REQUIREMENTS OF SECTION 4119 FOR CLASS P-1 PIPE BEDDING IN A DRY TRENCH PER SW-104 AS APPROPRIATE. IN THE CASE OF A WET TRENCH, CLASS P-2 BEDDING SHALL BE USED PER SW-104, CLASS I BEDDING MATERIAL SHALL BE IOWA DOT GRADATION NO. 3 AND SHALL BE USED IN A WET TRENCH. THE REMAINDER OF THE TRENCH BACKFILL FOR THE HAUNCH SUPPORT, PRIMARY BACKFILL, SECONDARY BACKFILL, AND FINAL TRENCH BACKFILL UP TO THE BOTTOM OF PAVEMENT SUBGRADE PER SW-101 SHALL BE EXISTING MATERIALS REMOVED FROM THE TRENCH. EXISTING MATERIALS ARE EXPECTED TO BE SUITABLE FOR BACKFILL 2554-0203000 FITTINGS BY WEIGHT, DUCTILE IRON LB 1,840 SEE TABULATIONS, D, AND U SHEETS FOR LOCATIONS, BID WEIGHTS BY FITTING, AND CONNECTION DETAILS. INSTALL MJ RETAINER GLANDS WHERE SHOWN ON THE U SHEETS FOR FITTINGS SUBJECT TO THRUST, NOT TO BE INSTALLED ON PLAIN CAST IRON PIPE. MJ RETAINER GLANDS SHALL BE INCIDENTAL TO THIS BID ITEM AND NOT PAID FOR SEPARATELY. TEE BOLTS AND HEXAGONAL NUTS FOR MECHANICAL JOINTS SHALL BE STAINLESS STEEL OR "COR-BLUE", ALL OTHER BOLT AND NUTS SHALL BE STAINLESS STEEL. GRIPPING WEDGE-STYLE RESTRAINT GLANDS (EBAA MEGA-LUG, TYLER UNION TUF-GRIP, ETC.) SHALL NOT BE USED ON PLAIN-END DUCTILE IRON FITTINGS PER MANUFACTURER 2554-0205110 WATER SERVICE STUB, COPPER, 1 IN. LF SEE TABULATIONS AND M SHEETS FOR LOCATIONS. USE MATERIALS MEETING REQUIREMENTS OF SECTION 4119 FOR CLASS P-1 PIPE BEDDING IN A DRY TRENCH PER SW-104 AS 853 APPROPRIATE. EXISTING MATERIALS ARE EXPECTED TO BE SUITABLE FOR BACKFILL, ANY ROCK ENCOUNTERED LARGER THAN 4-INCHES SHALL NOT BE PLACED BACK IN THE TRENCH. IN THE CASE OF A WET TRENCH, CLASS P-2 BEDDING SHALL BE USED PER SW-104, CLASS I BEDDING MATERIAL SHALL BE IOWA DOT GRADATION NO. 3 AND SHALL BE USED IN A WET TRENCH. THE REMAINDER OF THE TRENCH BACKFILL FOR THE HAUNCH SUPPORT, PRIMARY BACKFILL, SECONDARY BACKFILL, AND FINAL TRENCH BACKFILL UP TO THE BOTTOM OF PAVEMENT SUBGRADE PER SW-101 SHALL BE EXISTING MATERIALS REMOVED FROM THE TRENCH. 51 SEE TABULATIONS AND M SHEETS FOR LOCATIONS. USE MATERIALS MEETING REQUIREMENTS OF SECTION 4119 FOR CLASS P-1 PIPE BEDDING IN A DRY TRENCH PER SW-104 AS APPROPRIATE. EXISTING MATERIALS ARE EXPECTED TO BE SUITABLE FOR BACKFILL, ANY ROCK ENCOUNTERED LARGER THAN 4-INCHES SHALL NOT BE PLACED BACK IN THE TRENCH. 2554-0205120 WATER SERVICE STUB, COPPER, 2 IN. LF 51 IN THE CASE OF A WET TRENCH, CLASS P-2 BEDDING SHALL BE USED PER SW-104, CLASS I BEDDING MATERIAL SHALL BE IOWA DOT GRADATION NO. 3 AND SHALL BE USED IN A WET TRENCH. THE REMAINDER OF THE TRENCH BACKFILL FOR THE HAUNCH SUPPORT, PRIMARY BACKFILL, SECONDARY BACKFILL, AND FINAL TRENCH BACKFILL UP TO THE BOTTOM OI PAVEMENT SUBGRADE PER SW-101 SHALL BE EXISTING MATERIALS REMOVED FROM THE TRENCH. 2554-0205410 WATER SERVICE CORPORATION, COPPER, 1 IN. EACH SEE TABULATIONS AND M SHEETS FOR LOCATIONS. USE MATERIALS MEETING REQUIREMENTS OF SECTION 4119 FOR CLASS P-1 PIPE BEDDING IN A DRY TRENCH PER SW-104 AS 31 APPROPRIATE. EXISTING MATERIALS ARE EXPECTED TO BE SUITABLE FOR BACKFILL, ANY ROCK ENCOUNTERED LARGER THAN 4-INCHES SHALL NOT BE PLACED BACK IN THE TRENCH. IN THE CASE OF A WET TRENCH, CLASS P-2 BEDDING SHALL BE USED PER SW-104, CLASS I BEDDING MATERIAL SHALL BE IOWA DOT GRADATION NO. 3 AND SHALL BE USED IN A WET TRENCH. THE REMAINDER OF THE TRENCH BACKFILL FOR THE HAUNCH SUPPORT, PRIMARY BACKFILL, SECONDARY BACKFILL, AND FINAL TRENCH BACKFILL UP TO THE BOTTOM OF PAVEMENT SUBGRADE PER SW-101 SHALL BE EXISTING MATERIALS REMOVED FROM THE TRENCH. FACH 1 SEE TABILIATIONS AND M SHEETS FOR LOCATIONS, USE MATERIALS MEETING REQUIREMENTS OF SECTION 4119 FOR CLASS P-1 PIPE REDDING IN A DRY TRENCH PER SW-104 AS 2554-0205420 WATER SERVICE CORPORATION, COPPER, 2 IN. APPROPRIATE. EXISTING MATERIALS ARE EXPECTED TO BE SUITABLE FOR BACKFILL, ANY ROCK ENCOUNTERED LARGER THAN 4-INCHES SHALL NOT BE PLACED BACK IN THE TRENCH. IN THE CASE OF A WET TRENCH, CLASS P-2 BEDDING SHALL BE USED PER SW-104, CLASS I BEDDING MATERIAL SHALL BE IOWA DOT GRADATION NO. 3 AND SHALL BE USED IN A WET TRENCH. THE REMAINDER OF THE TRENCH BACKFILL FOR THE HAUNCH SUPPORT, PRIMARY BACKFILL, SECONDARY BACKFILL, AND FINAL TRENCH BACKFILL UP TO THE BOTTOM OF PAVEMENT SUBGRADE PER SW-101 SHALL BE EXISTING MATERIALS REMOVED FROM THE TRENCH. 2554-0205710 WATER SERVICE CURB STOP AND BOX, COPPER, 1 IN. EACH SEE TABULATIONS AND M SHEETS FOR LOCATIONS. USE MATERIALS MEETING REQUIREMENTS OF SECTION 4119 FOR CLASS P-1 PIPE BEDDING IN A DRY TRENCH PER SW-104 AS 30 APPROPRIATE. EXISTING MATERIALS ARE EXPECTED TO BE SUITABLE FOR BACKFILL, ANY ROCK ENCOUNTERED LARGER THAN 4-INCHES SHALL NOT BE PLACED BACK IN THE TRENCH IN THE CASE OF A WET TRENCH, CLASS P-2 BEDDING SHALL BE USED PER SW-104, CLASS I BEDDING MATERIAL SHALL BE IOWA DOT GRADATION NO. 3 AND SHALL BE USED IN A WET TRENCH. THE REMAINDER OF THE TRENCH BACKFILL FOR THE HAUNCH SUPPORT, PRIMARY BACKFILL, SECONDARY BACKFILL, AND FINAL TRENCH BACKFILL UP TO THE BOTTOM OF PAVEMENT SUBGRADE PER SW-101 SHALL BE EXISTING MATERIALS REMOVED FROM THE TRENCH. 1 SEE TABULATIONS AND M SHEETS FOR LOCATIONS. USE MATERIALS MEETING REQUIREMENTS OF SECTION 4119 FOR CLASS P-1 PIPE BEDDING IN A DRY TRENCH PER SW-104 AS 2554-0205720 WATER SERVICE CURB STOP AND BOX, COPPER, 2 IN. EACH APPROPRIATE. EXISTING MATERIALS ARE EXPECTED TO BE SUITABLE FOR BACKFILL, ANY ROCK ENCOUNTERED LARGER THAN 4-INCHES SHALL NOT BE PLACED BACK IN THE TRENCH. IN THE CASE OF A WET TRENCH, CLASS P-2 BEDDING SHALL BE USED PER SW-104, CLASS I BEDDING MATERIAL SHALL BE IOWA DOT GRADATION NO. 3 AND SHALL BE USED IN A WET TRENCH. THE REMAINDER OF THE TRENCH BACKFILL FOR THE HAUNCH SUPPORT, PRIMARY BACKFILL, SECONDARY BACKFILL, AND FINAL TRENCH BACKFILL UP TO THE BOTTOM OF PAVEMENT SUBGRADE PER SW-101 SHALL BE EXISTING MATERIALS REMOVED FROM THE TRENCH. 2554-0207004 VALVE, GATE, DIP, 4 IN. EACH SEE TABULATIONS AND M SHEETS FOR LOCATIONS. ALL WATER VALVES TO BE WATEROUS OR MUELLER MANUFACTURERS ONLY. USE MATERIALS MEETING REQUIREMENTS OF SECTION 4119 FOR CLASS P-1 PIPE BEDDING IN A DRY TRENCH PER SW-104 AS APPROPRIATE. EACH 4 SEE TABULATIONS AND M SHEETS FOR LOCATIONS. ALL WATER VALVES TO BE WATEROUS OR MUELLER MANUFACTURERS ONLY. USE MATERIALS MEETING REQUIREMENTS OF SECTION 4119 2554-0207006 VALVE, GATE, DIP, 6 IN. FOR CLASS P-1 PIPE BEDDING IN A DRY TRENCH PER SW-104 AS APPROPRIATE. 2554-0207010 VALVE, GATE, DIP, 10 IN. EACH SEE TABULATIONS AND M SHEETS FOR LOCATIONS. ALL WATER VALVES TO BE WATEROUS OR MUELLER MANUFACTURERS ONLY. USE MATERIALS MEETING REQUIREMENTS OF SECTION 4119 8 FOR CLASS P-1 PIPE BEDDING IN A DRY TRENCH PER SW-104 AS APPROPRIATE. 2554-0210201 FIRE HYDRANT ASSEMBLY, WM-201 EACH SEE TABULATIONS AND M SHEETS FOR LOCATIONS. ALL FIRE HYDRANTS TO BE WATEROUS OR MUELLER MANUFACTURERS ONLY. ANCHOR TEES SHALL BE USED FOR FIRE HYDRANT ASSEMBLIES WITH THE LEAD VALVE ATTACHED TO THE TEE. USE MATERIALS MEETING REQUIREMENTS OF SECTION 4119 FOR CLASS P-1 PIPE BEDDING IN A DRY TRENCH PER SW-104



ILLINOIS IOWA WISCONSIN owner/developer:
CITY OF FAIRBANK
116 EAST MAIN STREET
FAIRBANK, IA 50629

PROJECT AND LOCATION:

MAIN STREET IMPROVEMENTS
FAIRBANK, IOWA
BUCHANAN COUNTY
STPN-281-2(10)--2J-10

DRAWN BY: AFC APPROVED BY: JSB DATE: 10/27/22 SCALE: AS NOTED

REVISIONS											
REV. NO.	DESCRIPTION										

DRAWING: ESTIMATED PROJECT QUANTITIES AND REFERENCE NOTES

SET TYPE: BID LETTING

G:\C30\22\22-1100 Fairbank Hwy 281\Plans\22-1100 C SHEETS.dwg,

JOB NUMBER: 22-1100

SHEET NUMBER:

ESTIMATED PROJECT QUANTITIES AND REFERENCE NOTES

							4 1
em	Item Code Item	Unit		Estimated		Estimate Reference Notes	41
•			Division 1	Division 2	Total		41
2	2554-0210205 FIRE HYDRANT ASSEMBLY REMOVAL	EACH	5			SEE TABULATIONS AND R SHEETS FOR LOCATIONS. EXISTING FIRE HYDRANT ASSEMBLIES TO BE REMOVED AND SALVAGED FOR THE JURISDICTION. BOLLARDS NEAR FIRE HYDRANTS TO BE REMOVED AND SALVAGED FOR THE JURISDICTION AND SHALL BE INCLUDED AS PART OF THIS BID ITEM.	
3	2554-0212040 VALVE BOX ADJUSTMENT, MINOR	EACH		5		ITEM FOR ADJUSTING AND BOXING OUT EXISTING WATER VALVES IN HMA PAVEMENT. THE BOXOUT FOR WATER VALVES SHALL CONSIST OF AN 18-INCH DIAMETER PCC BOXOUT CENTERED OVER THE WATER VALVE BOX. THE PCC SHALL BE 9-INCHES THICK AND REINFORCED WITH TWO #4 REBAR HOOPS, WHICH SHALL BE PLACED AT MID-SLAB, SIMILAR TO THAT OF A MANHOLE BOXOUT PER IOWA DOT STANDARD ROAD PLAN PV-201.	

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2 EXISTING VALVE BOXES LOCATED ON THE EXISTING WATER MAIN TO BE ABANDONED SHALL BE REMOVED DOWN TO THE PAVEMENT SUBGRADE.

REFER TO SPECIAL PROVISIONS.

METHOD OF MEASUREMENT TO BE FOR EACH LOCATION TO DISCONNECT THE EXISTING WATER MAIN AND CONNECT THE NEW WATER MAIN. REGARDLESS OF SIZE AND MATERIAL. PAYMENT SHALL BE FOR EACH WATER MAIN CONNECTION MADE AND SHALL INCLUDE ALL LABOR AND MATERIALS REQUIRED FOR THE WATER MAIN CONNECTION INCLUDING, BUT NOT LIMITED TO, SAW CUTTING THE EXISTING WATER MAIN PIPE, AND BEDDING MATERIAL TO MAINTAIN A DRY TRENCH. COMMUNICATE WITH CITY STAFF TO COORDINATE WATER MAIN CONNECTIONS AND PROPERTY OWNER NOTIFICATION.

Division 1 : City of Fairbank

Division 2 : Iowa DOT

CONCRETE FOOTING TO BE TNSTALLED PER SUDAS SECTION 4030,221 FOR AN RCP APRON SECTION FOOTING, METHOD OF MEASUREMENT TO BE BY EACH CONCRETE FOOTING POLICED, OR PRECAST FOOTING INSTALLED. PAYMENT SHALL BE FULL COMPENSATION FOR ALL LABOR AND MATERIALS REQUIRED TO POUR THE CONCRETE FOOTING, OR PLACE THE PRECAST FOOTING, INCLUDING, BUT NOT LIMITED TO, EXCAVATION, REBAR, CONCRETE, LABOR, AND MATERIALS REQUIRED TO INSTALL THE FOOTING.

ITEM IS FOR 6-INCH SUBDRAIN CLEANOUT TO BE INSTALLED AT THE BRIDGE APPROACH, WEST SIDE OF GROVE STREET, AND THE NORTH SIDE OF GROVE STREET EAST OF 4TH STREET. SEE TABULATIONS AND D AND M SHEETS FOR LOCATIONS. SUBDRAIN CLEANOUT FOR THE RAILROAD APPROACH TO BE PAID UNDER THE 'RAILROAD APPROACH SECTION, P.C.C.' ITEM. SUBDRAIN CLEANOUT TO BE INSTALLED PER SUDAS 4040.232 TYPE A-2 CLEANOUT. METHOD OF MEASUREMENT TO BE BY EACH CLEANOUT INSTALLED. PAYMENT SHALL BE FULL COMPENSATION FOR ALL LABOR AND MATERIALS REQUIRED TO INSTALL THE CLEANOUT INCLUDING, BUT NOT LIMITED TO, ANY PVC PIPE, FITTINGS, ELBOWS, AND PVC SCREW CAP.

METHOD OF MEASUREMENT TO BE BY EACH WATER SERVICE REDUCER INSTALLED. PAYMENT SHALL BE FULL COMPENSATION FOR ALL LABOR AND MATERIALS REQUIRED TO CONNECT THE REDUCER TO THE PROPOSED 1 IN. COPPER WATER SERVICE AND EXISTING 3/4 IN. WATER SERVICE. EXISTING WATER SERVICE MATERIALS ARE UNKNOWN AND MAY VARY, NO ADDITIONAL PAYMENT SHALL BE MADE BASED ON EXISTING WATER SERVICE MATERIAL.

METHOD OF MEASUREMENT TO BE FOR EACH HOUR OF EXPLORATORY EXCAVATION AS SHOWN ON THE PLANS OR APPROVED BY THE ENGINEER. PAYMENT SHALL BE FULL COMPENSATION FOR EXPLORATORY EXCAVATION WITH A VACIUM TRICK OR MINT EXCAVATOR AND SUBSIDIARY LABOR AND MATERIALS, PAYMENT WILL BE MADE TO THE NEAREST ONE-HALE HOUR. LOCATING UTILITY LINES SHOWN ON THE PLANS AND AS MARKED BY IOWA ONE CALL WILL NOT BE COVERED UNDER THIS BID ITEM, UNLESS NOTED OTHERWISE ON THE PLANS, THIS WORK SHALL BE CONSIDERED INCIDENTAL TO THE MAJOR WORK BEING COMPLETED.

ITEM IS FOR THE WATER SERVICE ALONG E. MAIN STREET TO BE BORED TO THE BASEMENT OF THE BUILDING AT CITY HALL. THIS ITEM SHALL ALSO BE USED IF THERE ARE ANY OTHER REQUESTS TO INSTALL WATER SERVICES INTO BUILDINGS DURING CONSTRUCTION, NO OTHERS ARE KNOWN AT THIS TIME. METHOD OF MEASUREMENT AND PAYMENT SHALL BE BY LINEAR FEET ALONG THE CENTERLINE OF THE PIPE FOR EACH TYPE AND SIZE OF WATER SERVICE PIPE THAT IS INSTALLED USING TRENCHLESS CONSTRUCTION. ITEM SHALL INCLUDES ALL MATERIALS, EQUIPMENT AND LABOR REQUIRED TO RUN THE WATER SERVICE PIPE AND HIGH TENSILE TRACER WIRE THROUGH THE BASEMENT FOUNDATION WALL AND TO THE PROPER LOCATION INSIDE THE BUILDING. OWNER IS RESPONSIBLE FOR MAKING THE CONNECTION INSIDE THE BUILDING. SEE TABULATIONS AND M SHEETS FOR LOCATIONS. METHOD OF MEASUREMENT SHALL BE BY LUMP SUM TO PROVIDE, PLACE, AND MAKE THE PROPOSED LIGHTING SYSTEM FULLY FUNCTIONAL. PAYMENT SHALL BE FULL COMPENSATION FOR LABOR, EQUIPMENT, AND MATERIALS REQUIRED TO INSTALL THE LIGHTING SYSTEM, CONTRACTOR TO VERIFY DEPTHS AND LOCATIONS OF EXISTING AND PROPOSED UNDERGROUND UTILITIES PRIOR TO ANY BORING OPERATIONS. UNDERGROUND CONDUIT EXPECTED TO BE PLACED AT A DEPTH OF 2 TO 3-FEET, DEPTH MAY VARY DEPENDING ON LOCATIONS OF OTHER UNDERGROUND UTILITIES. SEE SPECIAL PROVISIONS FOR ADDITIONAL INFORMATION.

SEE TABULATIONS AND EC SHEETS FOR LOCATIONS.

493 SEE TABULATIONS AND EC SHEETS FOR LOCATIONS

SEE TABULATIONS AND EC SHEETS FOR LOCATIONS. ITEM TO BE INSTALLED AS SOON AS CONSTRUCTION BEGINS IN THE AREA OF THE INTAKE, OR INTAKE CONSTRUCTION IS 16

ITEM TO BE REMOVED ONLY WHEN THE SURROUNDING AREA HAS ACHIEVED 70% GROWTH, OR WHEN PAVEMENT SCARIFICATION, PAVEMENT CONSTRUCTION, AND SIDEWALK CONSTRUCTION 2 OPERATIONS ARE COMPLETE.

SEE TABULATIONS AND EC SHEETS FOR LOCATIONS. ITEM TO BE INSTALLED AS SOON AS CONSTRUCTION BEGINS IN THE AREA OF THE INTAKE, OR INTAKE CONSTRUCTION IS COMPLETE. METHOD OF MEASUREMENT SHALL BE BY COUNT FOR EACH GRATE INTAKE SEDIMENT FILTER BAG THAT IS INSTALLED. INSTALLATION OF SEDIMENT FILTER BAGS IN DOUBLE GRATE INTAKES SHALL COUNT AS THE INSTALLATION OF ONE (1) FILTER BAG PER EACH INTAKE. PAYMENT SHALL BE FULL COMPENSATION FOR ALL LABOR, EQUIPMENT, AND MATERIALS REQUIRED TO INSTALL THE GRATE INTAKE SEDIMENT FILTER BAGE. NO PAYMENT SHALL BE GIVEN IF SILT FENCE FABRIC IS INSTALLED INSTEAD OF A GRATE INTAKE

METHOD OF MEASUREMENT TO BE BY COUNT, PAYMENT SHALL BE FOR FACH OCCURRENCE SEDIMENT OR OTHER DERRIS IS CLEANED OUT OF A GRATE INTAKE SEDIMENT FILTER BAG WHEN IT REACHES A CAPACITY OF 50% OR MORE. PAYMENT IS FULL COMPENSATION FOR CLEAN OUT, PROPER DISPOSAL OF ANY SEDIMENT OR DEBRIS, ANY NEEDED REPAIR OR REPLACEMENT OF THE GRATE INTAKE SEDIMENT FILTER BAG, AND REINSTALLATION OF THE GRATE INTAKE SEDIMENT FILTER BAG. MAINTENANCE IS ESTIMATED TO BE ONE CLEANING PER EACH

ITEM TO BE REMOVED ONLY WHEN THE SURROUNDING AREA HAS ACHIEVED 70% GROWTH, OR WHEN PAVEMENT SCARIFICATION, PAVEMENT CONSTRUCTION, AND SIDEWALK CONSTRUCTION OPERATIONS ARE COMPLETE. METHOD OF MEASUREMENT SHALL BE BY COUNTY FOR EACH GRATE INTAKE SEDIMENT FILTER BAG IS REMOVED, REMOVAL OF SEDIMENT FILTER BAGS IN DOUBLE GRATE INTAKES SHALL COUNT AS THE REMOVAL OF ONE (1) FILTER BAG PER EACH INTAKE. PAYMENT SHALL BE FULL COMPENSATION FOR ALL LABOR AND EQUIPMENT REQUIRED FOR REMOVAL OF THE GRATE INTAKE SEDIMENT FILTER BAG.

PROJECT DESCRIPTION

This Data Entry Sheet fills Tab 100-1D effective 10-18-05

PROJECT INCLUDES STREET, UNDERGROUND UTILITY, AND SIDEWALK IMPROVEMENTS ALONG HIGHWAY 281 THROUGH THE CITY OF FAIRBANK, IOWA. THE PROJECT BEGINS ON FAIRBANK STREET WITH HMA MILL AND OVERLAY OPERATIONS PROCEEDING EAST TO THE LITTLE WAPSIPINICON RIVER BRIDGE. PROCEEDING EAST OF THE BRIDGE ON EAST MAIN STREET, SOUTH ON 4TH STREET AND EAST ON GROVE STREET TO THE IOWA NORTHERN RAILWAY. THE EXISTING STREET WILL BE RECONSTRUCTED WITH PCC. STORM SEWER IMPROVEMENTS WILL BE MADE ALONG THE SOUTH SIDE OF WEST MAIN STREET INCLUDING THE ADDITION OF STORM SEWER PIPES AND INTAKES. STORM SEWER AND WATER MAIN IMPROVEMENTS WILL ALSO BE MADE ALONG EAST MAIN STREET AND 4TH STREET. THE EXISTING STREET LIGHTS ALONG EAST MAIN STREET ARE TO BE REMOVED AND REPLACED WITH A DECORATIVE LIGHTING SYSTEM. SIDEWALK IMPROVEMENTS WILL ALSO BE MADE THROUGHOUT THE CORRIDOR, SEE SIDEWALK PLANS BY OTHERS, PROJECT NO. STPN-281-2(8)--2J-10.

COORDINATED OPERATIONS

2

Other work in progress during the same period of time will include the construction of the projects listed. Coordinate operations with those of other contractors working within the same area.

This Data Entry Sheet fills Tab 111-01 effective 4-17-12 Project Type of Work STPN-281-2(8)--2J-10 PCC SIDEWALK PCC PAVEMENT WIDENING & FM-TSF-C010(115)--5B-10 RESURE

ENGINEERING & ENVIRONMENTAL

ILLINOIS IOWA WISCONSIN

CITY OF FAIRBANK 116 FAST MAIN STREET FAIRBANK, IA 50629

PROJECT AND LOCATION MAIN STREET IMPROVEMENTS FAIRBANK, IOWA BUCHANAN COUNTY STPN-281-2(10)--2J-10

RAWN BY: AFC APPROVED BY: JSB DATE: 10/27/22 SCALE: AS NOTED

	REVISIONS	
REV. NO.	DESCRIPTION	DATE

ESTIMATED PROJECT QUANTITIES AND REFERENCE NOTES

SET TYPE: BID LETTING

JOB NUMBER 22-1100 SHEET NUMBER

C.04

Item

no. 82

83

85

86

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97

2554-0212050 VALVE BOX REMOVAL

2599-9999005 ('EACH' ITEM) SUBDRAIN CLEANOUT

2599-9999007 ('HOURS' ITEM) EXPLORATORY EXCAVATION

2595-0005140 RAILROAD PROTECTIVE LIABILITY INSURANCE FOR IOWA NORTHERN RAILWAY CO.

2599-9999005 ('EACH' ITEM) FOOTING FOR CONCRETE PIP APRON, RCP, 18 IN. DIA.

2599-9999005 ('EACH' ITEM) WATER SERVICE REDUCER, 1 IN. TO 3/4 IN.

2599-9999010 ('LUMP SUM' ITEM) DECORATIVE LED LIGHTING SYSTEM

2602-0000500 OPEN-THROAT CURB INTAKE SEDIMENT FILTER, EC-602

2602-0000540 MAINTENANCE OF GRATE INTAKE SEDIMENT ETLIER BAG

2602-0000550 REMOVAL OF GRATE INTAKE SEDIMENT FILTER BAG

2602-0000530 GRATE INTAKE SEDIMENT FILTER BAG

2602-0010010 MOBILIZATIONS, EROSION CONTROL

102 2602-0010020 MOBILIZATIONS, EMERGENCY EROSION CONTROL

2602-0000520 REMOVAL OF OPEN-THROAT CURB INTAKE SEDIMENT FILTER

2599-9990009 ('LINEAR FEET' ITEM) WATER SERVICE, TRENCHLESS, COPPER 1 IN.

2602-0000312 PERIMETER AND SLOPE SEDIMENT CONTROL DEVICE, 12 IN. DIA.

2602-0000510 MAINTENANCE OF OPEN-THROAT CURB INTAKE SEDIMENT FILTER

2602-0000351 REMOVAL OF PERIMETER AND SLOPE OR DITCH CHECK SEDIMENT CONTROL DEVICE

2599-9999005 ('EACH' ITEM) CONNECTION TO EXISTING WATER MAIN

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100-24	PCC PAVEMENT	C.06
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	CURBS & RAISED ISLANDS	C.15
	SHOULDERS	C.16
	EXISTING SIGNS TO BE REMOVED	C.16
	UTILITIES (NOT POINT 25)	C.16
	WATER MAIN, TRENCHED	C.17
	FITTINGS, BY WEIGHT	C.17
	WATER SERVICE STUBS	C.17
5020-A-0		C.17
	FIRE HYDRANT ASSEMBLY	C.17
	REMOVE FIRE HYDRANT ASSEMBLY	C.17
	UTILITY CONTACT LIST	C.05
	OTTETT CONTACT ETST	C.03

UTILITIES	
MEDIACOM BRIAN KADNER 207 W PEARL STREET DECORAH, IOWA 52101 845-544-9656 bkadner@mediacomcc.com	
WINDSTREAM DAN HOGAN 740-984-1717 2015 RAINBOW ROAD WATERFORD, OHIO 45786 dan.hogan@windstream.com	
LITTLE WAPSIE COMMUNICATIONS ETHAN KLEITSCH 121 MAIN STREET READLYN, IOWA 50668 319-279-3375 tech3@readlyntelco.com	
ELECTRIC BEN DELAGARDELLE, CITY OF FAIRBANK 116 EAST MAIN STREET FAIRBANK, 10WA 50629 563-635-2869 fairbankpw@fairbank-ia.org	
GAS BEN DELAGARDELLE, CITY OF FAIRBANK 116 EAST MAIN STREET FAIRBANK, 10WA 50629 563-635-2869 fairbankpw@fairbank-ia.org	
WATER BRIAN DELAGARDELLE, CITY OF FAIRBANK 116 EAST MAIN STREET FAIRBANK, 10WA 50629 563-635-2869 cedarvalleypump@jtt.net	
SANITARY BRIAN DELAGARDELLE, CITY OF FAIRBANK 116 EAST MAIN STREET FAIRBANK, 10WA 50629 563-635-2869 cedarvalleypump@jtt.net	
STORM BEN DELAGARDELLE, CITY OF FAIRBANK 116 EAST MAIN STREET FAIRBANK, IOWA 50629 563-635-2869 fairbankpw@fairbank-ia.org	

	l	PERI	METER, S	SLOPE AN	D DITCH	CHECK S	EDIMENT	CONTROL DEVICES
					Possible S	tandards: EC	-204	
				This Data En	try Sheet fil	ls Tab 100-19	effective 10	-19-21
I	Location		Pe	rimeter and S	lope	Ditch	Check	
			Len	gth of Install	ation	Length of 1	Installation	D. word o
Begin Station	End Station	Side	9 inch Dia	12 inch Dia	20 inch Dia	12 inch Dia	20 inch Dia	Remarks
			LF	LF	LF	LF	LF	
78+95.9	79+02.7	L		30				DIVISION 2 - 3R
81+60.6	81+62.7	R		30				67% (20 LF) DIVISION 1 - CITY; 33% (10 LF) DIVISION 2 - 3R
83+16.0	83+17.7	R		55				DIVISION 1 - CITY
101+28.0	103+54.3	L		227				DIVISION 2 - 3R
101+56.5	103+06.2	R		151				DIVISION 2 - 3R

The foll	owing Standard Ro	ad Plans apply to construction work on this project.
		/ Sheet fills Tab 105-4 effective 10-18-11
Number	Date	Title
BR-101	10-18-22	BRIDGE APPROACH SECTION (GENERAL DETAILS)
BR-102	10-17-17	BRIDGE APPROACH SECTION (TWO LANE, ABUTTING PCC PAVEMENT)
DR-121	04-18-17	CONNECTED PIPE JOINTS
DR-201	04-21-20	CONCRETE APRONS
DR-303	10-17-17	SUBDRAINS (LONGITUDINAL)
DR-306	10-16-18	PRECAST CONCRETE HEADWALL FOR SUBDRAIN OUTLETS
EC-204	10-19-21	PERIMETER, SLOPE AND DITCH CHECK SEDIMENT CONTROL DEVICES
EC-301	10-18-22	ROCK EROSION CONTROL (REC)
EC-602	10-21-20	OPEN-THROAT CURB INTAKE SEDIMENT FILTER
LI-101	10-21-14	LIGHT POLE LOCATION
LI-103	04-19-22	CONDUIT AND PRECAST HANDHOLES
LI-201	04-18-17	LIGHT POLE FOUNDATION
MI-210	10-20-15	PCC DRIVEWAYS AND ALLEYS
PM-110	04-21-20	LINE TYPES
PM-111	04-21-20	SYMBOLS AND LEGENDS
PM-120	10-21-14	STOP LINES AND ISLANDS
PM-240	04-20-21	RAILROAD CROSSING ON TWO-LANE ROADWAY
PM-420	10-15-19	TWO-LANE ROADWAY WITH NO TURN LANES (ONE-WAY STOP CONDITION)
PM-520	10-15-19	TWO-LANE ROADWAY WITH NO TURN LANES (TWO-WAY STOP CONDITION)
PR-202	10-21-14	NOTCHES FOR RESURFACING (WITH OR WITHOUT RUNOUT)
PV-101	04-19-22	JOINTS
PV-102	04-21-20	PCC CURB DETAILS
PV-103	04-19-22	MANHOLE BOXOUTS IN PCC PAVEMENT
PV-106	10-17-17	PCC RAILROAD APPROACH SECTION
PV-201	04-19-22	MANHOLE BOXOUTS IN HMA PAVEMENT AND HMA OVERLAYS
PV-202	04-21-20	HOT MIX ASPHALT RESURFACING
PV-203	04-21-20	HMA BASE WIDENING
SI-881	04-16-19	SPECIAL SIGNS FOR WORK ZONES
SI-882	10-18-16	SPECIAL SIGNS FOR RESTRICTED WIDTH TRAFFIC CONTROL ZONES
SW-101	04-17-18	TRENCH BEDDING AND BACKFILL ZONES
SW-102	04-20-21	RIGID GRAVITY PIPE TRENCH BEDDING
SW-104	04-20-21	PRESSURE PIPE TRENCH BEDDING
SW-211	04-17-18	STORM SEWER PIPE CONNECTIONS
SW-401	04-20-21	CIRCULAR STORM SEWER MANHOLE
SW-501	04-21-20	SINGLE GRATE INTAKE
SW-503	04-21-20	SINGLE GRATE INTAKE WITH MANHOLE
SW-505	04-21-20	DOUBLE GRATE INTAKE
SW-506	04-21-20	DOUBLE GRATE INTAKE WITH MANHOLE
SW-507	04-21-20	SINGLE OPEN-THROAT CURB INTAKE, SMALL BOX
SW-509	04-21-20	DOUBLE OPEN-THROAT CURB INTAKE, SMALL BOX
SW-511	04-21-20	RECTANGULAR AREA INTAKE
SW-512	04-21-20	CIRCULAR AREA INTAKE
SW-514	04-17-18	BOXOUT FOR GRATE INTAKES
SW-602	04-21-20	CASTINGS FOR STORM SEWER MANHOLES
SW-603	10-16-18	CASTINGS FOR GRATE INTAKES
SW-604	04-21-20	CASTINGS FOR AREA INTAKES
TC-1	10-15-19	WORK NOT AFFECTING TRAFFIC (TWO-LANE OR MULTI-LANE)
TC-81	10-15-19	RESTRICTED WIDTH SIGNING (LESS THAN 14.5 FEET)
TC-202	10-19-21	WORK WITHIN 15 FEET OF TRAVELED WAY
TC-213	10-18-22	LANE CLOSURE WITH FLAGGERS
TC-214	04-18-23	LANE CLOSURE WITH FLAGGERS FOR USE WITH PILOT CAR
TC-216	10-18-16	LANE CLOSURE WITH SIGNALS
TC-252	04-21-20	ROUTES CLOSED TO TRAFFIC
WM-101	10-18-16	THRUST BLOCKS
WM-102	10-18-16	TRACER SYSTEM
WM-201	04-19-22	FIRE HYDRANT ASSEMBLY
JDAS 4030.221	10-21-14	APRON FOOTING
JDAS 4040.232	2020	SUBDRAIN CLEANOUT

FEHR GRAHAM
ENGINEERING & ENVIRONMENTAL

ILLINOIS IOWA WISCONSIN

OWNER/DEVELOPER: CITY OF FAIRBANK 116 EAST MAIN STREET FAIRBANK, IA 50629

PROJECT AND LOCATION: MAIN STREET IMPROVEMENTS FAIRBANK, IOWA BUCHANAN COUNTY STPN-281-2(10)--2J-10

DRAWN BY: AFC APPROVED BY: JSB
DATE: 10/27/22
SCALE: AS NOTED

	REVISIONS	
REV. NO.	DESCRIPTION	DATE
\vdash		

DRAWING: TABULATIONS SET TYPE: BID LETTING

JOB NUMBER: 22-1100 SHEET NUMBER:

C.05

								F	PCC PA	VEMEN	IT									
						This [Data Entry	y Sheet f	ills Tab	100-24 MC	DIFIED et	ffective 4	1-21-15							
			Mainline						Intersec	tion Area		Pave	Area By ement kness	Modified						
Road Identification	Direction of Travel	Station ⁻	to Station	Width	Length	Area	1st Street North	1st Street South	2nd Street North	2nd Street South	3rd Street North	3rd Street South	East Main Street	4th Street North	4th Street South	Grove Street West	S	ΣΥ	Subbase	Remarks
				FT	FT	SY	SY	SY	SY	SY	SY	SY	SY	SY	SY	SY	7 IN	9 IN	TON	
EAST MAIN STREET	вотн	83+64.0	96+42.9	32	1278.9	4793.4												4793.4	3127	DIVISION 2 - DOT 3R
EAST MAIN STREET	EB	83+64.0	95+33.7	2.5	1169.7	278.2												278.2	182	DIVISION 1 - CITY
EAST MAIN STREET	WB	83+64.0	95+61.3	2.5	1197.3	284.4												284.4	186	DIVISION 1 - CITY
EAST MAIN STREET	EB	84+06.2	95+33.7	6.5	1127.5	822.6		124.0		292.1		156.4					1395.2		829	DIVISION 1 - CITY
EAST MAIN STREET	WB	84+06.2	95+61.3	6.5	1155.1	834.8	256.8		231.7		156.9		62.0				1542.1		1006	DIVISION 1 - CITY
4TH STREET	вотн	96+26.3	100+39.5	31	413.2	1653.8												1653.8	1079	DIVISION 2 - DOT 3R
4TH STREET	вотн	95+38.9	100+72.6											92.0	128.0		219.9		144	DIVISION 1 - CITY
GROVE STREET	вотн	99+61.4	101+43.9	35	182.5	598.6												598.6	391	DIVISION 2 - DOT 3R
GROVE STREET	вотн	101+43.9	103+51.5	32	207.6	746.9												746.9	487	DIVISION 2 - DOT 3R
GROVE STREET	вотн	99+13.8	99+61.4													188.5	188.5		123	DIVISION 1 - CITY
DIVISION 1 TOTALS																				
DIVISION 2 TOTALS																				

										Н	MA PAVE	MENT													
									This Data	Entry She	et fills Tab	100-25 ef	fective	4-21-15	5										
Calculations assume a surface course unit weight (lbs/cf) of											weight (lbs/	cf) of 1	50.0	,	and a mo	odified s	ubbase uni	it weight	(lbs/cf) o	f 145					
						•							·					Bid Ite	ems	•	'				
	Locati	.on			Mainline		Total Area	HMA Pavement Thicknesses				Hot Mix Asphalt Paveme			alt Pavement			Binder		Special Backfill Cross	Special	Modified	Granular	ment ifica on	ırks
Road Identification	Directi on of Travel	Station 1	to Station	Width	Length	Area		Surface	Intermediate	Base	Surface	Surface Intermed		Intermediate Base			Surf ace	Inte rmed iate	Base	Section Area	Backfill	Subbase	Subbase	Pavement Scarifica tion	Rema
	Dir			FT	FT	SY	SY	IN	IN	IN	TONS	SY	TONS	SY	TONS	SY	TONS	TONS	TONS	SF	TONS	TONS	SY	SY	
FAIRBANK STREET	вотн	65+03.2	65+49.8	28.6	46.6	153.9	153.9	2			16 1	153.9					1.0							153.9	DIVISION 2 - DOT 3R
WALNUT STREET	вотн	65+72.3	70+02.0	25.3	429.7	1428.7	1428.7	2			151 1	.428.7					9.6							1428.7	DIVISION 2 - DOT 3R
WEST MAIN STREET	вотн	69+76.1	81+10.0	27.0	1133.9	3818.0	3818.0	2			404 3	818.0					25.8							3278.6	DIVISION 2 - DOT 3R
EAST MAIN STREET																									
1ST STREET NORTH	BOTH	85+56.5	86+11.1	10.0	54.0	60.0	60.0	1.5	1.5		5	60.0	5	60.0			0.3	0.3				26			DIVISION 1 - CITY
1ST STREET SOUTH	BOTH	85+71.4	85+96.9	10.0	26.0	26.7	26.7	1.5	1.5		2	26.7	2	26.7			0.1	0.1				12			DIVISION 1 - CITY
2ND STREET NORTH	BOTH	89+54.6	90+03.6	15.0	49.0	81.7	81.7	1.5	1.5		6	81.7	6	81.7			0.4	0.4				36			DIVISION 1 - CITY
2ND STREET SOUTH	BOTH	89+52.0	90+01.0	15.0	49.0	81.7	81.7	1.5	1.5		6	81.7	6	81.7			0.4	0.4				36			DIVISION 1 - CITY
3RD STREET NORTH	BOTH	93+54.6	93+83.6	10.0	29.0	32.3	32.3	1.5	1.5		3	32.3	2	32.3			0.2	0.2				14			DIVISION 1 - CITY
3RD STREET SOUTH	BOTH	93+59.4	93+85.4	10.0	26.0	28.9	28.9	1.5	1.5		2	28.9	2	28.9			0.1	0.1				13			DIVISION 1 - CITY
E MAIN/4TH STREET	BOTH	96+55.6	96+65.6	10.0	35.0	38.9	38.9	1.5	1.5		3	38.9	3	38.9			0.2	0.2				17			DIVISION 1 - CITY
DIVISION 1 TOTALS							350.2				28	350.2	27	350.2			1.8	1.8				152			
DIVISION 2 TOTALS							5400.5				571 5	400.5					36.5							4861.1	

(PEN-THRO	OAT CURB	INTAKE	SEDIMENT	FILTER									
		Possibl	e Standard: E	C-602										
	This Data Entry Sheet fills Tab 100-36 effective 10-16-18													
Location	Side	Installation	Maintenance	Removal	Remarks									
Station	Side	LF	EACH	EACH	nemarks									
EAST MAIN STR	EET													
95+86.3	L	8	1	1	DIVISION 1 - CITY									
96+46.3	R	8	1	1	DIVISION 1 - CITY									

		ROCK E	ROSION	CONT	ROL									
		Refer to	EC-301 and	Detail 57	0-8									
This Data Entry Sheet fills Tab 100-23 MODIFIED effective 4-17-18														
Location Material Bid Quantities														
Road Identification	Begin	End	Side		(w)	Eng. Fabric	Class C Revetment	Remarks						
	Station	Station	Lt./Rt.	FT	FT	SY	TON							
WEST MAIN STREET - BRIDGE	81+57.9	81+91.8	RT	25.0	20.0	40.0		67% (27 SY; 48 TON) DIVISION 1; 33% (13 SY; 24 TON) DIVISION 2 GROUT TO BE INCIDENTAL						
EAST MAIN STREET - BRIDGE	82+82.6	83+25.2	RT	40.0	30.0	90.0	163.0	DIVISION 1 - CITY GROUT TO BE INCIDENTAL						



ILLINOIS IOWA WISCONSIN OWNER/DEVELOPER:

CITY OF FAIRBANK

116 EAST MAIN STREET

FAIRBANK, IA 50629

PROJECT AND LOCATION:

MAIN STREET IMPROVEMENTS
FAIRBANK, IOWA
BUCHANAN COUNTY
STPN-281-2(10)--2J-10

DRAWN BY: AFC
APPROVED BY: JSB
DATE: 10/27/22
SCALE: AS NOTED

	REVISIONS		6
REV. NO.	DESCRIPTION	DATE	
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			s

DRAWING:
TABULATIONS

SET TYPE: BID LETTING
C:\C30\22\22-1100 Foirbook Hey 281\Plank\22-1100 C SHETS.deg, C.06

JOB NUMBER:

22-1100

SHEET NUMBER:

C.06

	GRATE	INTAKE	SEDIMENT	FILTER	BAG			
			ble Detail: 57					
	This Data	a Entry Sheet	fills Tab 100-	37 effective	4-18-17			
Location	Side	Installation	Maintenance	Removal	Remarks			
Station		EACH	EACH	EACH				
WALNUT STREET					1			
65+51.0	L	1	1	1	DIVISION 2 - DOT 3R			
65+67.1	R	1	1	1	DIVISION 2 - DOT 3R			
66+63.7	L	1	1	1	DIVISION 2 - DOT 3R			
67+93.8	L	1	1	1	DIVISION 2 - DOT 3R			
68+73.9	L	1	1	1	DIVISION 2 - DOT 3R			
69+90.0	L	1	1	1	DIVISION 2 - DOT 3R			
WEST MAIN STREE	Т							
69+83.1	L	1	1	1	DIVISION 2 - DOT 3R			
70+53.1	L	1	1	1	DIVISION 2 - DOT 3R			
71+43.3	R	1	1	1	DIVISION 2 - DOT 3R			
72+00.8	L	1	1	1	DIVISION 2 - DOT 3R			
73+64.3	L	1	1	1	DIVISION 2 - DOT 3R			
73+93.6	R	1	1	1	DIVISION 2 - DOT 3R			
74+18.0	L	1	1	1	DIVISION 2 - DOT 3R			
74+58.2	L	1	1	1	DIVISION 2 - DOT 3R			
77+26.9	R	1	1	1	DIVISION 2 - DOT 3R			
78+67.4	L	1	1	1	DIVISION 2 - DOT 3R			
78+94.4	R	1	1	1				
	L	1	1	1	DIVISION 2 - DOT 3R			
79+52.1					DIVISION 2 - DOT 3R			
79+96.7	R	1	1	1	DIVISION 2 - DOT 3R			
EAST MAIN STREET					1			
84+75.0	R	1	1	1	DIVISION 1 - CITY			
84+75.0	L	1	1	1	DIVISION 1 - CITY			
86+27.0	R	1	1	1	DIVISION 1 - CITY			
86+27.0	L	1	1	1	DIVISION 1 - CITY			
88+27.5	R	1	1	1	DIVISION 1 - CITY			
88+27.5	L	1	1	1	DIVISION 1 - CITY			
89+49.5	R	1	1	1	DIVISION 1 - CITY			
89+52.0	L	1	1	1	DIVISION 1 - CITY			
89+99.1	L	1	1	1	DIVISION 1 - CITY			
90+22.2	R	1	1	1	DIVISION 1 - CITY			
90+22.2	L	1	1	1	DIVISION 1 - CITY			
90+60.6	L	1	1	1	DIVISION 1 - CITY			
92+08.5	R	1	1	1	DIVISION 1 - CITY			
92+08.5	L	1	1	1	DIVISION 1 - CITY			
93+45.4	R	1	1	1	DIVISION 1 - CITY			
93+56.4	L	1	1	1	DIVISION 1 - CITY			
93+56.9	R	1	1	1	DIVISION 1 - CITY			
93+85.9	L	1	1	1	DIVISION 1 - CITY			
93+87.9	R	1	1	1				
94+09.2	L.	1	1	1	DIVISION 1 - CITY			
94+09.2	R	1	1	1	DIVISION 1 - CITY			
	К				DIVISION 1 - CITY			
96+22.3	L .	1	1	1	DIVISION 1 - CITY			
96+48.1	L	1	1	1	DIVISION 1 - CITY			
4TH STREET			, ,		1			
96+46.9	L	1	1	1	DIVISION 1 - CITY			
96+83.5	R	1	1	1	DIVISION 1 - CITY			
96+94.7	L	1	1	1	DIVISION 1 - CITY			
96+95.0	R	1	1	1	DIVISION 1 - CITY			
97+95.4	L	1	1	1	DIVISION 1 - CITY			
99+21.8	L	1	1	1	DIVISION 1 - CITY			
GROVE STREET					•			
100+16.5	R	1	1	1	DIVISION 1 - CITY			
					Tamanana anna			

				ACCES	S POIN	ITS, S	AFETY	RAMP:	S, AND	PRIVAT	TE PARKING
							Refer	to Cross-S	Sections		
Length of L	Jnclassif	ied Pipe calculated i	s based on i	using Corrug	ated Metal	Pipe.					
1 Refer to M	/I-210										
2 Refer to E	W-501.										
3 Refer to E	W-501 or	EW-502.									
*Predetermin	ned for a	ccess point not const	ructed with	this projec	t.						
					This Data	Entry Sh	eet fills	Tab 102-3	B MODIFIED	effective 1	0-16-18
Locatio	on	Туре	Ler	ngth of Open	ing ①		1 2		y Surface rea	Driveway	
Station	Side	A, B, C, Safety Ramp, or Predetermined*	Case	1½" Dropped Curb	3" Dropped Curb	W	PR	НМА	PCC	Surfacing Material	Remarks
		or Predetermined*	1 or 2	LF	LF	FT	FT	SY	SY	TON	
AST MAIN STR	REET										
85+48.26	R		N/A						39		DIVISION 1 - CITY - CONCRETE PARKING AREA FOR DON'S TRUCKS
85+99.41	R		N/A					42			DIVISION 1 - CITY - ASPHALT PARKING AREA FOR STERLING TRUCKS
93+85.97	L		N/A					26	10		DIVISION 1 - CITY - ASPHALT PARKING AREA FOR FAIRBANK FLOOR COVERING
93+96.52	R		N/A					68			DIVISION 1 - CITY - ASPHALT PARKING AREA FOR R&W HOLDINGS LLC.
95+71.40	L		N/A					53			DIVISION 1 - CITY - ASPHALT AREA FOR FAIRBANK FOOD CENTER
TH STREET						_					
96+57.31	R		N/A					225			DIVISION 1 - CITY - ASPHALT PARKING AREA FOR R&W HOLDINGS LLC.
96+65	L		N/A			10			36		DIVISION 1 - CITY - PARKING LOT
97+74.77	R		N/A					124			DIVISION 1 - CITY - ASPHALT PARKING AREA FOR R&W HOLDINGS LLC.
97+74.77	R		1	72		72			39		DIVISION 1 - CITY - APPROACH FOR R&W HOLDINGS AND ALLEY
98+11.02	L		1	65		34	15		74		DIVISION 1 - CITY - CASEY'S DRIVE
98+93.75	R		N/A					442			DIVISION 1 - CITY - ASPHALT AREA FOR R&W HOLDINGS LLC.
98+93.75	R		1	25		25			18		DIVISION 1 - CITY - APPROACH FOR R&W HOLDINGS LLC. WAREHOUSE
ROVE STREET											
99+51.50	L		1	40		40			17		DIVISION 1 - CITY

										EXIS	TING	PAVEM	IENT							
								This	Data Enti	ry Sheet	fills T	ab 102-5	effectiv	e 04-18	-17					
			Locati	ion				Sur	rface	В	ase	Sub	base	Rem	oval	Coarse A	Aggregate		Reinforcement	
No.	County	Route				Туре	Project Number	Type	Depth	Туре	Depth	Type	Depth	Type	Depth	Source	Type	Durabil ity	Туре	Remarks
		Nouce	Travel	Loc. Sign	Loc. Sign			. 7 -	IN	.57-	IN	.,,,,	IN	.,,,,	IN	Sour CC	.,,,,,	Class	.,,,,,	
1	10	281	вотн	65+03.8	81+80.0			HMA	3	HMA	2.5	STONE	6							
2	10	281	вотн	83+64.0	100+01.5			HMA	5	PCC	7	STONE	6							
3	10	281	вотн	100+01.5	103+51.5			HMA	5.5	PCC	7	STONE	6							

DIVISION 1 - CITY - CASEY'S DRIVE

	FULL-DEPTH PATCHES																			
	Possible Standards: PR-101, PR-102, PR-103, PR-104, PR-105, and PR-140.																			
	This Data Entry Sheet fills Tab 102-6C effective 4-18-17																			
	Location Dimension PCC Patches Subbase Subbase Patch w/ Patch 'EF'																			
		Reference	Lane	Length	Width	Patch	With Dowels	Without Dowels	CRC	Ramp with Dowels	HMA Patches	Composite HMA		Patch w/ 'EF' Joint	Subdrain	'CD' Joints	'CT' Joints	Joints	Anchor Lugs Removal	Remarks
Count	Station	Location Sign	Lanc	Leilgtii	WIGHT	Thickness	PR-103	PR-102	PR-104	PR-105			PR-140	PR-101	PR-101 or PR-140			PR-101		
			L, R, or B	FT	FT	IN	SY	SY	SY	SY	SY	TON	SY	SY	No.	No.	No.	No.	No.	
1	1 66+08.92 R 5.0 5.0 3.0 2.8 DIVISION 2 - DOT 3R																			
2	66+26.38		R	7.9	29.3	3.0					12.7	'								DIVISION 2 - DOT 3R

	NOTCHES AND RUNOUTS FOR RESURFACING														
	Refer to PR-201 and PR-202.														
	This Data Entry Sheet fills Tab 102-16 MODIFIED effective 10-21-14														
	Runout Length														
Road ID	Location Station	Type of Notch or Runout				Course Thickness	Posted Speed Limit	Runout Ratio			Remarks				
			IN	IN	IN	IN	MPH	FT/IN	FT	IN					
FAIRBANK STREET - WEST	65+03.2	Type 'N2'	2.0			2.0	20 to 40	25.0	50.0	2.0					
SOUTH WALNUT STREET	65+66.1	Type 'N2'	2.0			2.0	20 to 40	25.0	50.0	2.0					
FAIRBANK STREET - EAST	65+58.9	Type 'N2'	2.0			2.0	20 to 40	25.0	50.0	2.0					
WEST MAIN STREET	69+51.2	Type 'N2'	2.0			2.0	20 to 40	25.0	50.0	2.0					
NORTH WALNUT STREET	70+02.0	Type 'N2'	2.0			2.0	20 to 40	25.0	50.0	2.0					
WASHINGTON STREET	74+37.6	Type 'N2'	2.0			2.0	20 to 40	25.0	50.0	2.0					
IOWA STREET	77+53.6	Type 'N2'	2.0			2.0	20 to 40	25.0	50.0	2.0					
WATER STREET	79+17.2	Type 'N2'	2.0			2.0	20 to 40	25.0	50.0	2.0					
BRIDGE	81+10.0	Type 'N2'	2.0			2.0	20 to 40	25.0	50.0	2.0					



ILLINOIS IOWA WISCONSIN

DIVISION 1 - CITY

OWNER/DEVELOPER:
CITY OF FAIRBANK
116 EAST MAIN STREET
FAIRBANK, IA 50629

101+00.04

PROJECT AND LOCATION:

MAIN STREET IMPROVEMENTS
FAIRBANK, IOWA
BUCHANAN COUNTY
STPN-281-2(10)--2J-10

DRAWN BY: AFC
APPROVED BY: JSB
DATE: 10/27/22
SCALE: AS NOTED

$\overline{}$	REVISIONS	
REV. NO.	DESCRIPTION	DATE
\Box		

DRAWING:
TABULATIONS

SET TYPE: BID LETTING

JOB NUMBER:

22-1100

SHEET NUMBER:

C.07

100+43.5

STORM SEWER

This Data Entry Sheet fills Tab 104-5B MODIFIED effective 10-20-15

1	Diameter	or	equivalent	diameter

*		
	Bid	Item

		INTAKES AND	UTILITY ACCES	SE3		Design	Length, Slope, and I	lowlines are calculate	d from inside v	wall to ins		PIPES CL of ni	ne. An additiona	l 2 ft lengt	h is added t	to each side of	the Design Length to account fo
			_			Design	Lengen, Stope, und	Townines are careatate					of structures.	i z re renge	IS duded		the besign tengen to account to
No.	Location Station and Offset	*Type or Standard Road Plan	Form Grade	Bottom Well	- Notes	Line No	Intake/ Utilit	/ Access No.	SS Pipe Size	Bid* Length	Design Length	Slope %	Connected Pipe Joint (DR-121)		Lines	Pipe Profile Sheet No.	Notes
	and orrsec	Nodu 1 Idii	Elev.	Elev.			From	То	IN	FT	FT	,,,	Туре	Outlet Elevation	Inlet Elevation	Sheet No.	
ST MAI	N STREET	T	1		Τ	WEST MAIN	STREET			I			Г		I		T
D1	81+63.7, 60.5' R	FES, 18 IN. DIA.	960.00	960.00	67% DIVISION 1 - CITY; 33% DIVISION 2 - DOT 3R	DP1	D3	D1	18	169	165	0.80%		960.00	961.32	M.05	67% (113 LF) DIVISION 1; 33% (56 LF) DIVISION 2
D3	79+96.6, 18.8' R	SW-512, 30 IN. DIA.	968.40	960.82	DIVISION 2 - DOT 3R	DP2	D4	D3	18	106	102	0.81%		961.42	962.24	M.05	67% (71 LF) DIVISION 1; 33% (35 LF) DIVISION 2
D4	78+94.6, 21.4' R	SW-512, 30 IN. DIA.	967.45	961.74	DIVISION 2 - DOT 3R	DP3	D5	D4	18	170	166	0.80%		962.34	963.67	M.05	67% (114 LF) DIVISION 1; 33% (56 LF) DIVISION 2
D5	77+26.9, 23.6' R	SW-511 MODIFIED	967.51	963.17	67% DIVISION 1 - CITY; 33% DIVISION 2 - DOT 3R	DP4	D6	D5	18	334	330	1.00%		963.77	967.07	M.06	67% (223 LF) DIVISION 1; 33% (111 LF) DIVISION 2
D6	73+93.6, 23.4' R	SW-511 MODIFIED	971.75	966.57	67% DIVISION 1 - CITY; 33% DIVISION 2 - DOT 3R	DP5	D7	D6	15	251	247	1.00%		967.17	969.64	M.06	67% (168 LF) DIVISION 1; 33% (83 LF) DIVISION 2
D7	71+43.3, 23.6' R	SW-511 MODIFIED	973.70	969.14	67% DIVISION 1 - CITY; 33% DIVISION 2 - DOT 3R	DP6	D8	D7	15	98	94	1.00%		969.74	970.68	M.07	67% (66 LF) DIVISION 1; 33% (32 LF) DIVISION 2
D8	70+43.6, 16.0' R	SW-505	974.95	970.18	67% DIVISION 1 - CITY; 33% DIVISION 2 - DOT 3R	DP7	D9	EXISTING 48" RCP	12	16	14	11.8%		961.85	963.50	M.05	DIVISION 2 - DOT 3R - CORE DRI INTO EXISTING 48" RCP
D9	79+63.0, 21.6' L	SW-512, 30 IN. DIA.	967.60	963.00	DIVISION 2, CONTRACTOR TO VERIFY ELEVATIONS	FACT MATN	CTREET										
D10	84+75.0, 24.5' R	SW-506 MODIFIED	967.30	961.34	DIVISION 1 - CITY	EAST MAIN DP14	D10	EXISTING DP13	30	18	16	0.56%		961.74	961.84	M.08	DIVISION 1 - CITY
D11	84+75.0, 24.5' L	SW-505	967.41	962.46	DIVISION 1 - CITY	DP15	D11	D10	15	49	45	0.80%		962.60	962.12	M.08	DIVISION 1 - CITY
D12	86+27.0, 24.5' R	SW-506 MODIFIED	969.17	963.39	DIVISION 1 - CITY	DP16	EXISTING DP17	D10	30	16	14	1.22%		961.94	962.12	M.08	DIVISION 1 - CITY
D13	86+27.0, 24.5' L	SW-505	969.20	964.20	DIVISION 1 - CITY	DP17	DP18	DP16	30	126	122	1.32%		962.12	963.73	M.08	DIVISION 1 - CITY - EXISTING
D14	88+27.5, 24.5' R	SW-506 MODIFIED	971.93	966.18	DIVISION 1 - CITY	DP18	D12	EXISTING DP17	30	16	14	1.13%		963.73	963.89	M.08	DIVISION 1 - CITY
D15	88+27.5, 24.5' L	SW-505	971.99	967.00	DIVISION 1 - CITY	DP19	D13	D12	15	49	45	0.81%		964.34	964.70	M.08	DIVISION 1 - CITY
D16	89+57.3, 18.8' R	SW-401, 48 IN. DIA.	973.87	968.30	DIVISION 1 - CITY	DP20	EXISTING DP21	D12	30	28	26	1.56%		963.99	964.40	M.08	DIVISION 1 - CITY
D17	89+49.5, 73.6' R	SW-501	973.90	969.60	DIVISION 1 - CITY	DP21	DP22	DP20	30	179	175	1.31%		964.40	966.68	M.08	DIVISION 1 - CITY - EXISTING
D18	89+52.0, 60.0' L 89+99.1, 74.0' L	SW-501	973.79	969.55	DIVISION 1 - CITY	DP22	D14	DP21	30	33	31	1.31%		966.27	966.68	M.09	DIVISION 1 - CITY
D19 D20	90+22.2, 24.5' R	SW-511 SW-506 MODIFIED	973.63 975.06	969.63 969.22	DIVISION 1 - CITY DIVISION 1 - CITY	DP23 DP24	D15 EXISTING DP25	D14 D14	15 30	49 8	45 6	0.81%		967.14 966.78	967.50 966.87	M.08 M.09	DIVISION 1 - CITY DIVISION 1 - CITY
D21	90+22.2, 24.5' L	SW-505	974.91	969.90	DIVISION 1 - CITY	DP25	DP26	DP24	30	112	112	1.60%		966.87	968.66	M.09	DIVISION 1 - CITY - EXISTING
D22	90+60.6, 42.9' L	SW-512, 30 IN. DIA.	974.40	970.40	DIVISION 1 - CITY	DP26	D16	EXISTING DP25	30	9	7	2.02%		968.66	968.80	M.09	DIVISION 1 - CITY
D23	92+10.2, 24.5' R	SW-503 MODIFIED	976.90	971.11	DIVISION 1 - CITY	DP27	D17	D16	15	56	52	1.00%		969.58	970.10	M.09	DIVISION 1 - CITY
D24	92+10.2, 24.5' L	SW-501	976.79	972.14	DIVISION 1 - CITY	DP28	PLUG	D17	15	18	16	0.80%		970.20	970.33	M.09	DIVISION 1 - CITY
D25	94+15.4, 24.5' R	SW-505	980.55	973.36	DIVISION 1 - CITY	DP29	D18	D16	18	80	76	1.01%		969.29	970.05	M.09	DIVISION 1 - CITY
D26	93+87.9, 51.0' R	SW-501	980.99	975.32	DIVISION 1 - CITY	DP30	D19	D18	15	50	46	0.61%		970.25	970.53	M.09	DIVISION 1 - CITY
D27	93+56.9, 51.0' R	SW-501	980.30	975.70	DIVISION 1 - CITY	DP31	PLUG	D18	15	22	20	0.80%		970.25	970.41	M.09	DIVISION 1 - CITY
D28	93+45.4, 38.5' R	SW-512, 30 IN. DIA.	978.85	974.74	DIVISION 1 - CITY	DP32	D20	D16	30	67	63	1.30%		968.90	969.72	M.09	DIVISION 1 - CITY
D29	94+09.2, 24.5' L	SW-505	980.53	975.23	DIVISION 1 - CITY	DP33	D21	D20	15	49	45	0.81%		970.04	970.40	M.09	DIVISION 1 - CITY
D30	93+85.9, 47.3' L	SW-501	979.93	975.50	DIVISION 1 - CITY	DP34	D22	D21	12	45	41	1.00%		970.79	971.20	M.09	DIVISION 1 - CITY
D31	93+56.4, 50.4' L	SW-505	979.68	975.68	DIVISION 1 - CITY	DP35	DP36	D20	24	31	29	0.84%		969.82	970.06	M.09	DIVISION 1 - CITY
D32	96+46.3, 20.0' R	SW-507	983.87	975.41	DIVISION 1 - CITY	DP36	D23	DP35	24	158	156	0.99%		970.06	971.61	M.09	DIVISION 1 - CITY - EXISTING
D33	96+48.5, 20.0' L 96+22.2, 50.3' L	SW-505	984.00 983.80	978.00	DIVISION 1 - CITY DIVISION 1 - CITY	DP37 DP38	D24 DP39	D23	15 24	47 64	43 62	1.00%		972.30	972.64	M.10	DIVISION 1 - CITY
D34 D35	95+86.3, 50.3 L	SW-501 SW-507 MODIFIED	983.78	978.58 978.95	DIVISION 1 - CITY DIVISION 1 - CITY	DP39	DP40	DP38	24	76	76	1.00%		971.71 972.33	972.33 973.08	M.10 M.10	DIVISION 1 - CITY DIVISION 1 - CITY - EXISTING
H STRE		3W-307 HODIFIED	983.78	378.33	DIVISION 1 - CITY	DP40	D25	DP39	24	67	65	1.20%		973.08	973.86	M.10	DIVISION 1 - CITY
D36	96+46.9, 23.5' L	SW-501	982.64	975.65	DIVISION 1 - CITY	DP41	D26	D25	15	42	38	1.20%		975.37	973.86	M.11	DIVISION 1 - CITY
D37	96+94.7, 15.5' L	SW-505	983.03	976.02	DIVISION 1 - CITY	DP42	D27	D26	15	31	27	1.00%		975.93	976.20	M.11	DIVISION 1 - CITY
D38	96+95.0, 15.5' R	SW-505	983.03	978.50	DIVISION 1 - CITY	DP43	PLUG	D27	15	18	16	0.80%		976.30	976.42	M.11	DIVISION 1 - CITY
D39	96+83.5, 30.0' R	SW-512, 30 IN. DIA.	982.20	978.00	DIVISION 1 - CITY	DP44	D28	D27	12	19	15	1.20%		976.30	976.49	M.11	DIVISION 1 - CITY
D40	97+91.5, 11.2' L	SW-401, 48 IN. DIA.	983.64	976.67	DIVISION 1 - CITY	DP45	D29	D25	18	49	45	0.60%		975.46	975.73	M.10	DIVISION 1 - CITY
OVE ST			_			DP46	D30	D29	15	36	32	0.99%		975.83	9766.15	M.11	DIVISION 1 - CITY
D41	99+21.8, 15.5' L	SW-501	985.63	978.67	DIVISION 1 - CITY	DP47	D31	D30	15	30	26	0.81%		976.24	976.45	M.11	DIVISION 1 - CITY
D42	100+43.5, 19.0' R	SW-501	986.89	980.02	DIVISION 1 - CITY	DP48	D32	D25	24	228	224	0.60%		974.57	975.91	M.10	DIVISION 1 - CITY
D43	100+16.5, 45.7' R	SW-501	987.00	980.49	DIVISION 1 - CITY	DP49	D33	D32	18	42	38	0.51%		978.31	978.50	M.12	DIVISION 1 - CITY
						DP50	PLUG	D33	15	14	12	1.00%		978.68	978.80	M.12	DIVISION 1 - CITY
		1		+		DP51	D34	D33	15 15	44	40 34	1.00%		978.68	979.08	M.12	DIVISION 1 - CITY
	-	+				DP52 4TH STREET	D35	U34	15	38	34	1.01%		979.18	979.45	M.12	DIVISION 1 - CITY
	+	+		+		DP53	D36	D32	18	29	25	0.60%		976.01	976.16	M.13	DIVISION 1 - CITY
				+		DP54	D37	D32	18	48	44	0.60%		976.26	976.52	M.13	DIVISION 1 - CITY
						DP55	D38	D37	15	31	27	2.00%		978.96	979.50	M.13	DIVISION 1 - CITY
		 	1	1		DP56	D39	D38	15	21	17	0.80%		979.60	979.74	M.13	DIVISION 1 - CITY



ILLINOIS IOWA WISCONSIN OWNER/DEVELOPER: CITY OF FAIRBANK 116 EAST MAIN STREET FAIRBANK, IA 50629

PROJECT AND LOCATION: MAIN STREET IMPROVEMENTS FAIRBANK, IOWA BUCHANAN COUNTY STPN-281-2(10)--2J-10

DRAWN BY: AFC APPROVED BY: JSB
DATE: 10/27/22
SCALE: AS NOTED

	REVISIONS		1
REV. NO.	DESCRIPTION	DATE	1
			$\ \ $
			1

TABULATIONS

JOB NUMBER: 22-1100

SHEET NUMBER: SET TYPE: BID LETTING C.08

STORM SEWER This Data Entry Sheet fills Tab 104-5B MODIFIED effective 10-20-15

① Diameter or equivalent diameter
* Bid Item

INTAKES AND UTILITY ACCESSES

PIPES

								-9							
Design	Length, Slope,	and Flowlines are ca	lculated f	rom insi	ide wall to in	side wall alo	ng CL o	f pipe. An addi	tional 2 ft le	ngth is add	ed to each side	of the Design	Length to	account f	or
_					e	stimated leng	th to ce	enter of struct	ures.	_			_		
				<u> </u>											_

												estimated leng	gth to cen	iter of structu	ires.					
No.	Location Station and Offset	*Type or Standard Road Plan	Form Grade	Bottom Well	Notes	Line No.	Intake/ Utility Access No.		l Cla		Class	① Pipe Size	Bid* Length	Design Length		Connected Pipe Joint (DR-121)		Lines	Pipe Profile	Notes
	and Offset	KOAU PIAN	Elev.	Elev.	From		То	J 0	IN		FT	т Туре		Outlet Elevation	Inlet Elevation	Sheet No.				
						4TH STREE	:T													
						DP57	D40	D37		18	96	92	0.60%		976.62	977.17	M.13	DIVISION 1 - CITY		
						DP58	D41	D40		18	131	127	1.50%		977.27	979.17	M.13	DIVISION 1 - CITY		
						DP59	EXISTING 15" HDPE	D40		15	20	18	1.00%		977.30	977.48	M.13	DIVISION 1 - CITY		
						DP60	D42	D41		18	103	99	1.27%		979.27	980.52	M.13	DIVISION 1 - CITY		
						GROVE STREET														
						DP61	D43	D42		15	41	37	1.00%		980.62	980.99	M.13	DIVISION 1 - CITY		

LIST OF SUBDRAIN WORK

Possible Standards: DR-121, DR-201, DR-203, DR-301, DR-302, DR-303, DR-305 and DR-306. Possible Detail: 500-10.

* Not a bid item

This Data Entry Sheet fills Tab 104-5C effective 10-17-17

		Loc	ation			Pipe		Apr	rons		Out	lets			ed Pipe nts*	Trench	Granular	Porous	Class "A"	Pompoles	
No.	Station t	to Station	Side	Type of Installation DR-301, DR-302,	Concrete, C.M.P., or Plastic	Dia. IN	Length LF	DR-201	DR-203	500-10	DR -	-305 No.	DR-306	DR-121	Blanket	Drain	Material	Backfill*	Crushed Stone*	Remarks	
JECT MATA	CTREET			DR-303	Tustic	TIN	LF	No.	No.	No.	Туре	No.	No.	Туре	No.	LF	Cf	Cf	CY		
NEST MAIN	75+27.4	75+27.4	R	CORE DRILL	NON-PERF HDPE	6	10.0						T							DIVISION 1 - CITY	
2	76+15.6	76+15.6	R	CORE DRILL	NON-PERF HDPE	6	10.0													DIVISION 1 - CITY	
AST MAIN		70+13.0	K	CORE DRILL	NON-PERF HUPE	0	10.0													DIVISION 1 - CITY	
3	83+94.0	84+01.9	BRIDGE	CORE DRILL	PERFORATED HDPE	6	78.9						T						1	DIVISION 2 DOT 2D 1 TYPE A 2 CURRENTH CLEANOUT	
4	84+06.3	84+71.7	L	DR-303	PERFORATED HDPE		65.3													DIVISION 2 - DOT 3R - 1 TYPE A-2 SUBDRAIN CLEANOUT DIVISION 2 - DOT 3R	
	84+06.3	84+75.3	R	DR-303	PERFORATED HDPE		69.6													DIVISION 2 - DOT 3R	
- 6	84+78.3	85+48.7	1	DR-303	NON-PERF HDPE	6	71.0													DIVISION 1 - CITY - DOWNSPOUT FOR COSTA'S SPORTS BAR & GRILL	
7	84+78.3	86+23.7	L	DR-303	PERFORATED HDPE		145.2						+							DIVISION 2 - DOT 3R	
ν Ω	84+78.3	86+27.4	R	DR-303	PERFORATED HDPE		150.4														
9	85+48.5	85+48.5	R	CORE DRILL		6	16.2													DIVISION 2 - DOT 3R	
10		86+42.9	R R	DR-303	NON-PERF HDPE		22.6					-	+							DIVISION 1 - CITY - DOWNSPOUT FOR DON'S TRUCKS	
11	86+28.9 86+30.4	88+24.2	ı\	DR-303 DR-303	NON-PERF HDPE	6	193.8		-			-	+				-			DIVISION 1 - CITY - DOWNSPOUT FOR STERLING TRUCKS	
			R		PERFORATED HDPE	 	+													DIVISION 2 - DOT 3R	
12	86+30.4	88+27.9		DR-303	PERFORATED HDPE		198.5													DIVISION 2 - DOT 3R	
13	88+14.6	88+25.7	L	DR-303	NON-PERF HDPE	6	16.5													DIVISION 1 - CITY - DOWNSPOUT FOR AMERICAN LEGION	
14	88+30.9	89+56.6	R	DR-303	PERFORATED HDPE		127.1													DIVISION 2 - DOT 3R	
15	88+30.9	89+49.5	L	DR-303	PERFORATED HDPE		188.1													DIVISION 2 - DOT 3R - CAP TO BE INCIDENTAL TO SUBDRAIN INSTALLATION	
16	89+08.8	89+54.7	L .	CORE DRILL	NON-PERF HDPE	6	46.0													DIVISION 1 - CITY - DOWNSPOUT FOR VAN DAELE INSURANCE	
17	89+55.0	90+18.9	L	DR-303/CORE DRILL	PERFORATED HDPE		188.1													DIVISION 2 - DOT 3R - SUBDRAIN AT 2ND STREET NORTH	
18	89+33.8	89+49.0	R	DR-303	NON-PERF HDPE	6	16.8													DIVISION 1 - CITY - DOWNSPOUT FOR NORTHEAST SECURITY BANK	
19	90+01.4	90+18.9	R	DR-303	PERFORATED HDPE		88.0													DIVISION 1 - CITY	
20	90+25.5	92+08.7	L	DR-303	PERFORATED HDPE		180.5													DIVISION 2 - DOT 3R	
21	90+25.5	92+08.7	R	DR-303	PERFORATED HDPE	-	183.2													DIVISION 2 - DOT 3R	
22	90+71.2	90+71.2	R	CORE DRILL	NON-PERF HDPE	6	41.9													DIVISION 1 - CITY - DOWNSPOUT FOR CITY SHOP	
23	92+11.7	93+58.9	R	DR-303	PERFORATED HDPE	1	167.5													DIVISION 2 - DOT 3R	
24	92+11.7	94+05.8	L	DR-303	PERFORATED HDPE	1	194.1													DIVISION 2 - DOT 3R	
25	93+44.6	93+53.7	L	DR-303	NON-PERF HDPE	6	16.9													DIVISION 1 - CITY - DOWNSPOUT FOR RYANT PROPERTY	
26	93+86.9	93+86.9	R	DR-303	PERFORATED HDPE	6	15.5													DIVISION 1 - CITY	
27	94+02.6	94+08.9	L	DR-303	NON-PERF HDPE	6	14.8													DIVISION 1 - CITY - DOWNSPOUT FOR FAIRBANK FLOOR COVERING	
28	94+12.5	95+86.2	L	DR-303	PERFORATED HDPE	6	187.6													DIVISION 2 - DOT 3R	
29	95+86.3	95+88.3	L	DR-303	PERFORATED HDPE	6	10.0													DIVISION 1 - CITY	
30	96+21.2	96+21.3	L	DR-303	PERFORATED HDPE		10.0													DIVISION 1 - CITY	
31	96+40.5	96+48.5	L	DR-303	NON-PERF HDPE	6	18.9													DIVISION 1 - CITY - DOWNSPOUT FOR FAIRBANK COMMUNITY DAY CARE CENTER	
32	96+45.4	96+49.3	R	DR-303	NON-PERF HDPE	6	16.5													DIVISION 1 - CITY - DOWNSPOUT FOR VISION SALON	
33	96+44.7	96+50.7	R	DR-303	NON-PERF HDPE	6	10.2													DIVISION 1 - CITY - DOWNSPOUT FOR FAIRBANK COMMUNITY DAY CARE CENTER	
34	96+46.8	96+64.1	R	DR-303	NON-PERF HDPE	6	19.9													DIVISION 1 - CITY - DOWNSPOUT FOR FAIRBANK COMMUNITY DAY CARE CENTER	
TH STREE																					
35	96+98.3	100+65.2	R	DR-303	PERFORATED HDPE	6	368.9													DIVISION 2 - DOT 3R - 1 TYPE A-2 SUBDRAIN CLEANOUT	
GROVE STE	EET																				
36	100+35.1	103+51.2	L	CORE DRILL	PERFORATED HDPE	6	317.8													DIVISION 2 - DOT 3R - 1 TYPE A-2 SUBDRAIN CLEANOUT	
37	100+45.0	102+70.9	R	DR-303	PERFORATED HDPE	6	228.5													DIVISION 2 - DOT 3R - 1 TYPE A-2 SUBDRAIN CLEANOUT	



ILLINOIS IOWA WISCONSIN OWNER/DEVELOPER: CITY OF FAIRBANK 116 EAST MAIN STREET FAIRBANK, IA 50629

PROJECT AND LOCATION: MAIN STREET IMPROVEMENTS FAIRBANK, IOWA BUCHANAN COUNTY STPN-281-2(10)--2J-10

REVISIONS DRAWN BY: AFC APPROVED BY: JSB DATE: 10/27/22 SCALE: AS NOTED

DATE **TABULATIONS** SET TYPE: BID LETTING

JOB NUMBER: 22-1100 SHEET NUMBER:

C.09

			ADTUS	TMENT OF FIXTURES									
	This Data Entry Sheet fills Tab 104-10 effective 08-01-08												
NO.	LOCATION STATION	SIDE	TYPE OF FIXTURE	ADJUSTMENT	DIVISION								
1	66+22.1	RT	MANHOLE	MINOR - EX 7" OF SPACER RINGS ELEV:976.92 - PR ELEV:976.85	DIVISION 2 - DOT 3R								
2	66+32.9	RT	WATER VALVE	MINOR - EX ELEV:976.86 - PR ELEV:976.80	DIVISION 2 - DOT 3R								
3	69+79.2	LT	WATER VALVE	MINOR - EX ELEV:976.49 - PR ELEV:976.36	DIVISION 2 - DOT 3R								
4	74+24.1	LT	WATER VALVE	MINOR - EX ELEV:971.96 - PR ELEV:972.06	DIVISION 2 - DOT 3R								
5	74+42.0	RT	MANHOLE	MINOR - EX 18" OF SPACER RINGS ELEV:971.64 - PR ELEV:971.66	DIVISION 2 - DOT 3R								
6	77+51.6	RT	MANHOLE	MINOR - EX 5" OF SPACER RINGS ELEV:967.97 - PR ELEV:968.08	DIVISION 2 - DOT 3R								
7	77+64.1	RT	WATER VALVE	MINOR - EX ELEV:967.49 - PR ELEV:967.59	DIVISION 2 - DOT 3R								
8	85+83.0	RT	MANHOLE	MINOR - EX 6" OF SPACER RINGS ELEV:968.03 - PR ELEV:968.08	DIVISION 1 - CITY								
9	95+92.2	LT	WATER VALVE	MINOR - EX ELEV:983.15 - PR ELEV:983.31	DIVISION 2 - DOT 3R								
10	97+99.8	RT	MANHOLE	MINOR - EX 6" OF SPACER RINGS ELEV:983.85 - PR ELEV:983.83	DIVISION 1 - CITY								

		ELE	CTRIC	AL DU	CTS
This Data Entr	y Sheet fills	Tab 108-2 MOD	IFIED eff	ective 08	8-01-08
Chattien t		Conduit	Dia.	Length	Remarks - TOTAL LENGTH FOR BOTH
Station t	o Station	Туре	IN	FT	CONDUITS, SEE P SHEETS FOR ADDITIONAL LIGHTING DETAIL
81+81.5 R	83+26.2 R	PVC SCH. 80	1.0	144.0	
81+82.7 L	83+26.2 L	PVC SCH. 80	1.0	144.0	
83+26.2 R	84+39.1 R	PVC SCH. 80	1.0	112.9	
83+26.2 L	84+39.1 L	PVC SCH. 80	1.0	112.9	
84+39.1 R	85+39.1 R	PVC SCH. 80	1.0	100.0	
84+39.1 L	85+39.1 L	PVC SCH. 80	1.0	100.0	
85+39.1 R	86+44.4 R	PVC SCH. 80	1.0	105.6	
85+39.1 L	86+44.4 L	PVC SCH. 80	1.0	105.1	
86+44.4 R	87+37.4 R	PVC SCH. 80	1.0	92.9	
86+44.4 L	87+37.4 L	PVC SCH. 80	1.0	92.9	
87+37.4 R	88+35.4 R	PVC SCH. 80	1.0	98.0	
87+37.4 L	88+35.4 L	PVC SCH. 80	1.0	98.0	
88+35.4 R	89+38.6 R	PVC SCH. 80	1.0	103.2	
88+35.4 L	89+38.6 L	PVC SCH. 80	1.0	103.2	
89+38.6 R	90+31.0 R	PVC SCH. 80	1.0	92.5	
89+38.6 L	90+38.9 L	PVC SCH. 80	1.0	100.4	
90+31.0 R	91+39.3 R	PVC SCH. 80	1.0	108.3	
90+38.9 L	91+39.3 L	PVC SCH. 80	1.0	100.4	
91+39.3 R	92+43.3 R	PVC SCH. 80	1.0	104.0	
91+39.3 L	92+43.3 L	PVC SCH. 80	1.0	104.0	
92+43.3 R	93+27.1 R	PVC SCH. 80	1.0	83.8	
92+43.3 L	93+27.1 L	PVC SCH. 80	1.0	83.8	
93+27.1 R	93+52.4 L	PVC SCH. 80	1.0	74.4	
93+27.1 L	93+52.4 L	PVC SCH. 80	1.0	30.2	
93+27.1 R	94+26.8 R	PVC SCH. 80	1.0	99.7	
93+27.1 L	94+26.8 L	PVC SCH. 80	1.0	99.7	
94+26.8 R	95+34.0 R	PVC SCH. 80	1.0	107.2	
94+26.8 L	95+52.3 L	PVC SCH. 80	1.0	125.5	

SAFETY CLOSURES											
Refer to Section 2518 of the Standard Specifications											
This [This Data Entry Sheet fills Tab 108-13A effective 8-1-08										
e	Closur	е Туре									
Station	Road Qty.	Hazard Qty.	Remarks								
86+23.7	1		DIV 2 - STAGE 2 ON EAST MAIN STREET								
96+85.0	1		DIV 1 - STAGE 2 ON 4TH STREET SOUTH								
95+33.7	1		DIV 1 - STAGE 3 EAST MAIN STREET								
96+45.0	1		DIV 1 - STAGE 3 EAST MAIN STREET								
99+61.4	1		DIV 1 - STAGE 3 GROVE STREET								
100+50.0	1		DIV 2 - STAGE 3 GROVE STREET								
99+61.4	1		DIV 1 - STAGE 4 4TH STREET SOUTH								
103+50.0	1		DIV 2 - STAGE 4 GROVE STREET								

		LIC	<u>GHTING</u>	INSTA	LLATIC	ONS
	This	s Data Ent		ills Tab 1	1	tive 10-21-14
L	ocation		LI-101	T -	LI-201	Remarks - SEE P SHEETS FOR
Na	Ctation	Туре	А	E FT	Туре	ADDITIONAL LIGHTING DETAIL
No.	Station N STREET			FI		
1	81+81.5 R				Δ	POLE LOCATED ON BRIDGE
2	81+82.7 L				A	POLE LOCATED ON BRIDGE
AST MAIN	N STREET					
3	83+26.2 R				А	POLE LOCATED ON BRIDGE
4	83+26.2 L				А	POLE LOCATED ON BRIDGE
5	84+39.1 R				А	CENTER OF POLE TO BE 2.25' FRO BACK OF CURB
6	84+39.1 L				А	CENTER OF POLE TO BE 2.25' FRO BACK OF CURB
7	85+39.1 R				А	CENTER OF POLE TO BE 2.25' FRO BACK OF CURB
8	85+39.1 L				А	CENTER OF POLE TO BE 2.25' FRO BACK OF CURB
9	86+44.4 R				А	CENTER OF POLE TO BE 2.25' FRO
10	86+44.4 L				А	CENTER OF POLE TO BE 2.25' FRO
11	87+37.4 R				А	CENTER OF POLE TO BE 2.25' FRO
12	87+37.4 L				А	CENTER OF POLE TO BE 2.25' FRO BACK OF CURB
13	88+35.4 R				А	CENTER OF POLE TO BE 2.25' FRO BACK OF CURB
14	88+35.4 L				А	CENTER OF POLE TO BE 2.25' FRO BACK OF CURB
15	89+38.6 R				A	CENTER OF POLE TO BE 2.25' FRO BACK OF CURB
16	89+38.6 L				А	CENTER OF POLE TO BE 2.25' FRO BACK OF CURB
17	90+31.0 R				А	CENTER OF POLE TO BE 2.25' FRO
18	90+38.9 L				А	CENTER OF POLE TO BE 2.25' FRO BACK OF CURB
19	91+39.3 R				А	CENTER OF POLE TO BE 2.25' FRO
20	91+39.3 L				А	CENTER OF POLE TO BE 2.25' FRO BACK OF CURB
21	92+43.3 R				А	CENTER OF POLE TO BE 2.25' FRO
22	92+43.3 L				A	CENTER OF POLE TO BE 2.25' FRO
23	93+27.1 R				A	CENTER OF POLE TO BE 2.25' FRO
24	93+27.1 L				А	CENTER OF POLE TO BE 2.25' FRO
25	94+26.8 R				А	CENTER OF POLE TO BE 2.25' FRO
26	94+26.8 L				А	CENTER OF POLE TO BE 2.25' FRO BACK OF CURB
27	95+34.0 R				А	CENTER OF POLE TO BE 2.25' FRO
28	95+52.3 L				Α	CENTER OF POLE TO BE 2.25' FRO



ILLINOIS IOWA WISCONSIN OWNER/DEVELOPER:
CITY OF FAIRBANK
116 EAST MAIN STREET
FAIRBANK, IA 50629

PROJECT AND LOCATION:

MAIN STREET IMPROVEMENTS
FAIRBANK, IOWA
BUCHANAN COUNTY
STPN-281-2(10)--2J-10

DRAWN BY: AFC
APPROVED BY: JSB
DATE: 10/27/22
SCALE: AS NOTED

7		REVISIONS	
	REV. NO.	DESCRIPTION	DATE
J			

DRAWING:
TABULATIONS

SET TYPE: BID LETTING

JOB NUMBER: 22-1100

SHEET NUMBER:

PAVEMENT MARKING LINE TYPES See PM-110 *BCY4 - Place on the same side of the roadway to match existing markings near the project. ***STB6 - For standard curb to be painted blue to indicate ADA accessible parking spaces, factor of 3.03. **NPY4 - For estimating purposes only. No Passing Zone Lines will be located in the field. This Data Entry Sheet fills Tab 108-22 MODIFIED effective 4-16-13 BCY4: Broken Centerline (Yellow) @ 0.25 CBW6: Crosswalk Bar (White) @ 15.00 DCY4: Double Centerline (Yellow) @ 2.00 ELW4: Edge Line Right (White) @ 1.00 NPY4: No Passing Zone Line (Yellow) @ 1.25 SLW2: Stop Line (White) @ 6.00 SLW4: Solid Lane Line (White) @ 1.00 STY6: Standard Curb 6" (Yellow) @ 3.03 STB6: Standard Curb 6" (Blue) @ 3.03 Remarks Length by Line Type (Unfactored) BCY4* CBW6 DCY4 FI W4 NPY4** SI W2 SI W4 STY6 STR6 Dir. of Marking Type Road TD Station to Station (STA) R STA STA STA STA STA STA STA STA STA SEE D.10 - D.14 FOR FURTHER DETAIL C FAIRBANK ST 64+09.81 65+49.81 1.40 BOTH Waterborne/Solvent Paint 1.40 DIVISION 2 - DOT 3R FAIRBANK ST. 64+09.81 65+49.81 1.40 WB Waterborne/Solvent Paint 1.40 DIVISION 2 - DOT 3R FAIRBANK ST. 64+09.81 65+94.09 1.84 EB Waterborne/Solvent Paint 1.84 DIVISION 2 - DOT 3R WALNUT ST. 66+04.39 66+26.76 0.22 NB Waterborne/Solvent Paint 0.2 DIVISION 1 - CITY WALNUT ST. 65+72.34 65+77.60 0.05 BOTH Waterborne/Solvent Paint 0.05 DIVISION 2 - DOT 3R WALNUT ST. 66+65.09 вотн Waterborne/Solvent Paint 2.60 DIVISION 2 - DOT 3R 69+25.04 2.60 WALNUT ST. 69+24.04 69+26.04 0.02 NB Waterborne/Solvent Paint 0.26 DIVISION 2 - DOT 3R WALNUT ST. 70+04.00 70+06.00 0.02 SB Waterborne/Solvent Paint 0.13 DIVISION 1 - CITY MAIN ST. 69+95.99 0.10 вотн Waterborne/Solvent Paint DIVISION 1 - CITY 70+05.99 0.34 MAIN ST. 70+08.67 4.03 BOTH Waterborne/Solvent Paint 4.03 DIVISION 2 - DOT 3R 74+12.14 MAIN ST. 70+07.67 70+09.67 0.02 WB 0.13 DIVISION 2 - DOT 3R Waterborne/Solvent Paint MAIN ST. 70+12.06 74+02.92 3.91 WB Waterborne/Solvent Paint 3.91 DIVISION 2 - DOT 3R MAIN ST. 70+80.89 77+28.85 6.48 EB Waterborne/Solvent Paint 6.48 DIVISION 2 - DOT 3R MAIN ST. WB 74+22.91 74+37.57 0.15 Waterborne/Solvent Paint 0.15 DIVISION 1 - CITY MAIN ST. 74+80.84 78+87.02 4.06 WB Waterborne/Solvent Paint 4.06 DIVISION 2 - DOT 3R MAIN ST 74+82.14 95+39.27 20.57 вотн Waterborne/Solvent Paint 20.57 DIVISION 2 - DOT 3R MAIN ST 77+53.65 77+66.92 0.13 EB Waterborne/Solvent Paint R 0.13 DIVISION 1 - CITY MAIN ST. 77+90.17 81+83.23 EB Waterborne/Solvent Paint 3.93 DIVISION 2 - DOT 3R 3.93 MAIN ST. 79+03.06 79+17.56 0.15 WB Waterborne/Solvent Paint R 0.15 DIVISION 1 - CITY MAIN ST. 79+48,11 79+58.12 0.10 BOTH Waterborne/Solvent Paint R 0.22 DIVISION 1 - CITY MAIN ST. 79+58.04 81+83.37 2.25 WB Waterborne/Solvent Paint 2.25 DIVISION 2 - DOT 3R MATN ST 86+64.00 84+06.20 2.58 WB Waterborne/Solvent Paint 0.43 DIVISION 1 - CITY MAIN ST. 2 L-BARS AND 4 T-BARS WITHIN STATION RANGE - DIV 1 84+06.80 WB 0.48 85+19.30 1.13 L Waterborne/Solvent Paint MAIN ST. 84+16.50 84+24.50 0.08 EB Waterborne/Solvent Paint 0.08 DIVISION 1 - CITY MAIN ST. 84+31.79 85+23.79 0.92 EB Waterborne/Solvent Paint R 0.39 2 L-BARS AND 3 T-BARS WITHIN STATION RANGE - DIV 1 MAIN ST. EB 85+18.94 85+47.85 0.29 Waterborne/Solvent Paint 0.30 DIVISION 1 - CITY R MAIN ST. 85+19.50 85+49.50 0.30 WB Waterborne/Solvent Paint 0.29 DIVISION 1 - CITY MATN ST 85+48.37 85+58.36 0.10 BOTH Waterborne/Solvent Paint 0.46 DIVISION 1 - CITY MAIN ST./1ST ST. N 85+62.90 86+05.10 WB Waterborne/Solvent Paint 0.42 1ST STREET NORTH - DIVISION 1 - CITY 0.42 MAIN ST./1ST ST. N 85+64.33 WB 85+84.16 0.20 Waterborne/Solvent Paint 0.20 DIVISION 1 - CITY MAIN ST./1ST ST. N 85+54.10 85+54.10 0.00 WB Waterborne/Solvent Paint 0.10 DIVISION 1 - CITY MAIN ST./1ST ST. N WB 129 LF FOR HANDICAP AND NO PARKING STALLS - DIV 1 85+54.73 85+70.35 0.16 Waterborne/Solvent Paint 1.29 MAIN ST./1ST ST. N 85+54.73 85+60.09 0.05 WB Waterborne/Solvent Paint 0.10 DIVISION 1 - CITY MAIN ST./1ST ST. N 85+97.48 86+13.14 0.16 WB Waterborne/Solvent Paint 0.36 36 LF FOR TWO PARKING STALLS - DIVISION 1 - CITY MAIN ST./1ST ST. S 85+67.46 EB 0.34 1ST STREET SOUTH - DIVISION 1 - CITY 86+01.24 0.34 Waterborne/Solvent Paint MAIN ST./1ST ST. S 85+83.90 86+00.17 0.16 EB Waterborne/Solvent Paint 0.16 DIVISION 1 - CITY MAIN ST. 86+30.87 86+58.03 0.27 EB Waterborne/Solvent Paint R 0.27 DIVISION 1 - CITY MAIN ST. 86+30.87 0.27 WB 0.27 DIVISION 1 - CITY 86+58.03 Waterborne/Solvent Paint MAIN ST. EB 2 L-BARS AND 5 T-BARS WITHIN STATION RANGE - DIV 1 86+58.19 87+96.19 1.38 Waterborne/Solvent Paint 0.57 MATN ST. 2 L-BARS AND 5 T-BARS WITHIN STATION RANGE - DIV 1 86+58.19 87+96.19 1.38 WR Waterborne/Solvent Paint 0.57 MAIN ST. 87+73.19 87+96.19 0.23 WB Waterborne/Solvent Paint 0.23 DIVISION 1 - CITY MAIN ST. 87+73.19 87+96.19 0.23 EB Waterborne/Solvent Paint 0.23 DIVISION 1 - CITY MAIN ST. 87+96.19 88+04.19 0.08 WB DIVISION 1 - CITY Waterborne/Solvent Paint L 0.08 MAIN ST. 87+96.19 88+04.21 0.08 EB Waterborne/Solvent Paint DIVISION 1 - CITY 0.08 MAIN ST 87+96.19 88+20.19 0.24 EB Waterborne/Solvent Paint 1.05 FOR NO PARKING HATCH - DIVISION 1 - CITY MAIN ST FOR NO PARKING HATCH - DIVISION 1 - CITY 87+96.19 88+20.19 0.24 WB Waterborne/Solvent Paint 1.05 MAIN ST. 88+12.19 88+20.19 0.08 Waterborne/Solvent Paint 0.08 DIVISION 1 - CITY MAIN ST. 88+12.19 88+20.19 0.08 EB Waterborne/Solvent Paint 0.08 DIVISION 1 - CITY MAIN ST. 88+20.19 2 L-BARS WITHIN STATION RANGE - DIV 1 88+42.49 0.22 EB Waterborne/Solvent Paint R 0.12 MAIN ST. 88+20.19 89+12.19 0.92 WB Waterborne/Solvent Paint 0.39 2 L-BARS AND 3 T-BARS WITHIN STATION RANGE MAIN ST 89+12.35 89+45.63 0.33 WB Waterborne/Solvent Paint DIVISION 1 - CITY MAIN ST. 89+14.63 89+43.72 0.29 EB Waterborne/Solvent Paint 0.29 DIVISION 1 - CITY MAIN ST. 89+44.95 89+54.95 0.10 BOTH Waterborne/Solvent Paint DIVISION 1 - CITY MAIN ST./2ND ST. N 89+52.06 89+52.06 0.00 WR Waterborne/Solvent Paint L 0.12 DIVISION 1 - CITY MAIN ST./2ND ST. N 89+52.51 89+65.30 0.13 WB Waterborne/Solvent Paint 1.24 FOR HANDICAP STALL AND NO PARKING HATCH - DIV 1 L MAIN ST./2ND ST. N 89+52.51 89+57.54 0.05 WB Waterborne/Solvent Paint 0.10 DIVISION 1 - CITY MAIN ST./2ND ST. N 89+61.79 89+95.79 0.34 WB Waterborne/Solvent Paint 0.34 2ND STREET NORTH - DIVISION 1 - CITY MAIN ST./2ND ST. N WB 0.17 DIVISION 1 - CITY 89+62.32 89+78.99 0.17 Waterborne/Solvent Paint



ILLINOIS IOWA WISCONSIN owner/developer:
CITY OF FAIRBANK
116 EAST MAIN STREET
FAIRBANK, IA 50629

PROJECT AND LOCATION:

MAIN STREET IMPROVEMENTS
FAIRBANK, IOWA
BUCHANAN COUNTY
STPN-281-2(10)--2J-10

DRAWN BY: AFC
APPROVED BY: JSB
DATE: 10/27/22
SCALE: AS NOTED

1		REVISIONS		_
	REV. NO.	DESCRIPTION	DATE	
				. (

DRAWING:
TABULATIONS

SET TYPE: BID LETTING
(c\C30\22\22-1100 Fairbank Hay 281\Plana\22-1100 C SHEETS.dwg, C.11

JOB NUMBER:

22-1100

SHEET NUMBER:

C.11

PAVEMENT MARKING LINE TYPES See PM-110 *BCY4 - Place on the same side of the roadway to match existing markings near the project. ***STB6 - For standard curb to be painted blue to indicate ADA accessible parking spaces, factor of 3.03. **NPY4 - For estimating purposes only. No Passing Zone Lines will be located in the field. This Data Entry Sheet fills Tab 108-22 MODIFIED effective 4-16-13 BCY4: Broken Centerline (Yellow) @ 0.25 CBW6: Crosswalk Bar (White) @ 15.00 DCY4: Double Centerline (Yellow) @ 2.00 ELW4: Edge Line Right (White) @ 1.00 IPY4: No Passing Zone Line (Yellow) @ 1.25 SLW2: Stop Line (White) @ 6.00 SLW4: Solid Lane Line (White) @ 1.00 STY6: Standard Curb 6" (Yellow) @ 3.03 STB6: Standard Curb 6" (Blue) @ 3.03 Remarks Location Length by Line Type (Unfactored) FIW4 NPV4** Length Dir. of BCY4* CBW6 DCY4 SI W2 SI W4 STY6 STR6 Marking Type Road TD Station to Station (STA) Travel С STA STA STA STA STA STA STA STA STA SEE D.10 - D.14 FOR FURTHER DETAIL MAIN ST./2ND ST. N Waterborne/Solvent Paint 89+92.76 90+05.56 0.13 WR 0.91 NO PARKING HATCH - DIVISION 1 - CITY MAIN ST./2ND ST. S 89+49.47 89+50.93 0.01 EB Waterborne/Solvent Paint 0.12 DIVISION 1 - CITY MAIN ST./2ND ST. S 89+49.97 EB HANDICAP AND NO PARKING STALLS - DIVISION 1 - CITY 89+62.86 0.13 Waterborne/Solvent Paint 1.09 R MAIN ST./2ND ST. S 89+49.97 89+49.97 0.00 EB Waterborne/Solvent Paint 0.07 DIVISION 1 - CITY MAIN ST./2ND ST. S 89+59.63 89+93.63 0.34 EB Waterborne/Solvent Paint R 0.34 2ND STREET NORTH - DIVISION 1 - CITY MAIN ST./2ND ST. S 89+76.47 89+93.08 EB Waterborne/Solvent Paint R DIVISION 1 - CITY 0.17 0.17 MAIN ST./2ND ST. S 2 PARKING STALLS AND NO PARK HATCH - DIVISION 1 89+90.14 90+02.97 0.13 FB Waterborne/Solvent Paint R 1.42 MAIN ST./2ND ST. S 89+95.71 0.06 EB DIVISION 1 - CITY 90+02.01 Waterborne/Solvent Paint R 0.10 MAIN ST. DIVISION 1 - CITY 90+00.70 90+10.70 0.10 BOTH Waterborne/Solvent Paint 0.46 R MAIN ST./2ND ST. S 90+02.01 90+02.97 0.01 EB Waterborne/Solvent Paint 0.12 DIVISION 1 - CITY MAIN ST./2ND ST. N 90+06.07 90+06.07 0.00 WB 0.12 DIVISION 1 - CITY Waterborne/Solvent Paint MAIN ST./2ND ST. N 90+06.09 90+06.09 0.00 WB Waterborne/Solvent Paint 0.07 DIVISION 1 - CITY MAIN ST. 90+26.03 90+46.53 0.21 WB Waterborne/Solvent Paint L 0.21 DIVISION 1 - CITY MAIN ST. 90+26.03 90+40.46 0.14 EB Waterborne/Solvent Paint 0.14 DIVISION 1 - CITY MAIN ST 90+46.53 91+42.53 0.96 0.39 2 L-BARS AND 3 T-BARS WITHIN STATION RANGE - DIV 1 WB Waterborne/Solvent Paint MAIN ST 90+94.03 91+57.53 0.64 EB Waterborne/Solvent Paint R 0.30 2 L-BARS AND 2 T-BARS WITHIN STATION RANGE - DIV 1 MAIN ST. 91+18.53 91+42.53 0.24 WB Waterborne/Solvent Paint L 0.24 DIVISION 1 - CITY MAIN ST. 91+42.53 91+47.50 0.05 WB Waterborne/Solvent Paint L 0.05 DIVISION 1 - CITY MAIN ST. 91+42.53 91+57.53 0.15 WB 0.60 NO PARKING HATCH - DIVISION 1 - CITY Waterborne/Solvent Paint L MAIN ST. 91+52.50 91+57.53 0.05 WB Waterborne/Solvent Paint 0.05 DIVISION 1 - CITY MAIN ST 91+57.53 93+15.84 1.58 Waterborne/Solvent Paint 0.66 2 L-BARS AND 6 T-BARS WITHIN STATION RANGE - DIV 1 MAIN ST 91+97.91 2 L-BARS AND 4 T-BARS WITHIN STATION RANGE - DIV 1 93+07.91 1.10 EB Waterborne/Solvent Paint R 0.48 MAIN ST. 93+07.91 93+31.91 0.24 EB Waterborne/Solvent Paint R 0.24 DIVISION 1 - CITY MAIN ST. 93+15.03 93+40.84 0.26 WB Waterborne/Solvent Paint 0.26 DIVISION 1 - CITY MAIN ST./3RD ST. N 3RD STREET NORTH - DIVISION 1 - CITY 93+60.21 93+86.21 0.26 WB Waterborne/Solvent Paint L 0.26 MAIN ST./3RD ST. N 93+60.79 93+73.31 0.13 Waterborne/Solvent Paint DIVISION 1 - CITY MAIN ST./3RD ST. N 93+86.09 94+02.97 0.17 WB Waterborne/Solvent Paint 0.78 3 PARKING STALLS WITHIN STATION RANGE - DIV 1 MAIN ST./3RD ST. S 3RD STREET SOUTH - DIVISION 1 - CITY 93+53.58 93+91.58 0.38 EB Waterborne/Solvent Paint R 0.38 MAIN ST./3RD ST. S 93+72.41 93+89.55 0.17 EB Waterborne/Solvent Paint R 0.17 DIVISION 1 - CITY MAIN ST. 94+12.69 94+27.31 0.15 WB Waterborne/Solvent Paint L 0.15 DIVISION 1 - CITY MAIN ST. 94+19.20 94+33.00 0.14 EB Waterborne/Solvent Paint 0.14 DIVISION 1 - CITY MAIN ST. 94+27.31 94+67.31 0.40 WB Waterborne/Solvent Paint 2 L-BARS AND 1 T-BAR WITHIN STATION RANGE - DIV 1 MAIN ST. 94+33.00 94+73.00 0.40 EB Waterborne/Solvent Paint R 0.21 2 L-BARS AND 1 T-BAR WITHIN STATION RANGE - DIV 1 MAIN ST. 94+67.31 94+73.38 0.06 WB 0.06 Waterborne/Solvent Paint DIVISION 1 - CITY MAIN ST. 94+73.00 Waterborne/Solvent Paint 94+83.00 0.10 EB 0.10 DIVISION 1 - CITY MAIN ST. 96+29.92 96+39.92 0.10 BOTH Waterborne/Solvent Paint L R 0.38 DIVISION 1 - CITY MAIN ST. 96+43.92 0.02 WB 96+45.92 Waterborne/Solvent Paint 0.20 DIVISION 1 - CITY 4TH ST. N/MAIN ST 95+62.96 95+64.96 0.02 NB Waterborne/Solvent Paint 0.19 DIVISION 1 - CITY 4th ST. N/MAIN ST. 95+68.96 95+78.96 0.10 BOTH Waterborne/Solvent Paint R 0.38 4TH STREET NORTH - DIVISION 1 - CITY 4TH ST. 96+28.77 96+38.77 0.10 BOTH Waterborne/Solvent Paint L R 0.38 4TH STREET SOUTH - DIVISION 1 - CITY 4TH ST. 96+42.77 96+44.77 0.02 NB Waterborne/Solvent Paint 0.16 DIVISION 2 - DOT 3R 4TH ST. BOTH 96+42.77 99+60.46 3.18 Waterborne/Solvent Paint C 3.18 DIVISION 2 - DOT 3R 4TH ST./MAIN ST. 99+60.46 0.02 SB Waterborne/Solvent Paint DIVISION 2 - DOT 3R 99+62.46 0.16 GROVE ST./4TH ST Waterborne/Solvent Paint 99+79.33 100+17.33 0.38 EB 0.38 4TH STREET SOUTH - DIVISION 1 - CITY GROVE ST./4TH ST. R 100+01.09 100+17.26 0.16 EB Waterborne/Solvent Paint 0.16 DIVISION 1 - CITY GROVE ST. 100+59.00 100+69.00 BOTH R 0.30 GROVE STREET - DIVISION 1 - CITY 0.10 Waterborne/Solvent Paint GROVE ST 100+79.06 103+51.46 вотн Waterborne/Solvent Paint С DIVISION 2 - DOT 3R 2.72 2.72 GROVE ST. 101+23.77 103+69.93 2.46 WR Waterborne/Solvent Paint 2.46 DIVISION 2 - DOT 3R GROVE ST. 101+39.94 103+33.00 1.93 EB Waterborne/Solvent Paint 1.93 DIVISION 2 - DOT 3R GROVE ST. 103+14.11 103+16.11 0.02 EB Waterborne/Solvent Paint DIVISION 2 - DOT 3R TOTAL 8.55 2.93 14.56 4.42 1.28 20.57 6.06 28.27 5.43



ILLINOIS IOWA WISCONSIN owner/developer: CITY OF FAIRBANK 116 EAST MAIN STREET FAIRBANK, IA 50629

PROJECT AND LOCATION:

MAIN STREET IMPROVEMENTS
FAIRBANK, IOWA
BUCHANAN COUNTY
STPN-281-2(10)--2J-10

90.95

17.11

28.27

6.79

17.56

14.56

13.39

3.88

5.14

DRAWN BY: AFC
APPROVED BY: JSB
DATE: 10/27/22
SCALE: AS NOTED

	REVISIONS	
REV. NO.	DESCRIPTION	DATE

DRAWING:
TABULATIONS

SET TYPE: BID LETTING

JOB NUMBER: 22-1100

SHEET NUMBER: C.12

FACTORED TOTAL

<u> </u>												
PAVE	MENT MAR	KING	SYMBO	OLS AN	D LEGENDS							
Refer to PM-111												
This Dat	This Data Entry Sheet fills Tab 108-29 MODIFIED effective 4-21-15											
Road	Location				Remarks							
Identification	Station	Side	RRCW	WCSW	Reliarks							
EAST MAIN STREET	85+66	L		1	DIVISION 1 - CITY							
EAST MAIN STREET	87+85	L		1	DIVISION 1 - CITY							
EAST MAIN STREET	87+85	R		1	DIVISION 1 - CITY							
EAST MAIN STREET	89+59	R		1	DIVISION 1 - CITY							
EAST MAIN STREET	89+61	L		1	DIVISION 1 - CITY							
EAST MAIN STREET	89+93	R		1	DIVISION 1 - CITY							
EAST MAIN STREET	89+97	L		1	DIVISION 1 - CITY							
EAST MAIN STREET	91+31	L		1	DIVISION 1 - CITY							
GROVE STREET 101+04 R 1 DIVISION 2												
TOTAL			1	8								

	TEMPO	RARY T	RAFF	IC SIGNA	LS
	This Data Entry	/ Sheet fil	ls Tab	108-28 effectiv	/e 8-1-08
	Location		Туре	2	
No.	Station	One Lane Traffic	Haul Road	Intersection	Remarks
1	81+03.20	Х			STAGE 1A
1	88+09.40	Х			STAGE 1A
1	81+03.20	Х			STAGE 1B
1	88+09.40	Х			STAGE 1B

				R	EMOVAL O	F PAVEME	NT			
					Refer to Tal	oulation 102-5				
* Not a Bid Item										
				This Data Ent	ry Sheet fills	Tab 110-1 eff	ective 04-16-1	13		
Road ID	Begin Station	End Station	Side	Pavement Type	Length FT	Width FT	Area FT	Area SY	Saw Cut*	Remarks
WALNUT STREET	Station	Station		7,-	FI	FI	Г	31	LF	
SOUTH WALNUT STREET	66+26.5	66+47.9	R	PCC	42.0	2.5	110.3	12.3	5.0	DIVISION 2 - DOT 3R - CURB & GUTTE
MAIN STREET	00120.3	00147.5	K	7 00	42.0	2.3	110.5	12.5	3.0	DIVISION 2 - DOT SK - COKE & GOTTE
WEST MAIN STREET	70+36.1	70+51.1	R	PCC	15.0	7.3	118.0	13.1	28.2	DIVISION 2 - DOT 3R
WEST MAIN STREET	77+28.1	77+90.0	R	HMA	61.9	20.0	801.4	89.0	90.2	DIVISION 2 - DOT 3R
EAST MAIN STREET	83+64.0	83+80.4	вотн	PCC	16.4	23.6	381.1	42.3	23.6	DIVISION 2 - DOT 3R
EAST MAIN STREET	83+64.0	84+06.2	вотн	HMA	42.2	42.5	1404.9	156.1	17.2	DIVISION 2 - DOT 3R
EAST MAIN STREET	84+06.2	96+42.9	вотн	HMA	1236.7	31.0	39626.3	4402.9	-	DIVISION 2 - DOT 3R - CENTER 31-FEET BRIDGE TO 4TH STREET
EAST MAIN STREET	84+06.2	95+61.3	L	HMA	1155.0	11.0	10909.6	1212.2	-	DIVISION 1 - CITY
EAST MAIN STREET	84+06.2	95+33.7	R	HMA	1127.5	12.0	11189.0	1243.2	-	DIVISION 1 - CITY
EAST MAIN STREET	85+44.3	86+23.7	L	НМА	79.4	54.6	2630.6	292.3	39.1	DIVISION 1 - CITY
EAST MAIN STREET	85+93.5	86+14.1	L	PCC	20.6	33.6	513.8	57.1	20.5	DIVISION 1 - CITY
EAST MAIN STREET	85+43.8	86+24.4	R	НМА	80.6	35.8	714.5	79.4	14.2	DIVISION 1 - CITY
EAST MAIN STREET	85+64.0	85+88.5	R	PCC	24.4	33.4	818.5	90.9	24.5	DIVISION 1 - CITY
EAST MAIN STREET	89+42.0	90+16.0	L	НМА	73.9	59.0	1343.7	149.3	16.8	DIVISION 1 - CITY
EAST MAIN STREET	89+52.1	89+90.6	L	PCC	38.5	49.1	1906.6	211.8	38.5	DIVISION 1 - CITY
EAST MAIN STREET	89+39.5	90+13.5	R	HMA	74.0	69.2	2515.9	279.5	32.5	DIVISION 1 - CITY
EAST MAIN STREET	89+65.8	89+87.6	R	PCC	21.8	60.6	1301.9	144.7	21.7	DIVISION 1 - CITY
EAST MAIN STREET	93+56.9	93+88.5	L	HMA	31.5	51.8	370.8	41.2	2.8	DIVISION 1 - CITY
EAST MAIN STREET	93+62.9	93+82.8	L	PCC	19.9	43.1	911.3	101.3	19.8	DIVISION 1 - CITY
EAST MAIN STREET	93+57.6	93+90.7	R	HMA	33.1	45.1	1036.6	115.2	20.9	DIVISION 1 - CITY
EAST MAIN STREET	96+42.9	96+55.0	вотн	HMA	12.1	20.1	242.9	27.0	-	DIVISION 1 - CITY
EAST MAIN STREET	96+55.0	96+65.6	BOTH	PCC	10.6	19.8	209.3	23.3	19.8	DIVISION 1 - CITY
4TH STREET										
4TH STREET	95+36.7	95+61.8	вотн	HMA	25.1	36.1	830.7	92.3	36.1	DIVISION 1 - CITY
4th STREET	96+21.4	97+10.5	R	PCC	89.1	55.3	1052.9	117.0	-	DIVISION 2 - DOT 3R
4th STREET	96+26.3	100+39.5	вотн	HMA	413.3	27.0	12815.2	1423.9	-	DIVISION 2 - DOT 3R
4th STREET	98+99.7	99+89.6	L	PCC	89.9	60.1	985.7	109.5	-	DIVISION 2 - DOT 3R
4th STREET	100+39.5	100+44.4	вотн	HMA	4.9	29.2	137.2	15.2	-	DIVISION 1 - CITY
4th STREET	100+44.4	100+76.0	R	HMA	31.6	7.0	137.9	15.3	-	DIVISION 1 - CITY
4th STREET	100+44.4	100+77.6	вотн	PCC	33.2	19.7	649.8	72.2	19.7	DIVISION 1 - CITY
GROVE STREET										
GROVE STREET	99+13.3	99+49.0	вотн	PCC	35.7	19.8	709.4	78.8	19.8	DIVISION 1 - CITY
GROVE STREET	99+49.0	99+61.4	вотн	HMA	12.5	32.3	539.0	59.9	1.8	DIVISION 1 - CITY
GROVE STREET	100+17.4	103+51.5	BOTH	HMA	334.1	34.5	10809.0	1201.0	-	DIVISION 2 - DOT 3R

		REMOVAL	OF CO	NCRETE	AND HMA	A DRIVE	S AND I	PARKING	AREAS
* Not a Bid It	em								
			This Data B	ntry Sheet	fills Tab 11	.0-08 MODIFI	ED effective	04-17-18	
Locat	tion	Length	Width		Driveway Su	ırface Area		Saw Cut*	
Local	CION	Lengen	WIUCII	HMA Area	HMA Area	PCC Area	PCC Area	Jaw Cut	Remarks
Station	Side	FT	FT	SF	SY	SF	SY	LF	
EAST MAIN STRE	ET								
85+56.1	R	16.0	16.0			253.9	28.2	16.0	DIVISION 1 - CITY - DON'S TRUCKS
86+15.2	R	21.4	14.8	313.0	34.8			21.4	DIVISION 1 - CITY - DON'S TRUCKS
93+90.9	L	15.7	15.3			238.8	26.5	15.7	DIVISION 1 - CITY - 3RD STREET NORTH
93+92.9	L	12.9	27.5	346.2	38.5				DIVISION 1 - CITY - 3RD STREET NORTH
93+93.2	R	23.9	36.8	868.4	96.5			60.7	DIVISION 1 - CITY - 3RD STREET SOUTH
95+53.6	R	34.4	20.0	605.4	67.3			49.3	DIVISION 1 - CITY - FOOD CENTER
96+62.7	L	33.2	10.2			326.4	36.3	43.4	DIVISION 1 - CITY - STRIP MALL PARKING LOT
4TH STREET									
97+23.4	R	365.0	20.0	4614	512.7			284.5	DIVISION 1 - CITY - R&W HOLDINGS
98+13.6	L	60.0	16.3			708	78.7	35.6	DIVISION 1 - CITY - CASEY'S DRIVE
98+92.2	R	130.0	26.0	2549	283.2				DIVISION 1 - CITY - R&W HOLDINGS
99+68.7	R	22.2	54.9	1058	117.6				DIVISION 1 - CITY - R&W HOLDINGS
GROVE STREET									
100+99.2	L	54.4	20.0			824	91.5	46.1	DIVISION 1 - CITY - CASEY'S DRIVE



ILLINOIS IOWA WISCONSIN OWNER/DEVELOPER:
CITY OF FAIRBANK
116 EAST MAIN STREET
FAIRBANK, IA 50629

PROJECT AND LOCATION:

MAIN STREET IMPROVEMENTS
FAIRBANK, IOWA
BUCHANAN COUNTY
STPN-281-2(10)--2J-10

DRAWN BY: AFC
APPROVED BY: JSB
DATE: 10/27/22
SCALE: AS NOTED

	REVISIONS	
REV. NO.	DESCRIPTION	DATE

DRAWING:
TABULATIONS

SET TYPE: BID LETTING
6\(\carcar{c}{3}\mathcal{v}{2}\z2-1100\) Forbank twy 281\Pana\\22-1100\) C SHEETS.dwc. C.13

JOB NUMBER: 22-1100

SHEET NUMBER: C.13

			CANTTARY OR STORM	CELIED AD	ANDONMENT	OD DEMOV	A.I.
* Nat a hid			SANITARY OR STORM	SEWER ABA	ANDONMENT	OR REMOV	AL
* Not a bid	item		This Data Entry Shee	ot fills Tah 110	1-14 effective 0	4-16-13	
			Inits baca thery since		of Pipe	Fill Material*	
Location/D	Description	Sanitary or Storm Sewer	Abandonment, Plug Only or Abandonment, Plug and Fill or Removal	≤ 36 inch diameter (LF)	> 36 inch diameter (LF)	Flowable Mortar or CLSM (CY)	Remarks
WEST MAIN S	TREET						
70+45.7	17.6' R	STORM	REMOVAL	61			
71+47.2	26.7' R	STORM	REMOVAL	25			
74+00.9	23.5' R	STORM	REMOVAL	48			
77+35.3 78+95.9	23.9' R	STORM	REMOVAL	160			
78+95.9	21.1' R 27.2' L	STORM STORM	REMOVAL REMOVAL	104 12			CUT EXISTING PIPE NEAR 48" RCP AND PLUG THE PIPE
79+97.9	18.8' R	STORM	REMOVAL	50			COT EXISTING FIFE NEAR 48 NCF AND FEED THE FIFE
80+46.4	19.8' R	STORM	ABANDONMENT, PLUG AND FILL	125		11.2	ESTIMATED SIZE 21-INCH VCP
EAST MAIN ST	TREET						
84+59.7	22.8' L	STORM	REMOVAL	45			
84+60.9	24.2' R	STORM	REMOVAL	2			
84+56.2	22.1' R	STORM	REMOVAL	36			
86+13.3	20.0' R	STORM	REMOVAL	40			
86+23.9	23.8' L	STORM	REMOVAL	44			
86+24.9	24.4' R	STORM	REMOVAL	5			
87+96.6	19.3' R	STORM	REMOVAL	40			
88+01.6	23.5' L	STORM	REMOVAL	16		1.0	15" DCD
88+01.6 88+01.6	7.7' L 12.3' R	STORM STORM	ABANDONMENT, PLUG AND FILL REMOVAL	20 7		1.0	15" RCP
88+01.6	25.4' R	STORM	REMOVAL	6			
89+48.6	18.9' R	STORM	REMOVAL	106			
89+56.0	40.2' R	STORM	REMOVAL	20			
89+57.1	35.3' L	STORM	REMOVAL	52			
89+58.4	17.3' R	STORM	ABANDONMENT, PLUG AND FILL	30		2.0	18" RCP
89+58.5	20.3'R	STORM	ABANDONMENT, PLUG AND FILL	42		2.8	18" RCP
89+75.4	5.1' L	STORM	REMOVAL	40			
89+84.3	53.4' R	STORM	REMOVAL	27			
90+17.6	23.5' R	STORM	REMOVAL	5			
90+17.7	24.4' L	STORM	REMOVAL	44			
92+12.2	17.9' R	STORM	REMOVAL	60			1511 202
93+55.7 93+55.8	15.6' R 19.4' R	STORM	ABANDONMENT, PLUG AND FILL	24		1.1	15" RCP
93+55.8	6.5' L	STORM STORM	REMOVAL REMOVAL	16 33			
93+56.7	16.0' R	STORM	ABANDONMENT, PLUG AND FILL	30		1.4	15" RCP
93+57.1	16.3' R	STORM	ABANDONMENT, PLUG AND FILL	40		1.8	15" RCP
93+57.2	18.4' R	STORM	REMOVAL	41			
93+57.5	17.5' R	STORM	REMOVAL	267			
93+57.5	17.9' R	STORM	REMOVAL	41			
93+72.5	7.3' L	STORM	REMOVAL	39			
93+86.0	8.5' L	STORM	REMOVAL	17			
93+90.9	37.3' R	STORM	ABANDONMENT, PLUG AND FILL	25		0.2	6" HDPE, CONTACTOR CAN REMOVE IF EASIER
93+91.9	35.3' R	STORM	REMOVAL	15			
4TH STREET	22.01.0	STORM	DEMOVAL	20			
95+94.2 96+20.3	23.8' R 22.4' L	STORM STORM	REMOVAL ABANDONMENT, PLUG AND FILL	30 50		2.3	15" RCP
96+20.3	23.8' R	STORM	ABANDONMENT, PLUG AND FILL	28		1.3	15" RCP
96+22.7	24.3' L	STORM	REMOVAL	11		1.5	15 Kei
96+23.6	21.3' L	STORM	ABANDONMENT, PLUG AND FILL	64		2.9	15" RCP
96+23.9	23.1' L	STORM	REMOVAL	27			
96+24.0	22.4' L	STORM	REMOVAL	359			
96+73.0	16.3' R	STORM	REMOVAL	9			
98+39.4	24.0' L	STORM	REMOVAL	52			
GROVE STREE							
100+26.6	15.9' L	STORM	REMOVAL	35			
100+28.4	17.8' L	STORM	ABANDONMENT, PLUG AND FILL	100		4.5	15" RCP NEAR CASEY'S DRIVE, CONFIRM PIPE IS ABANDON BEFORE PLUGGING
100+27.7	21.0' R	STORM	REMOVAL	23			

	REMOVAL	OF INT	AKES AND	UTILITY	ACCESSES
	This D	ata Entry She	et fills Tab 1	l0-15 effective	4-16-13
No.	Location/De	scription	Туре		Remarks
MAIN STR	EET				
	70+44.5	17.5' R	SW-512	DIVISION 1	- CITY
	78+94.6	21.4' R	SW-512	DIVISION 1	- CITY
	79+43.2	26.4' L	SW-512	DIVISION 1	- CITY
	79+96.6	18.8' R	SW-512	DIVISION 1	- CITY
	84+59.7	23.8' L	SW-511	DIVISION 1	- CITY
	84+60.9	25.2' R	SW-511	DIVISION 1	- CITY
	86+23.9	24.8' L	SW-511	DIVISION 1	- CITY
	86+25.2	25.4' R	SW-511	DIVISION 1	- CITY
	88+01.5	24.5' L	SW-511	DIVISION 1	- CITY
	88+01.6	26.4' R	SW-511	DIVISION 1	- CITY
	89+55.9	41.4' R	SW-512	DIVISION 1	- CITY
	89+57.1	36.3' L	SW-511	DIVISION 1	- CITY
	89+57.3	18.8' R	SW-401	DIVISION 1	- CITY
	90+00.5	38.1' L	SW-512	DIVISION 1	- CITY
	90+01.4	75.4' R	SW-512	DIVISION 1	- CITY
	90+17.5	24.5' R	SW-511	DIVISION 1	- CITY
	90+17.7	25.4' L	SW-511	DIVISION 1	- CITY
	93+55.6	17.5' R	SW-401	DIVISION 1	- CITY
	93+56.9	41.1' L	SW-512	DIVISION 1	- CITY
	93+57.0	36.6' R	SW-512	DIVISION 1	- CITY
	93+91.9	36.5' R	SW-512	DIVISION 1	- CITY
	93+95.3	40.9' L	SW-512	DIVISION 1	- CITY
	93+99.9	21.1' R	SW-511	DIVISION 1	- CITY
	94+00.6	21.7' L	SW-511	DIVISION 1	- CITY
4TH STRE	ET			'	
	95+62.9	23.9' R	SW-512	DIVISION 1	- CITY
	95+67.0	19.4' L	SW-512	DIVISION 1	- CITY
	95+82.6	34.2' L	SW-512	DIVISION 1	- CITY
	96+22.1	22.5' L	SW-401	DIVISION 1	- CITY
	96+26.7	36.5' L	SW-512	DIVISION 1	- CITY
	96+40.1	19.6' L	SW-512	DIVISION 1	- CITY
	96+81.5	22.8' R	SW-512	DIVISION 1	- CITY
GROVE ST	REET				
	100+16.0	40.4' R	SW-512	DIVISION 1	- CITY
	100+26.6	17.8' L	SW-401	DIVISION 1	- CITY
	100+28.3	20.2' R	SW-512	DIVISION 1	- CITY
	101+06.2	29.8' R	SW-512	DIVISION 1	- CITY

FEHR GRAHAM

ENGINEERING & ENVIRONMENTAL

ILLINOIS IOWA WISCONSIN OWNER/DEVELOPER:
CITY OF FAIRBANK
116 EAST MAIN STREET
FAIRBANK, IA 50629

PROJECT AND LOCATION:

MAIN STREET IMPROVEMENTS
FAIRBANK, IOWA
BUCHANAN COUNTY
STPN-281-2(10)--2J-10

DRAWN BY: AFC
APPROVED BY: JSB
DATE: 10/27/22
SCALE: AS NOTED

	REVISIONS	
REV. NO.	DESCRIPTION	DATE

DRAWING:
TABULATIONS

SET TYPE: BID LETTING
CAPTRI 20 20-1100 Extends the 28/15/00/20-1100 C SEFFE day, C.14

JOB NUMBER:

22-1100

SHEET NUMBER:

C.14

	REMOVA	L OF L	IGHT PO	DLES AN	D CONCRETE	FOOTINGS
		This Data E	ntry Sheet	fills Tab 11	0-16 effective 4-	16-13
	Locatio	on			Removal of	
No.	Station	Off	set	Removal of Light Pole	Concrete Footing	Remarks
NO.	Station	Left	Right	226.10 1020	for Light Pole	
MAIN STRE	ET					
1	81+81.5		22.2	1		
2	81+82.7	22.1		1		
3	83+26.2	22.5		1		
4	83+26.2		22.5	1		
5	84+15.6	26.4		1	1	
6	85+48.5	28.6		1	1	
7	87+21.8	28.2		1	1	
8	88+01.9		29.7	1	1	
9	89+42.5	27.4		1	1	
10	90+12.8		27.7	1	1	
11	91+80.3	25.6		1	1	
12	93+38.7		24.1	1	1	
13	93+99.6	24.4		1	1	
14	94+68.5		23.6	1	1	
15	95+67.1	24.8		1	1	
16	96+35.5		36.7	1	1	
4TH STREE	Т					
17	97+00.5		26.7	1	1	
18	98+07.8		25.5	1	1	
19	99+75.6		27.4	1	1	

			CURB	S AND RAIS	ED ISLANDS		
			Refer to	PV-20, PV-102, 60	000s Detail Series	•	
Bid Item							
			This Data Entr	/ Sheet fills Tab	112-4 effective 10	9-21-14	
			Island Interior		Curb and Gutter		
Point No.	Station	Offset	Area	Curb Type	Gutter Width	Length	Remarks
			SY	curo Type	FT	LF	
1	66+29.0	50.3 R		6" Standard PCC	2.5	49.9	DIVISION 2 - ADA DROP CURB
2	85+54.1	69.2 L		6" Standard PCC	2.5	10.0	DIVISION 1 - 1ST STREET NORTH
3	85+68.8	50.1 R		6" Standard PCC	2.5	10.0	DIVISION 1 - 1ST STREET SOUTH
4	86+13.7	69.1 L		6" Standard PCC	2.5	10.0	DIVISION 1 - 1ST STREET NORTH
5	89+49.5	78.6 R		6" Standard PCC	2.5	15.0	DIVISION 1 - 2ND STREET SOUTH
6	89+52.1	68.7 L		6" Standard PCC	2.5	15.0	DIVISION 1 - 2ND STREET NORTH
7	90+03.5	78.6 R		6" Standard PCC	2.5	15.0	DIVISION 1 - 2ND STREET SOUTH
8	90+06.1	68.5 L		6" Standard PCC	2.5	15.0	DIVISION 1 - 2ND STREET NORTH
9	93+52.0	66.4 L		6" Standard PCC	2.5	15.0	DIVISION 1 - 3RD STREET NORTH
10	93+56.9	56.9 R		6" Standard PCC	2.5	5.0	DIVISION 1 - 3RD STREET SOUTH
11	93+86.0	66.3 L	·	6" Standard PCC	2.5	15.0	DIVISION 1 - 3RD STREET NORTH
12	93+87.9	59.6 R		6" Standard PCC	2.5	10.0	DIVISION 1 - 3RD STREET SOUTH
13	96+55.6	20.0 L		6" Standard PCC	2.5	10.0	DIVISION 1 - E. MAIN STREET
14	96+55.6	20.0 R		6" Standard PCC	2.5	10.0	DIVISION 1 - E. MAIN STREET

									CL	EARING	AND GR	UBBING	ì										
								Thi	is Data Ent	ry Sheet fi	lls Tab 110-	17 effect	ve 4-18-17										
Location							Trees, S	Stumps, an	d Logs and	Down Timbe	r Material D	iameters					A11	Other Mat	erials	Est:	imated Quan	tities	
Station to Station or Ref. Loc. Sign to Ref. Loc. Sign or	Direction of Travel	Work and Material Type	3"-6"	>6"-9"	>9"-12"	>12"-15"	>15"-18"	>18"-24"	>24"-30"	>30"-36"	>36"-42"	>42"-48"	>48"-60"	>60"-72"	>72"	Calculated Units	Length	Width	Calculated Units	Units	Area	Herbicide Application	Remarks
Description	OI II.avei															UIILLS	FT	FT	UIILLS	Units	Acres	Each	
81+32.7 - 81+94.4	EB	BRUSH - CLEARING															50.0	35.0	14.0		0.04		TREES 6 IN. IN DIAMETER OR LESS
82+78.3 - 83+42.5	EB	BRUSH - CLEARING															65.0	40.0	20.8		0.06		TREES 6 IN. IN DIAMETER OR LESS

	RAIL	ROAD A	PPROACH	I SECTIONS
	This Data E	ntry Sheet f	ills Tab 11	2-3 effective 4-16-13
Cross	ing	Paveme	nt Type	
Location	Angle	HMA	PCC	Remarks
Station	Aligie	SY	SY	
103+60.85	32.4°		124.3	SEE ESTIMATED REFERENCE NOTES AND D AND L SHEETS FOR FURTHER DETAIL
				D AND E SHEETS FOR FORTHER DETAIL



ILLINOIS IOWA WISCONSIN OWNER/DEVELOPER:
CITY OF FAIRBANK
116 EAST MAIN STREET
FAIRBANK, IA 50629

PROJECT AND LOCATION:

MAIN STREET IMPROVEMENTS
FAIRBANK, IOWA
BUCHANAN COUNTY
STPN-281-2(10)--2J-10

DRAWN BY: AFC
APPROVED BY: JSB
DATE: 10/27/22
SCALE: AS NOTED

	REVISIONS	
REV. NO.	DESCRIPTION	DATE

DRAWING:
TABULATIONS

SET TYPE: BID LETTING
CACHARD 192-1100 Colombia Illin 98(1) 89(2) 1100 C SHETTS days, C.15

JOB NUMBER: 22-1100

SHEET NUMBER: C.15

SHOULDERS Lane(s) to which the shoulder is adjacent. 3 Applies only for Paved Shoulders constructed on project with existing granular shoulders. Calculations assume a HMA unit weight (lbs/cf) of 147 , Modified Subbase unit weight (lbs/cf) of 145 This Data Entry Sheet fills Tab 112-9 MODIFIED effective 10-20-20 Location rection Of (C) raffic Class 13 HMA Cross Start End Width Length Paved Hot Mix Asphalt Section Binder Remarks Road Excavation Station to Station Side Area Identification cy ② FT FT FT SF TON TON/STA TONS 84.2 FOR 4" BASE, 2" SURFACE LIFT PAID UNDER HMA SURFACE COURSE ITEM WEST MAIN STREET WB 69+90.2 73+69.1 L 2.0 2.0 2.0 378.9 28.1 18.4 1.1 151.4 FOR 4" BASE, 2" SURFACE LIFT PAID UNDER HMA SURFACE COURSE ITEM WEST MAIN STREET EB 70+47.8 77+29.1 R 2.0 2.0 2.0 681.3 50.5 33.1 4.9 2.0 WEST MAIN STREET WB 73+84.0 74+07.0 2.0 2.0 2.0 23.0 1.7 1.1 4.9 0.1 5.1 FOR 4" BASE, 2" SURFACE LIFT PAID UNDER HMA SURFACE COURSE ITEM WEST MAIN STREET 74+65.5 78+87.0 2.0 2.0 2.0 421.5 31.2 4.9 1.2 93.7 FOR 4" BASE, 2" SURFACE LIFT PAID UNDER HMA SURFACE COURSE ITEM WB 20.5 79.0 FOR 4" BASE, 2" SURFACE LIFT PAID UNDER HMA SURFACE COURSE ITEM WEST MAIN STREET EB 77+89.5 81+45.0 2.0 2.0 2.0 355.5 26.3 17.4 4.9 1.0 WEST MAIN STREET 79+48.8 81+45.2 2.0 2.0 2.0 196.4 14.6 9.6 0.6 43.6 FOR 4" BASE, 2" SURFACE LIFT PAID UNDER HMA SURFACE COURSE ITEM 4.9 TOTALS: 152.4 100.100 6.0 457.0

UTILITIES (NOT A POINT 25 PROJECT)

This Data Entry Sheet fills Tab 262-5 effective 10-18-15
THIS IS NOT A POINT 25 PROJECT AND IS NOT SUBJECT TO THE
PROVISIONS OF IAC 761-115.25.

	EXISTING SIGNS TO BE REMOVED										
	This Data Entry Sheet fills Tab 190-62 effective 10-15-13										
CTCN NUMBER OR	LOCATION	DIRECTION	TYPE 'A' SIGN	TYPE 'B' SIGN	EXISTIN	REINSTALL IG SIGNS	CONCRETE	SUPPORT STRUCTURE &	APPLICABLE		
SIGN NUMBER OR DESCRIPTION	LOCATION STATION	DIRECTION OF TRAVEL	ASSEMBLY	ASSEMBLY	TYPE 'A'	TYPE 'B'		FOUNDATION	SIGNING	REMARKS	
									NOTES		
			EACH	EACH	EACH	EACH	EACH	EACH			
M3-2, M1-4	73+49	EB			1					EAST 281 - DIV 1	
W14-3	74+00	EB			1					NO PASSING ZONE - DIV 1	
R2-1	75+82	EB			1					SPEED LIMIT 25 - DIV 1	
R2-1	96+98	SB			1					SPEED LIMIT 25 - DIV 1	
W3-1	96+98	SB			1					STOP AHEAD - DIV 1	
M3-2, M1-4, M6-1	98+07	SB			1					EAST 281 LEFT- DIV 1	
R1-1, W4-4	99+75	SB			1					STOP CROSS TRAFFIC NO STOP - DIV 2	
D3	99+76	SB			1					4TH ST S/GROVE ST - DIV 2	
R8-3	101+39	WB			1					NO PARKING - DIV 2	
M3-4	101+40	WB			1					WEST 281 RIGHT - DIV 2	
R8-3	102+28	WB			1					NO PARKING - DIV 2	
M3-4, M1-4, M6-1	102+28	WB			1					SPEED LIMIT 25 - DIV 2	

ILLINOIS IOWA WISCONSIN owner/developer: CITY OF FAIRBANK 116 EAST MAIN STREET FAIRBANK, IA 50629 PROJECT AND LOCATION:

MAIN STREET IMPROVEMENTS
FAIRBANK, IOWA
BUCHANAN COUNTY
STPN-281-2(10)--2J-10

DRAWN BY: AFC
APPROVED BY: JSB
DATE: 10/27/22
SCALE: AS NOTED

	REVISIONS	
REV. NO.	DESCRIPTION	DATE

DRAWING: TABULATIONS

JOB NUMBER:

22-1100

SHEET NUMBER:

C.16

SET TYPE: BID LETTING G\C30\22\22-1100 Foirbank Hwy 28\\Plank\22-1100 C SHETS.dwg, C.16

	WATER MAIN,	TRENC	HED		
STATION	STATION	L.F.	REMARKS		
EAST MAIN STREET			•		
83+83.8, 30.3' L	83+90.6, 26.0' L	8	8"		
83+90.6, 26.0' L	96+02.5, 20.4' L	1218	10"		
86+60.0, 12.0' L	86+60.0, 16.0' L	4	6"		
86+56.0, 16.0' L	86+60.0, 16.0' L	4	6"		
86+60.0, 16.0' L	86+64.0, 16.0' L	4	6"		
89+88.5, 12.1' L	89+89.1, 81.1' L	69	6" - 2ND STREET NORTH		
89+89.1, 76.1' L	89+93.1, 80.1' L	8	4" - 2ND STREET NORTH		
89+88.5, 12.1' L	89+87.6, 90.8' R	103	6" - 2ND STREET SOUTH		
89+87.6, 85.7' R	89+91.6, 89.9' R	8	4" - 2ND STREET SOUTH		
4TH STREET	•				
95+91.2, 17.9' R	100+64.1, 19.5' R	473	10"		
99+31.2, 19.5' R	99+34.2, 19.5' L	3	4"		
99+34.2, 19.5' L	99+88.7, 19.5' L	55	6"		
GROVE STREET					
99+81.3, 59.3' L	100+14.2, 59.7' L	33	4"		
100+14.2, 59.7' L	100+14.2, 62.7' L	3	4"		

FITTINGS, BY WEIGHT				
STATION	LBS	FITTING TYPE		
EAST MAIN STREET	F2	Oll COLTD DEDATE CLEEK		
83+87.7, 27.8' L	52	8" SOLID REPAIR SLEEVE		
83+90.6, 25.9' L	54	10"X8" REDUCER		
84+10.1, 15.5' L	17	6" CAP		
84+12.0, 11.8' L	74	10" 45° BEND		
86+54.0, 16.0' L	17	6" CAP		
86+56.0, 16.0' L	17	6" CAP		
86+56.0, 16.0' L	36	6" SOLID REPAIR SLEEVE		
86+60.0, 12.0' L	93	10"X6" TEE		
86+60.0, 13.7' L	17	6" CAP		
86+60.0, 14.3' L	17	6" CAP		
86+60.0, 16.0' L	60	6" TEE		
86+64.1, 16.0' L	36	6" SOLID REPAIR SLEEVE		
89+88.5, 12.1' L	110	10"X6" CROSS - 2ND STREET		
89+89.1, 76.1' L	51	6"X4" TEE		
89+89.1, 81.1' L	17	6" CAP		
89+93.1, 76.0' L	26	4" 90° BEND		
89+93.1, 80.1' L	25	4" SOLID REPAIR SLEEVE		
89+87.6, 85.7' R	51	6"X4" TEE		
89+87.6, 90.8' R	17	6" CAP		
89+91.6, 85.8' R	26	4" 90° BEND		
89+91.6, 89.9' R	25	4" SOLID REPAIR SLEEVE		
95+67.8, 13.4' L	64	10" SOLID REPAIR SLEEVE		
95+86.3, 13.4' L	120	10" TEE - MAIN & 4TH		
95+91.2, 13.4' L	67	10" 22.5° BEND		
95+91.1, 29.7' L	17	6" CAP		
95+93.9, 32.0' L	17	6" CAP		
96+00.9, 23.0' L	64	10" SOLID REPAIR SLEEVE		
96+02.5, 20.4' L	120	10" TEE		
96+49.7, 13.7' R	64	10" SOLID REPAIR SLEEVE		
96+49.7, 16.2' R	17	6" CAP - FH TEE		
4TH STREET				
98+02.0	93	10"X6" TEE		
98+02.0	18	6" PLUG W/ 2" TAP		
99+31.2, 19.5' R	25	4" SOLID REPAIR SLEEVE		
99+34.2, 19.5' R	27	6"X4" REDUCER		
99+88.7, 19.5' R	93	10"X6" TEE - 4TH & GROVE		
99+88.7, 16.5' R	17	6" CAP		
100+61.0, 19.5' R	83	10"X4" TEE		
100+64.1, 19.5' R	35	10" CAP		
GROVE STREET				
100+14.2, 59.7' R	26	4" 90° BEND		
100+14.2, 62.7' R	25	4" SOLID REPAIR SLEEVE		
100+14.3, 57.2' R	10	4" CAP		

	WATER SERVICE STUBS						
STATION	SIDE	3/4"	1"	2" 6"	REMARKS		
EAST MAIN STREET	Г						
85+31.3	L		14		COSTA'S SPORTS BAR AND GRILL		
85+60.2	R		50		DON'S TRUCKS		
86+36.8	L		14		FAIRBANK HISTORICAL SOCIETY		
87+01.9	L		15		JULIE EVEN		
87+03.3	R		38		BOYD'S BAR AND GRILL		
87+28.5	R		38		BRONSON & AMANDA WIERCK		
87+29.2	R		38		BRONSON & AMANDA WIERCK		
87+30.3	L		15		BELLIS INSURANCE INC.		
87+75.9	R		38		TIMELESS TRADITIONS		
87+94.6	L		15		AMERICAN LEGION		
88+07.7	R		99		CITY HALL - DIRECTION BORE		
88+54.4	L		15		MAURICE & WILMA WELSH		
88+77.7	L		15		JOE MILLER PLUMBING & HEATING INC.		
89+32.7	L		14		VANDAELE INSURANCE, LLC.		
89+87.7	R		40		NORTHEAST SECURITY BANK		
90+29.6	L		12		POST OFFICE		
90+67.7	R		39		CITY SHOP		
90+73.4	L		14		CITY OF FAIRBANK		
91+65.9	L		14		FLORAL IMAGES & GIFTS		
91+69.3	R		64		DANIEL & KATIE TRIMBLE 210 EAST MAIN		
92+23.2	L		14		BROCK ZARUBA 213 EAST MAIN		
92+33.9	R		60		FAIRBANK PUBLIC LIBRARY		
93+00.4	R		39		SCOTT & NANCY JANS 216 EAST MAIN		
93+13.9	L		14		JEFFREY RYANT 217 EAST MAIN		
93+37.5	L		23		JEFFREY RYANT 104 3RD STREET N		
94+04.1	R		60		R&W HOLDING LLC.		
94+53.5	L		13		FAIRBANK FLOORING		
94+96.1	L		20		FAIRBANK FOOD CENTER		
4TH STREET	_	1					
96+72.4	R		9		R&W HOLDING LLC.		
98+02.0	L			51	CASEY'S (4TH ST ENTRANCE)/ALLEY		
99+18.4	L		57		CASEY'S, 1" COUPLER INCIDENTAL TO WATER SERVICE		
100+59.0	L		37		DEBRA YONKOVIC 402 GROVE		

VALVES						
STATION EACH GATE VALVE SIZE						
EAST MAIN STREET						
86+60.0, 14.0' L	1	6"				
86+67.2, 12.0' L	1	10"				
89+83.5, 12.1' L	1	10"				
89+87.7, 81.7' R	1	6"				
89+89.0, 73.1' L	1	6"				
89+93.5, 12.1' L	1	10"				
95+82.3, 13.4' L	1	10"				
95+96.8, 16.9' L	1	10"				
4TH STREET	•					
95+95.2, 18.0' R	1	10"				
99+83.7, 19.5' R	1	10"				
99+88.7, 24.5' R	1	6"				
99+93.7, 19.5' R	1	10"				
GROVE STREET						
100+09.2, 59.6' L	100+09.2, 59.6' L 1 4"					

FIRE H	YDRANT	ASSEMBLY		
STATION	EACH	REMARKS		
EAST MAIN STREET				
86+11.6, 38.9' L	1	1ST STREET		
90+03.0, 44.5' L	1	2ND STREET		
93+49.5, 38.0' L	1	3RD STREET		
95+75.0, 40.1' L	1	4TH STREET		
4TH STREET				
100+45.2, 23.7' R	1	GROVE STREET		

REMOVE FIR	RE HYDI	RANT ASSEMBLY		
STATION	EACH	REMARKS		
EAST MAIN STREET				
86+14.5, 26.0' L	1	1ST STREET NORTH		
90+05.1, 26.5' L	1	2ND STREET NORTH		
90+64.0, 53.8' L	1	OLD TOWN JAIL PARK		
96+49.7, 22.4' R	1	4TH STREET		
GROVE STREET				
100+20.3, 29.5' R	1	4TH STREET		

FEHR GRAHAM
ENGINEERING & ENVIRONMENTAL

ILLINOIS IOWA WISCONSIN OWNER/DEVELOPER:
CITY OF FAIRBANK
116 EAST MAIN STREET
FAIRBANK, IA 50629

PROJECT AND LOCATION:

MAIN STREET IMPROVEMENTS
FAIRBANK, IOWA
BUCHANAN COUNTY
STPN-281-2(10)--2J-10

DRAWN BY: AFC
APPROVED BY: JSB
DATE: 10/27/22
SCALE: AS NOTED


	REVISIONS	
REV. NO.	DESCRIPTION	DATE


DRAWING:
TABULATIONS

SET TYPE: BID LETTING
6\C30\Z2\22-1100 Foirbank Hay 281\Pana\22-1100 C SHETS.dwc. C.17

JOB NUMBER:
22-1100
SHEET NUMBER:

C.17

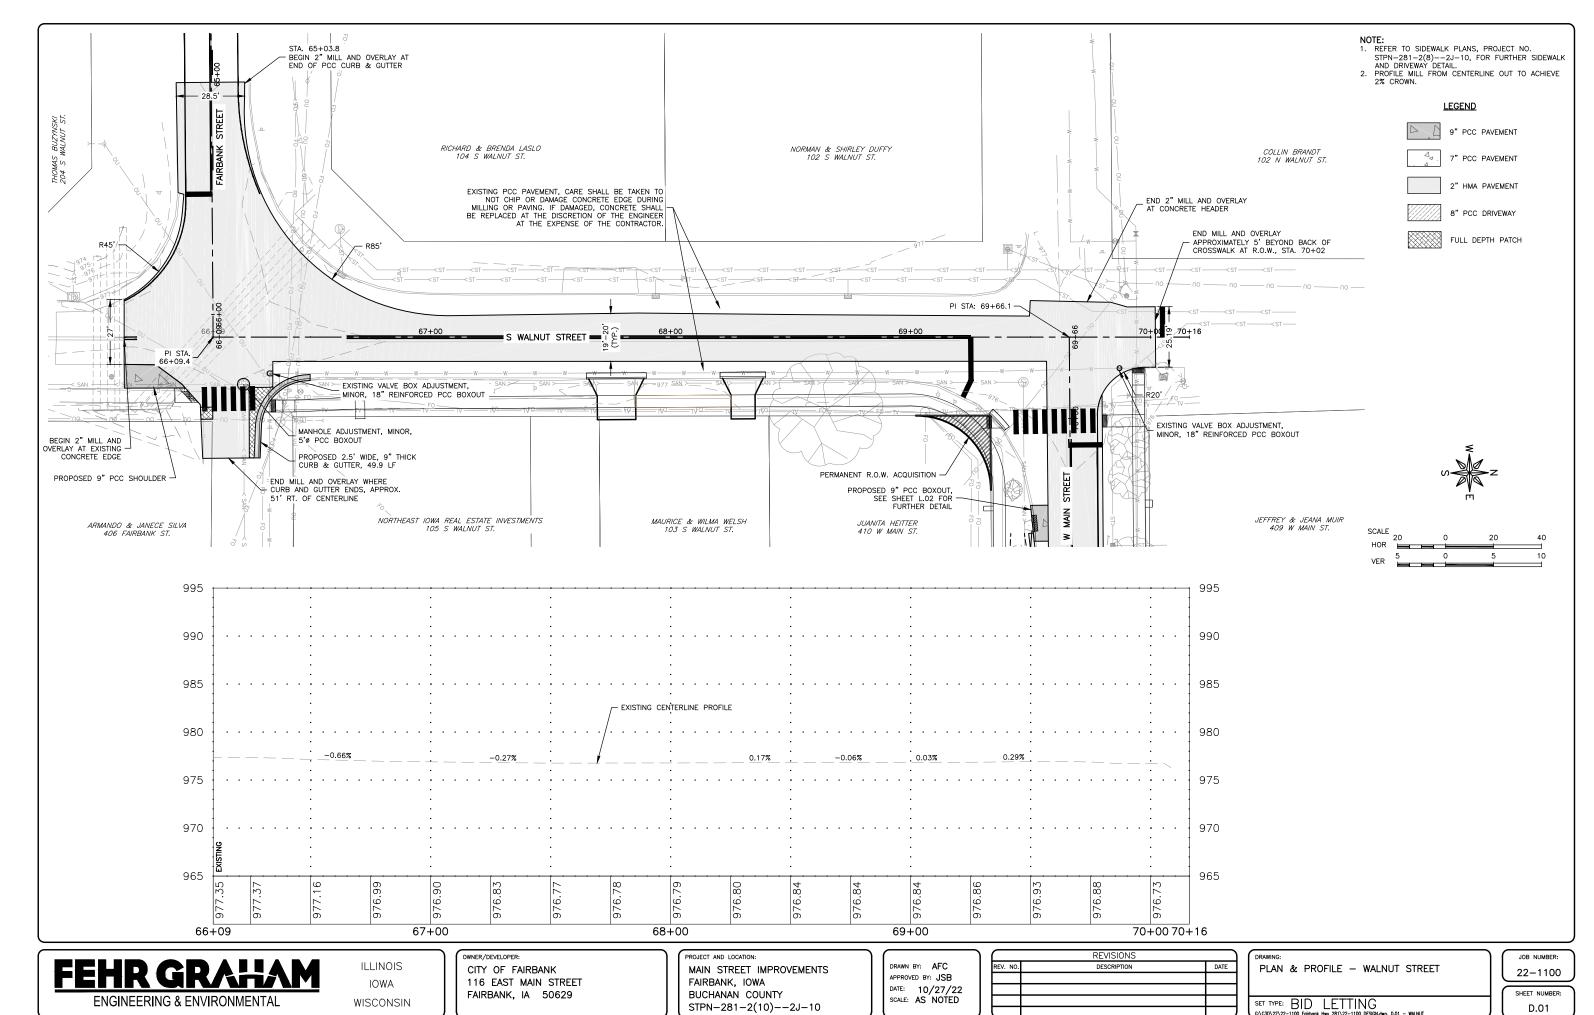

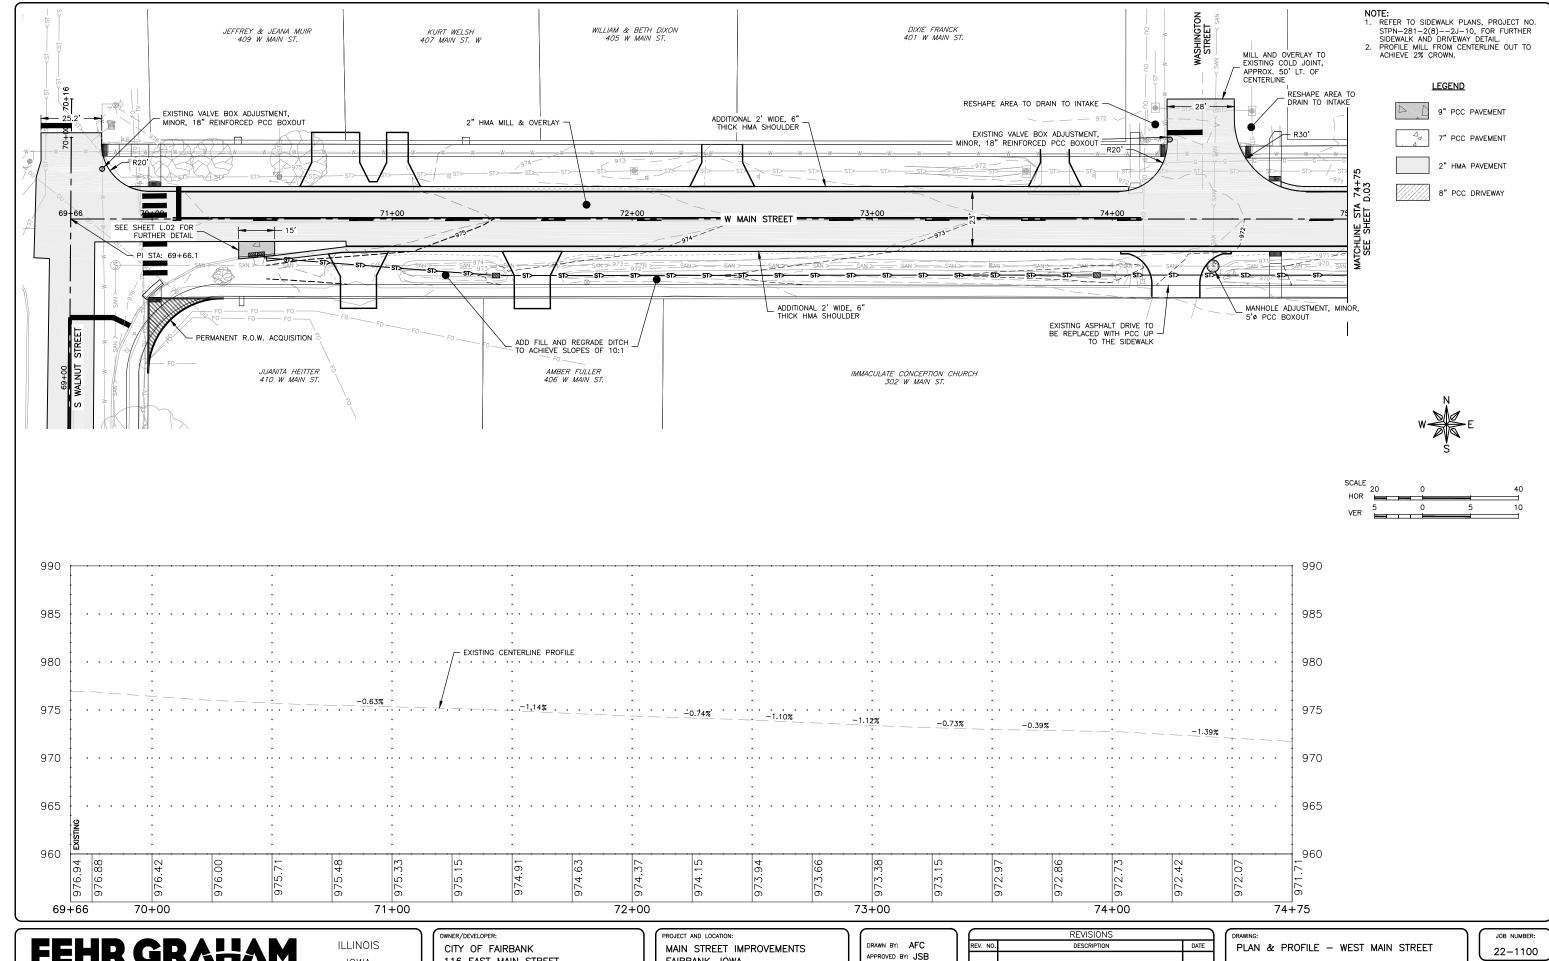

ENGINEERING & ENVIRONMENTAL

IOWA WISCONSIN 116 EAST MAIN STREET FAIRBANK, IA 50629

FAIRBANK, IOWA BUCHANAN COUNTY STPN-281-2(10)--2J-10


APPROVED BY: JSB DATE: 10/27/22 SCALE: AS NOTED

	REVISIONS	
REV. NO.	DESCRIPTION	DATE

SET TYPE: BID LETTING

SHEET NUMBER:

D.02

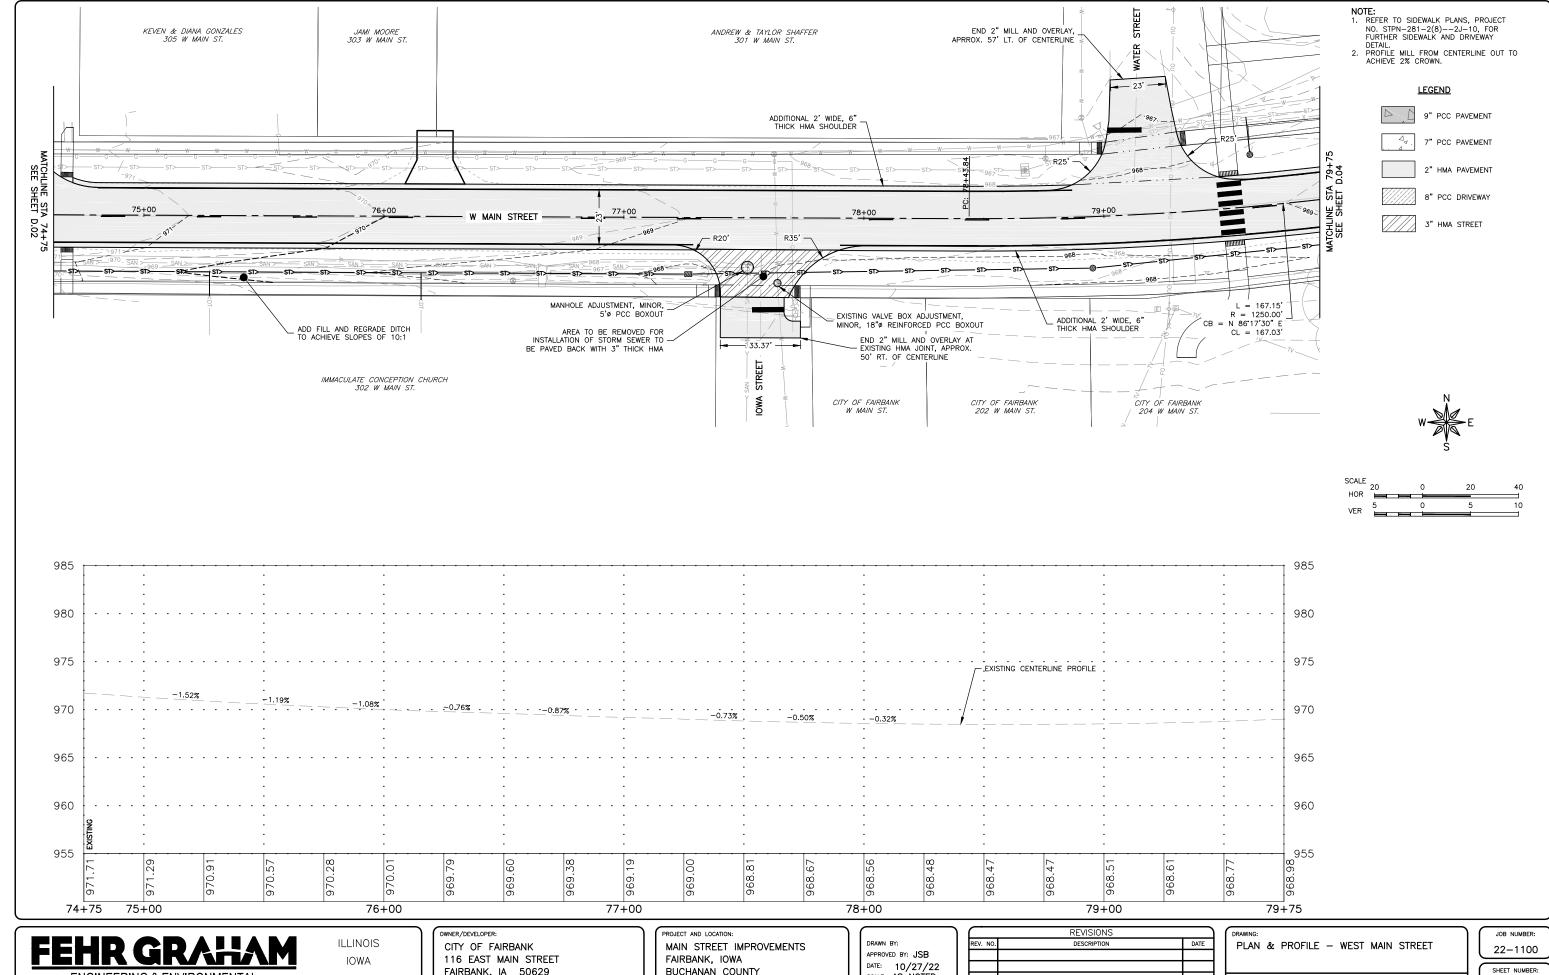

PLOT DATE: 10/31/22 © 2022 FEHR GRAHAM

ENGINEERING & ENVIRONMENTAL

WISCONSIN

FAIRBANK, IA 50629


BUCHANAN COUNTY STPN-281-2(10)--2J-10

DATE: 10/27/22 SCALE: AS NOTED

REVISIONS					
REV. NO.	DESCRIPTION	DATE			

SET TYPE: BID LETTING

D.03

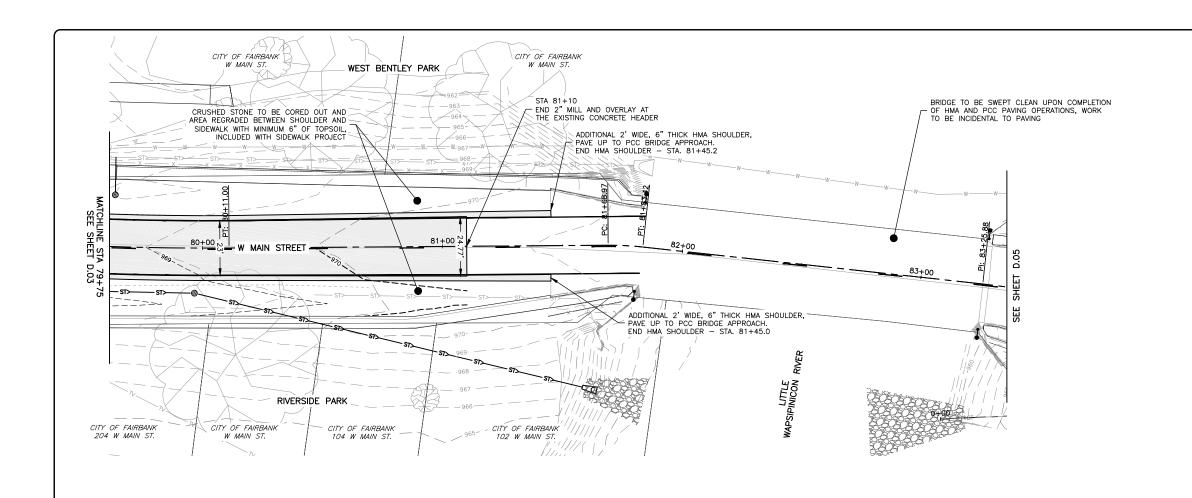



NOTE:

1. REFER TO SIDEWALK PLANS, PROJECT
NO. STPN-281-2(8)--2J-10, FOR
FURTHER SIDEWALK AND DRIVEWAY
DETAIL.


2. PROFILE MILL FROM CENTERLINE OUT TO
ACHIEVE 2% CROWN.

LEGEND

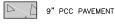


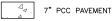




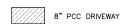



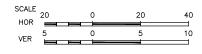

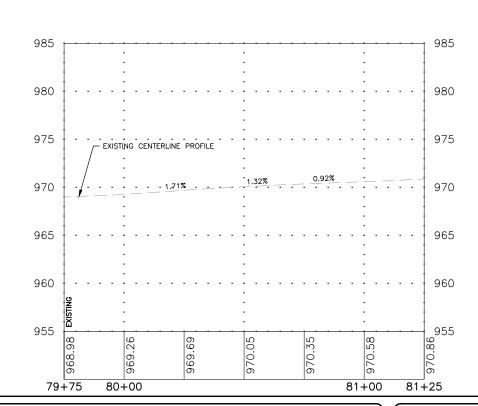

ENGINEERING & ENVIRONMENTAL

ILLINOIS IOWA WISCONSIN OWNER/DEVELOPER: CITY OF FAIRBANK 116 EAST MAIN STREET FAIRBANK, IA 50629

PROJECT AND LOCATION: MAIN STREET IMPROVEMENTS FAIRBANK, IOWA BUCHANAN COUNTY STPN-281-2(10)--2J-10

DRAWN BY: AFC APPROVED BY: JSB DATE: 10/27/22 SCALE: AS NOTED


=	REVISIONS				
REV. NO.	DESCRIPTION	DATE			

PLAN & PROFILE - WEST MAIN STREET

SET TYPE: BID LETTING

JOB NUMBER: 22-1100

> SHEET NUMBER: D.04

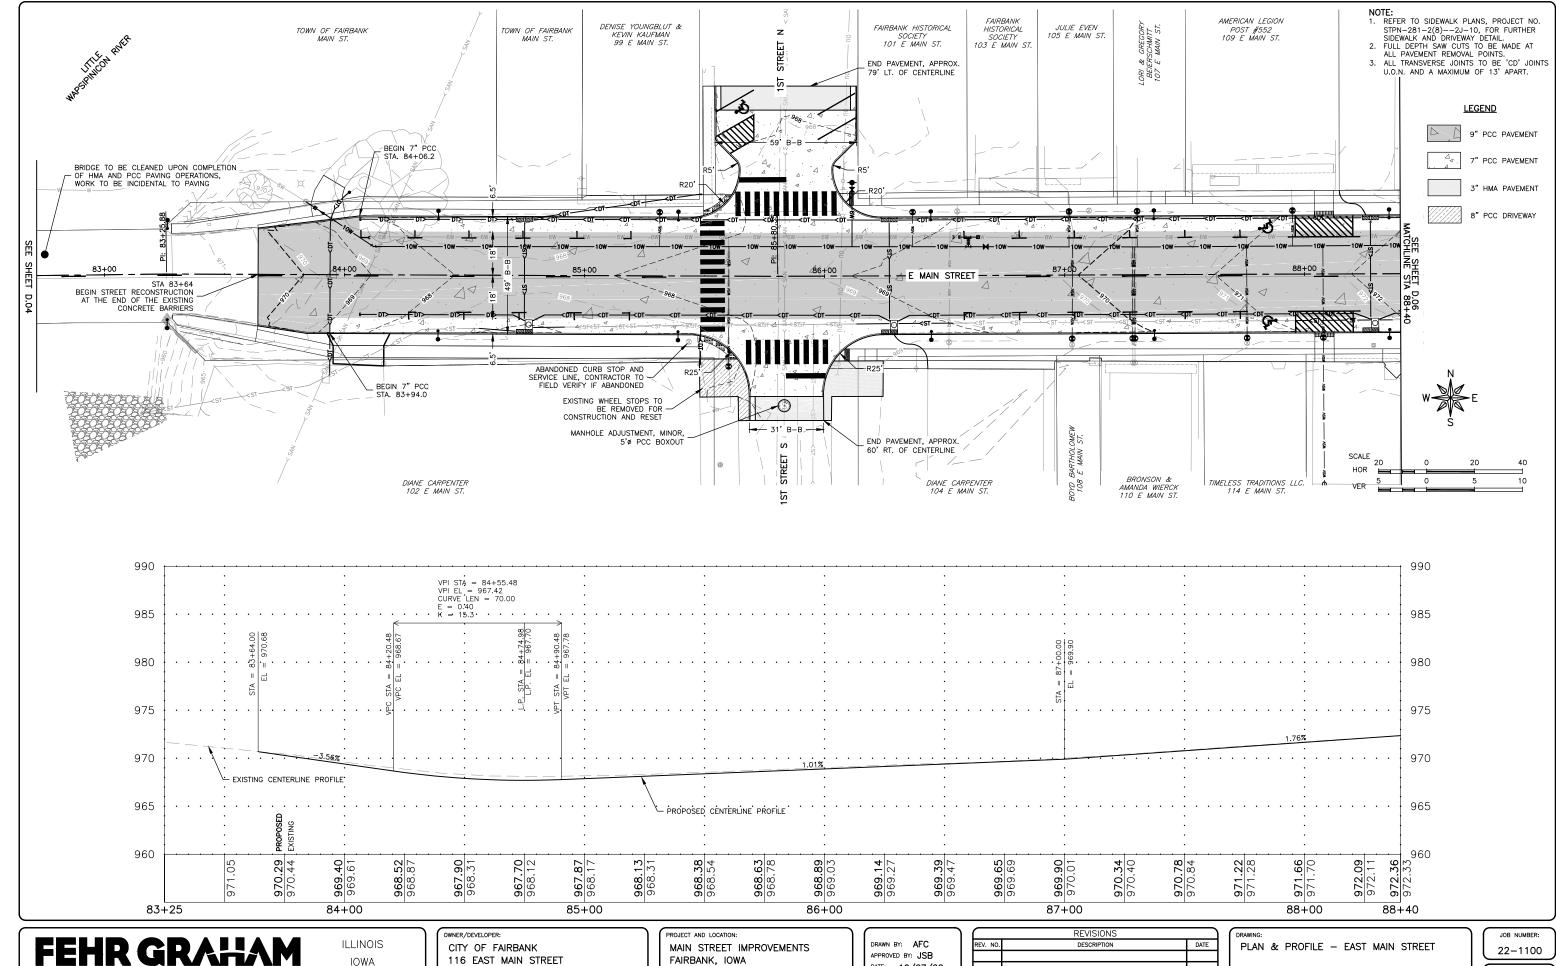

ENGINEERING & ENVIRONMENTAL

IOWA WISCONSIN 116 EAST MAIN STREET FAIRBANK, IA 50629


FAIRBANK, IOWA BUCHANAN COUNTY STPN-281-2(10)--2J-10


APPROVED BY: JSB DATE: 10/27/22 SCALE: AS NOTED

REVISIONS		
REV. NO.	DESCRIPTION	DATE
	·	

SET TYPE: BID LETTING

SHEET NUMBER: D.05

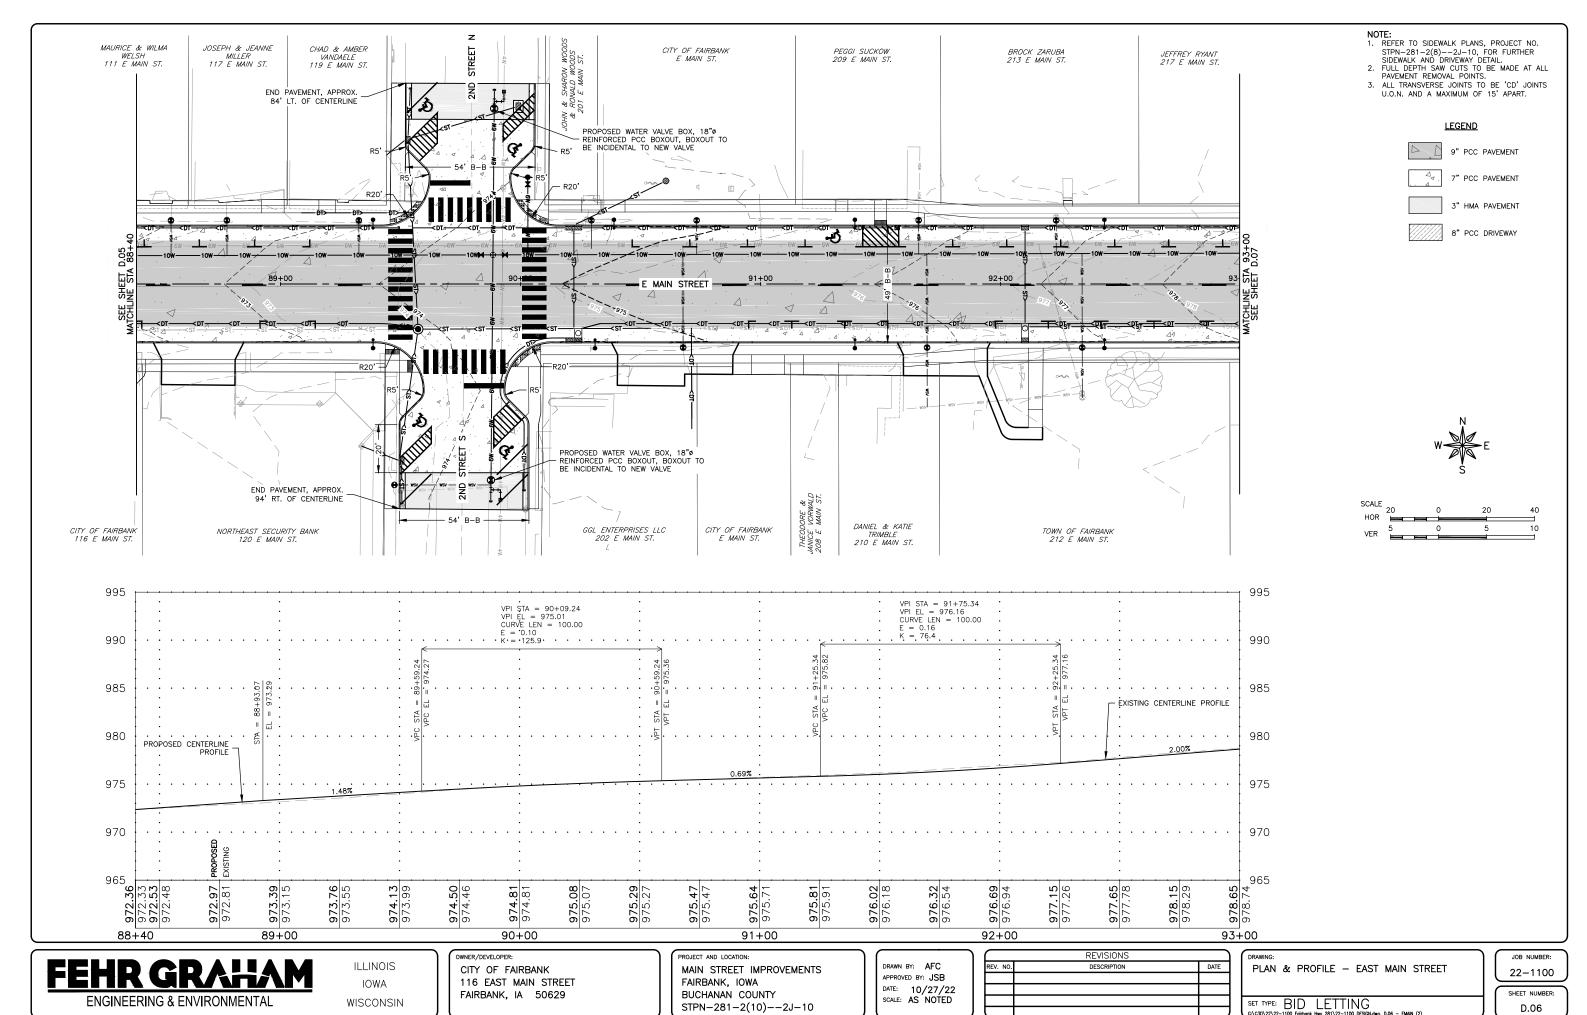

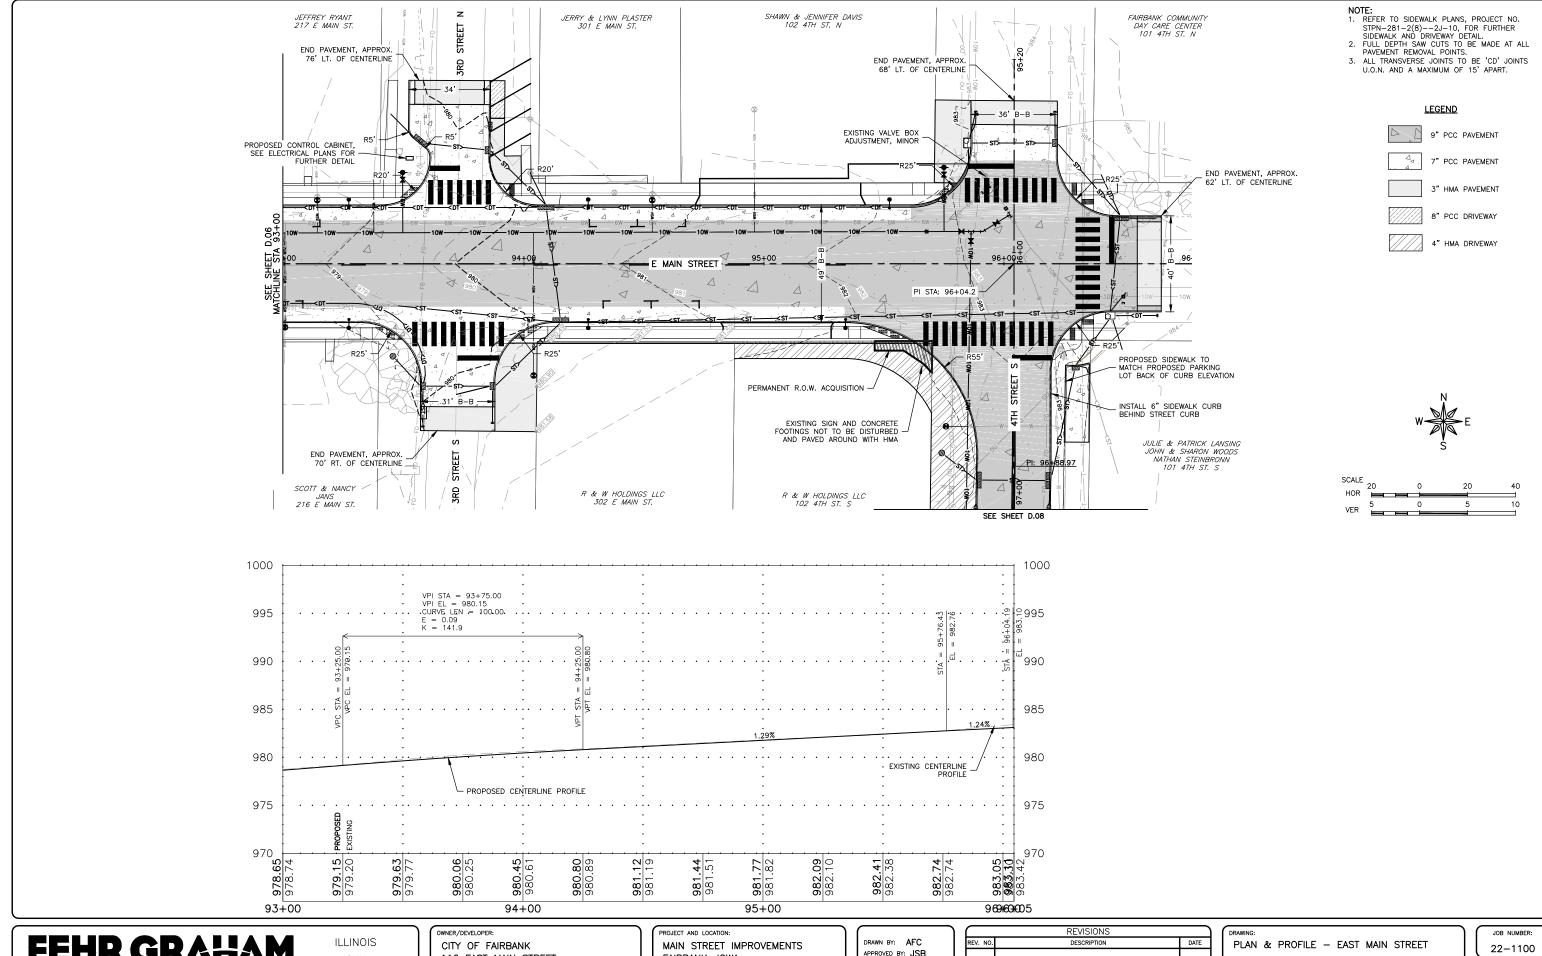

ENGINEERING & ENVIRONMENTAL

IOWA WISCONSIN

116 EAST MAIN STREET FAIRBANK, IA 50629

FAIRBANK, IOWA BUCHANAN COUNTY STPN-281-2(10)--2J-10


APPROVED BY: JSB DATE: 10/27/22 SCALE: AS NOTED

	REVISIONS	
REV. NO.	DESCRIPTION	DATE

SET TYPE: BID LETTING

SHEET NUMBER:

D.07

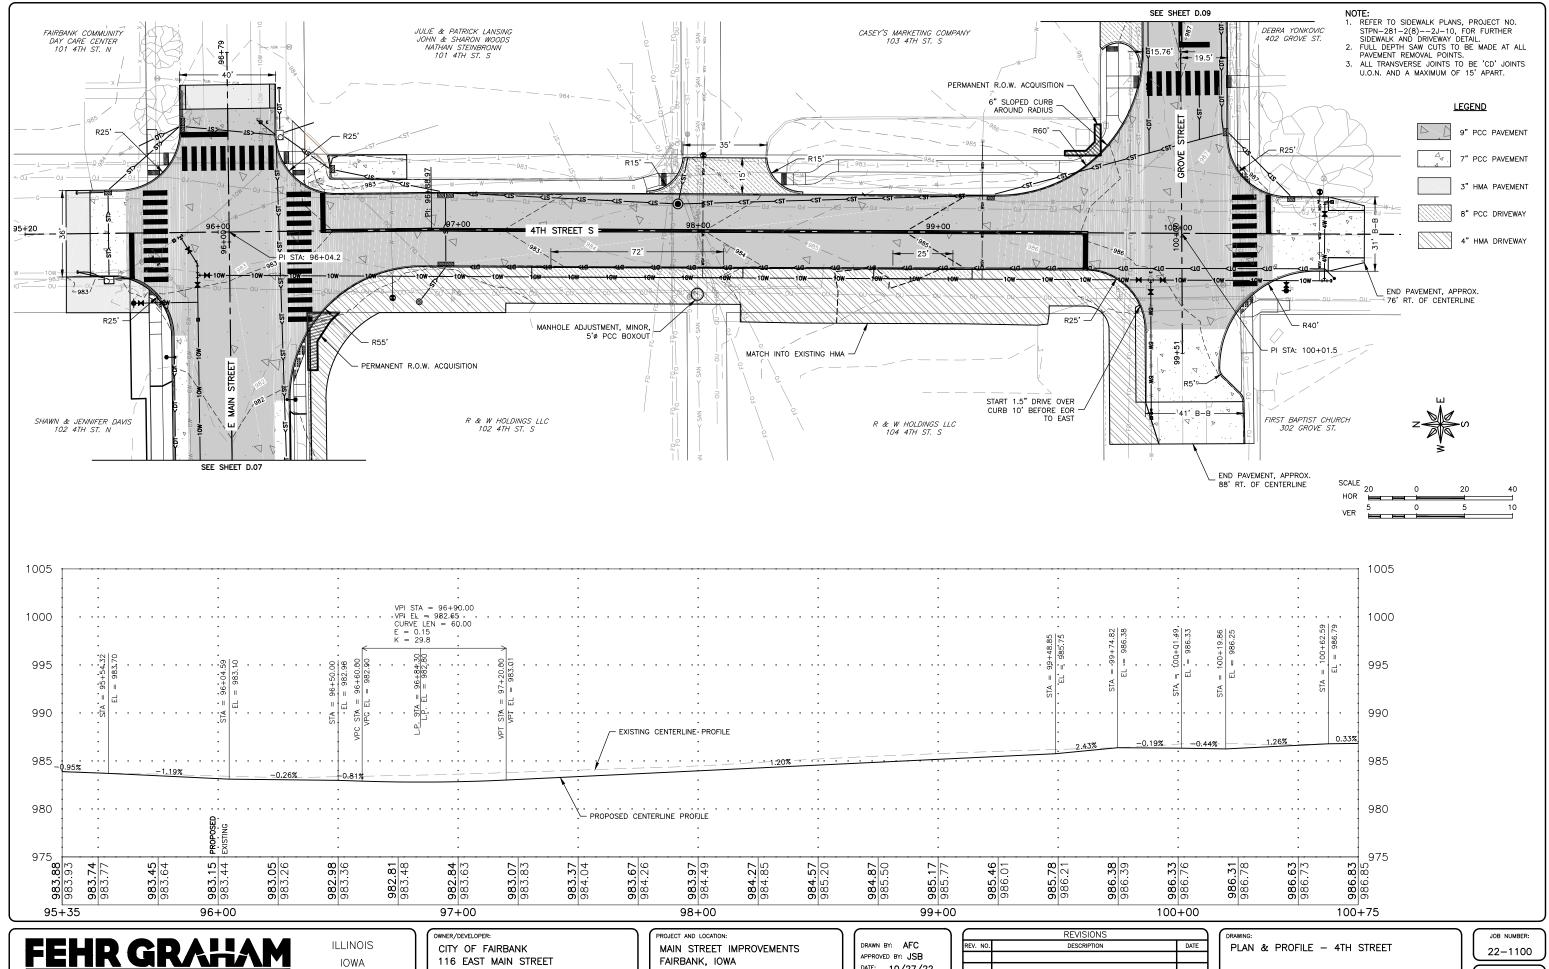

WISCONSIN

FAIRBANK, IA 50629


BUCHANAN COUNTY STPN-281-2(10)--2J-10 DATE: 10/27/22 SCALE: AS NOTED


	REVISIONS	
REV. NO.	DESCRIPTION	DATE

SET TYPE: BID LETTING

SHEET NUMBER:

D.08

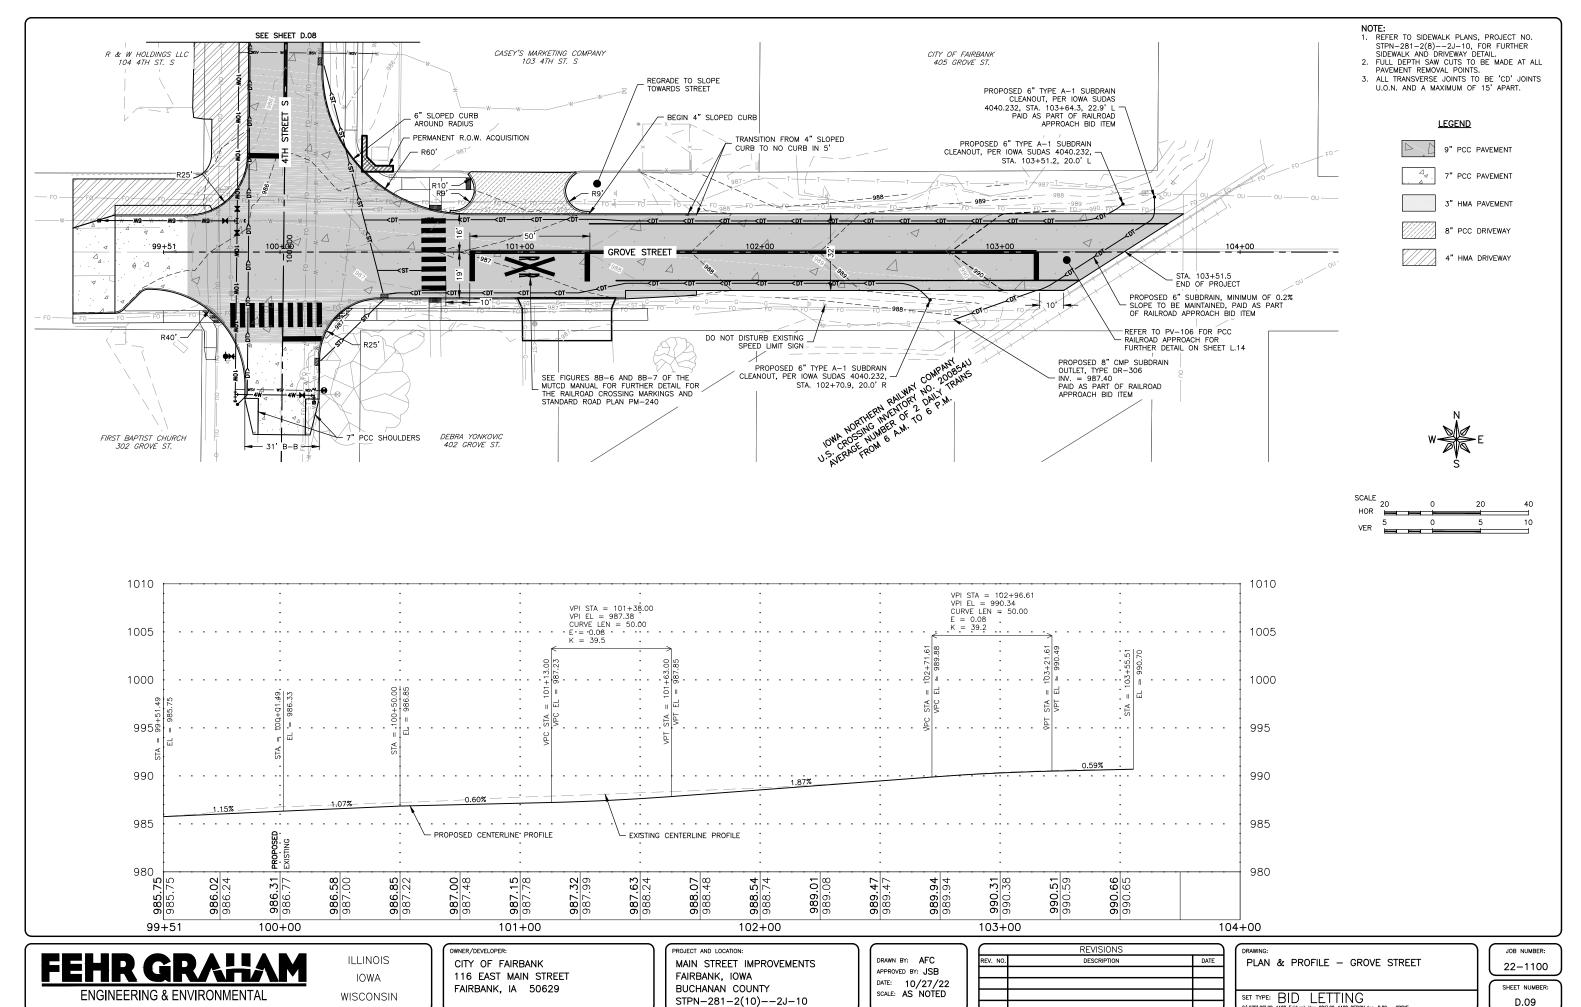

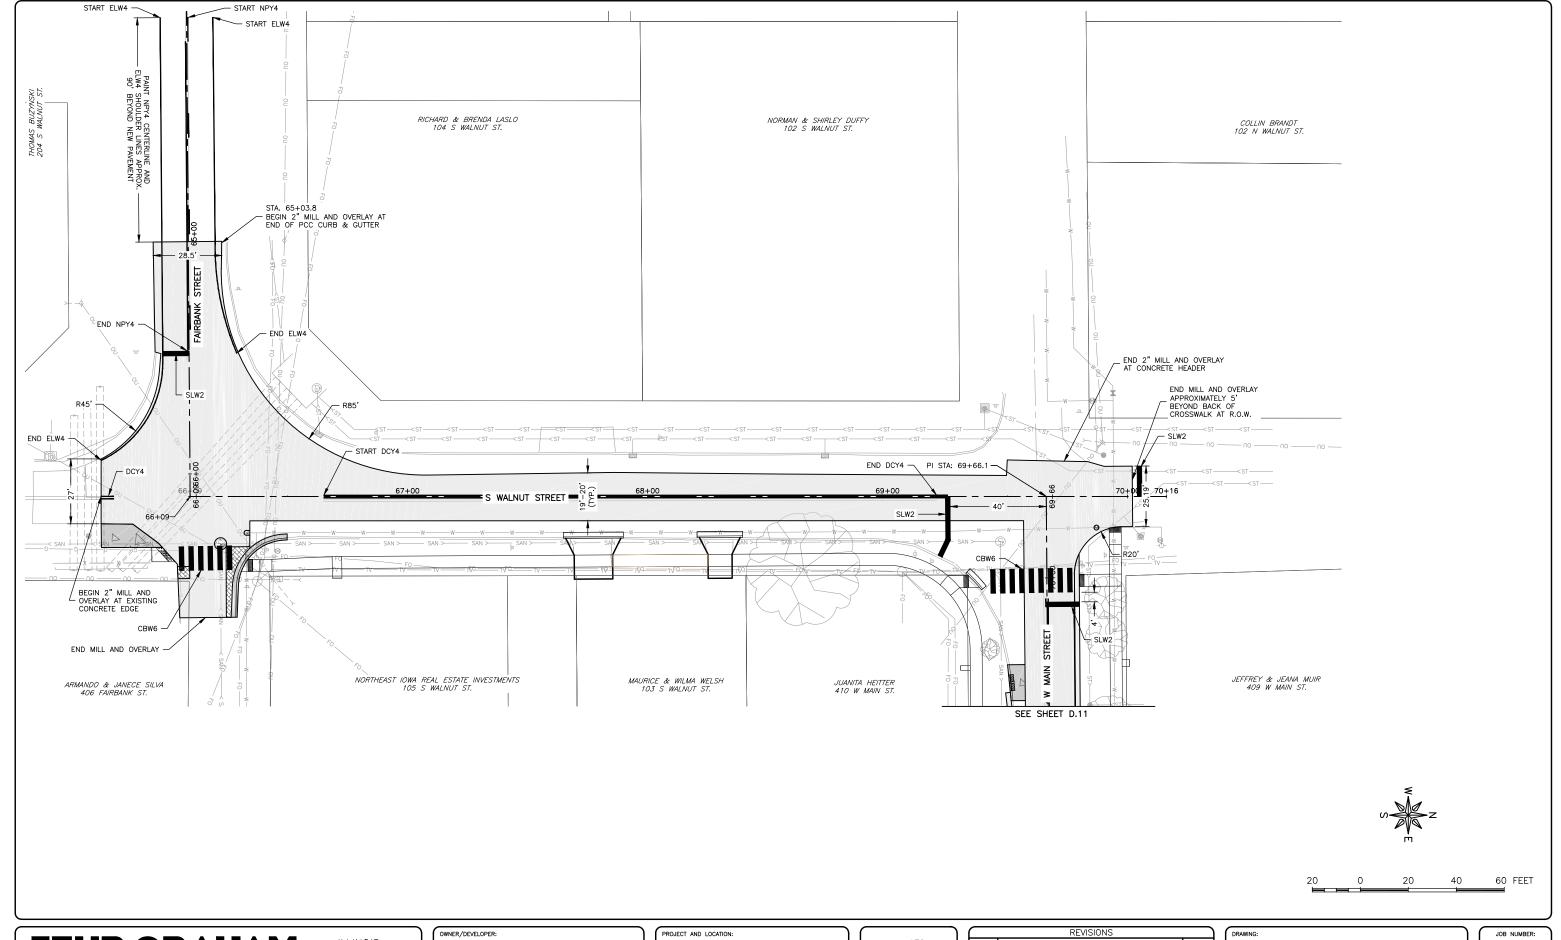

ILLINOIS IOWA WISCONSIN CITY OF FAIRBANK 116 EAST MAIN STREET FAIRBANK, IA 50629 MAIN STREET IMPROVEMENTS
FAIRBANK, IOWA
BUCHANAN COUNTY
STPN-281-2(10)--2J-10

DRAWN BY: AFC
APPROVED BY: JSB
DATE: 10/27/22
SCALE: AS NOTED

	REVISIONS	
REV. NO.	DESCRIPTION	DATE

DRAWING:
PAVEMENT MARKINGS - WALNUT STREET


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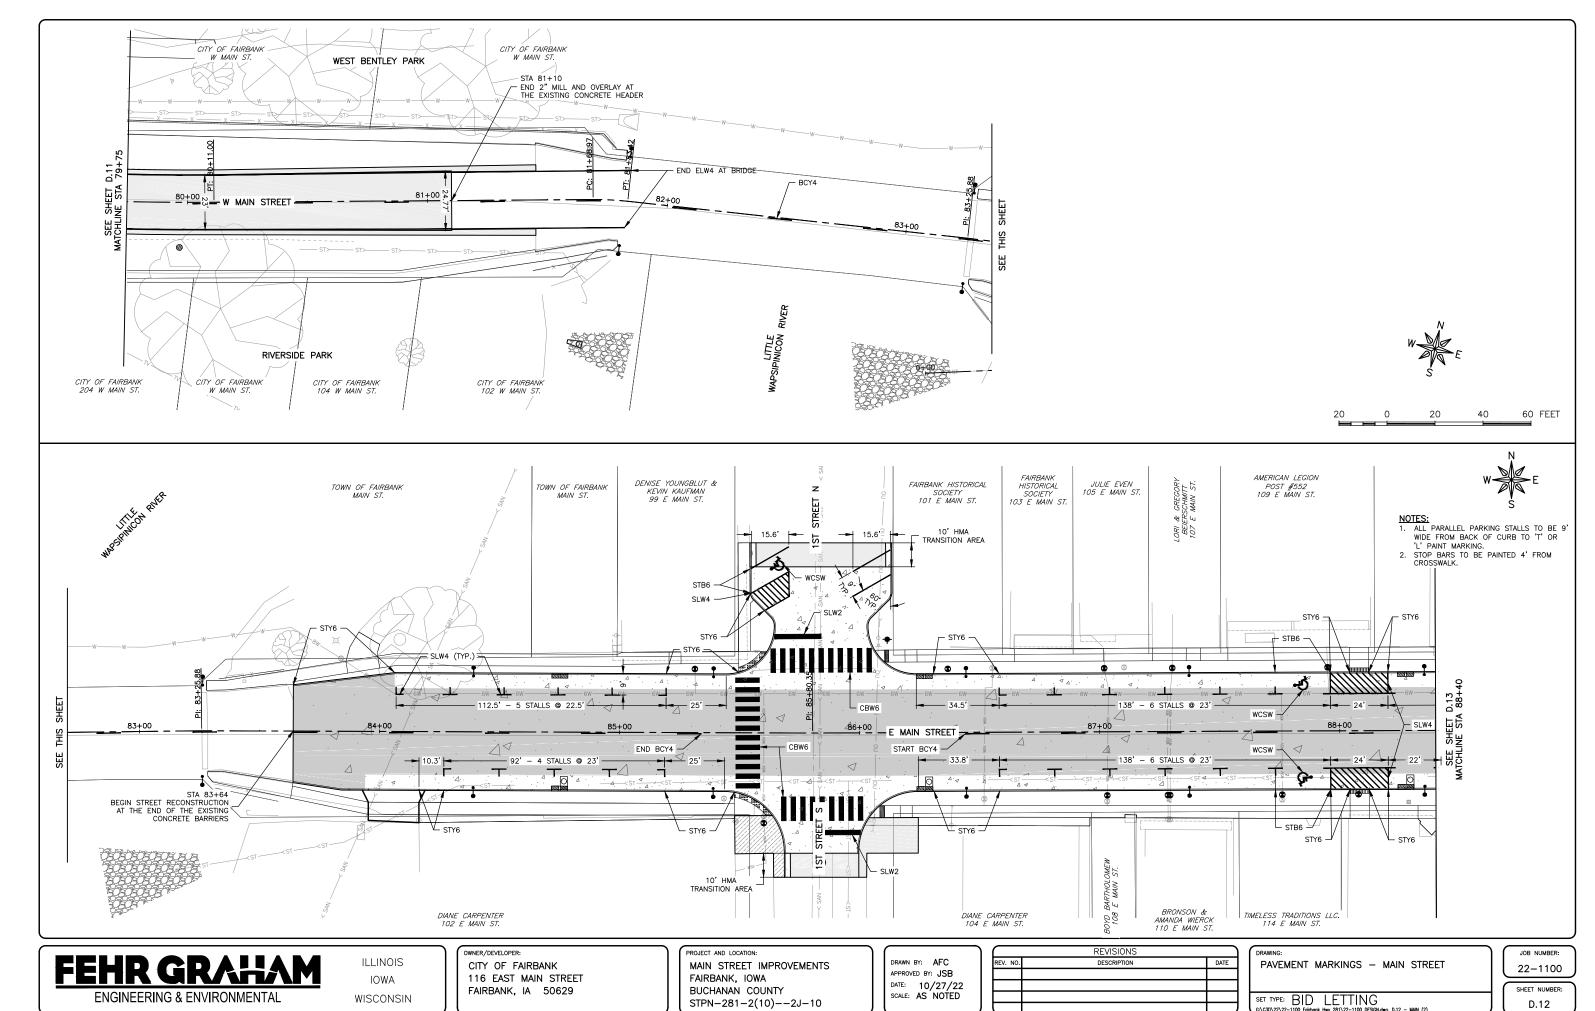
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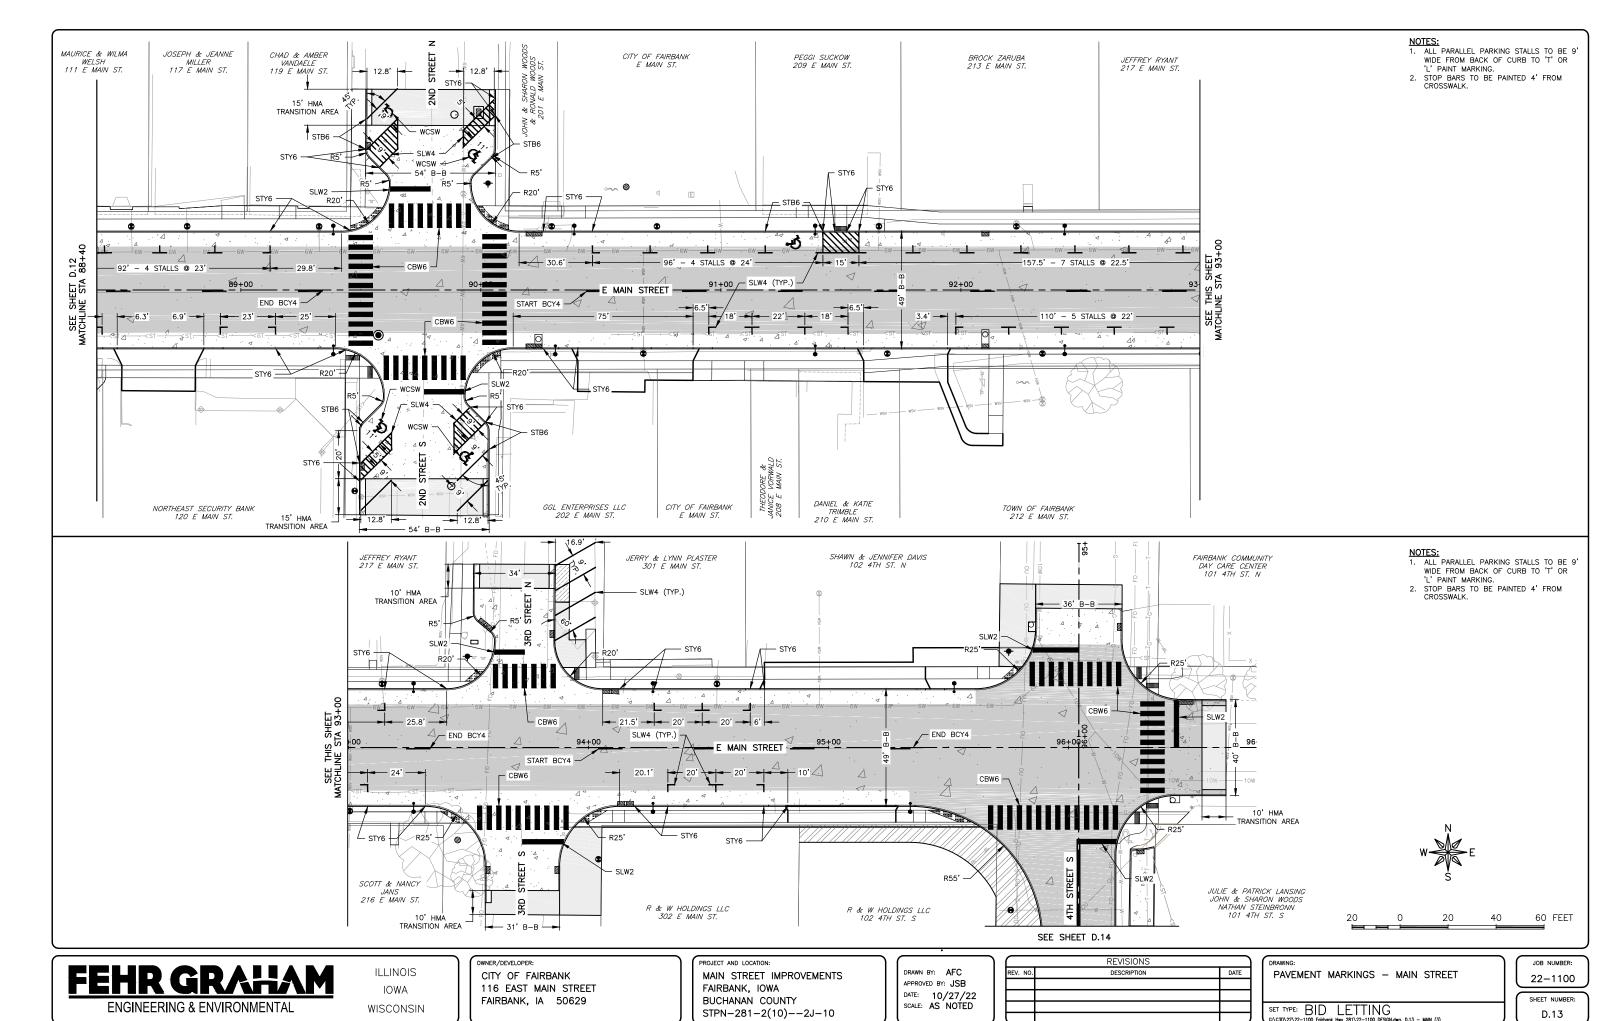
22-1100


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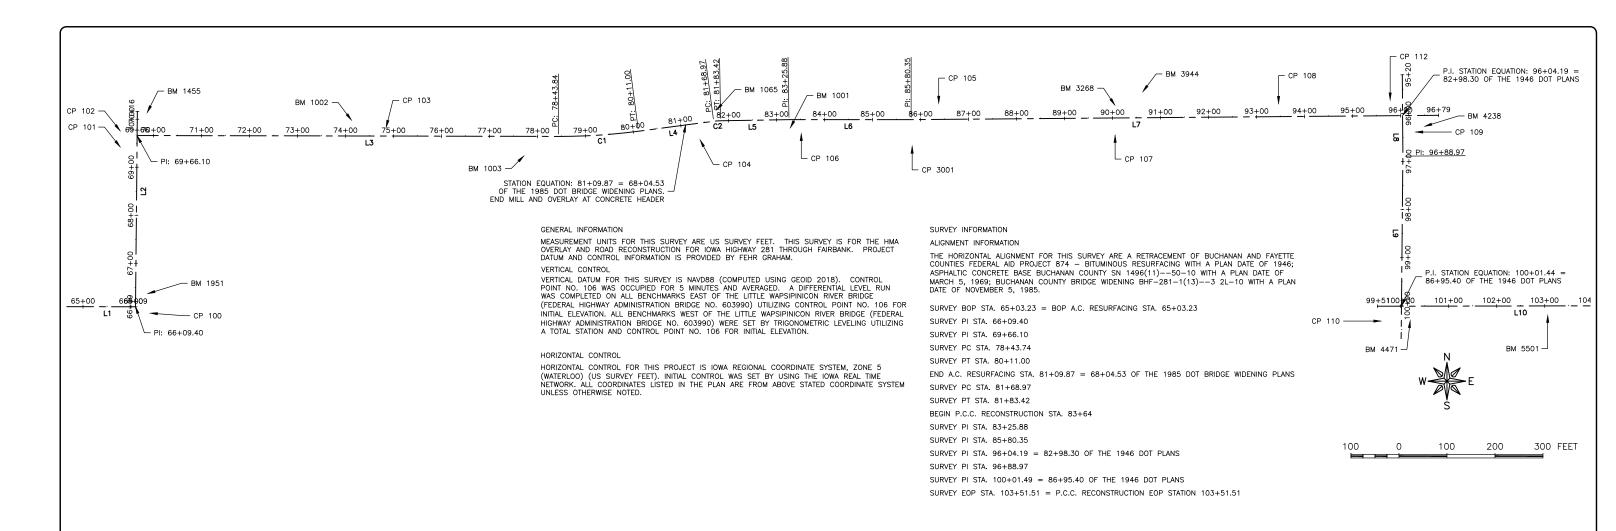
D.10







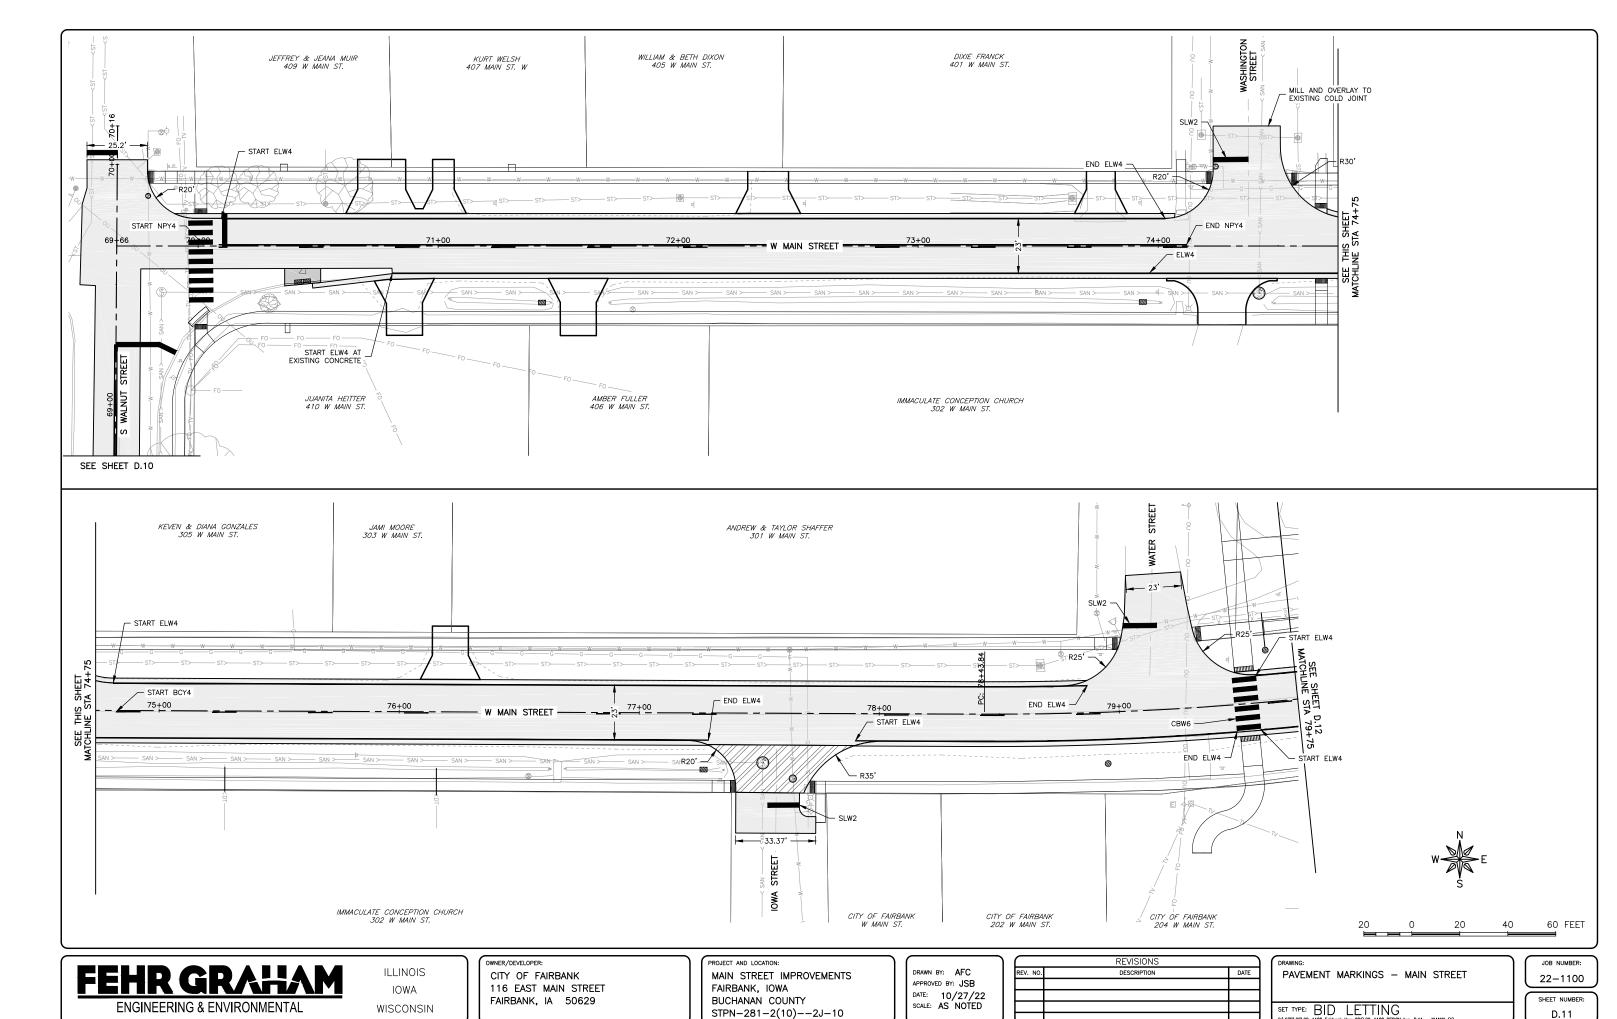

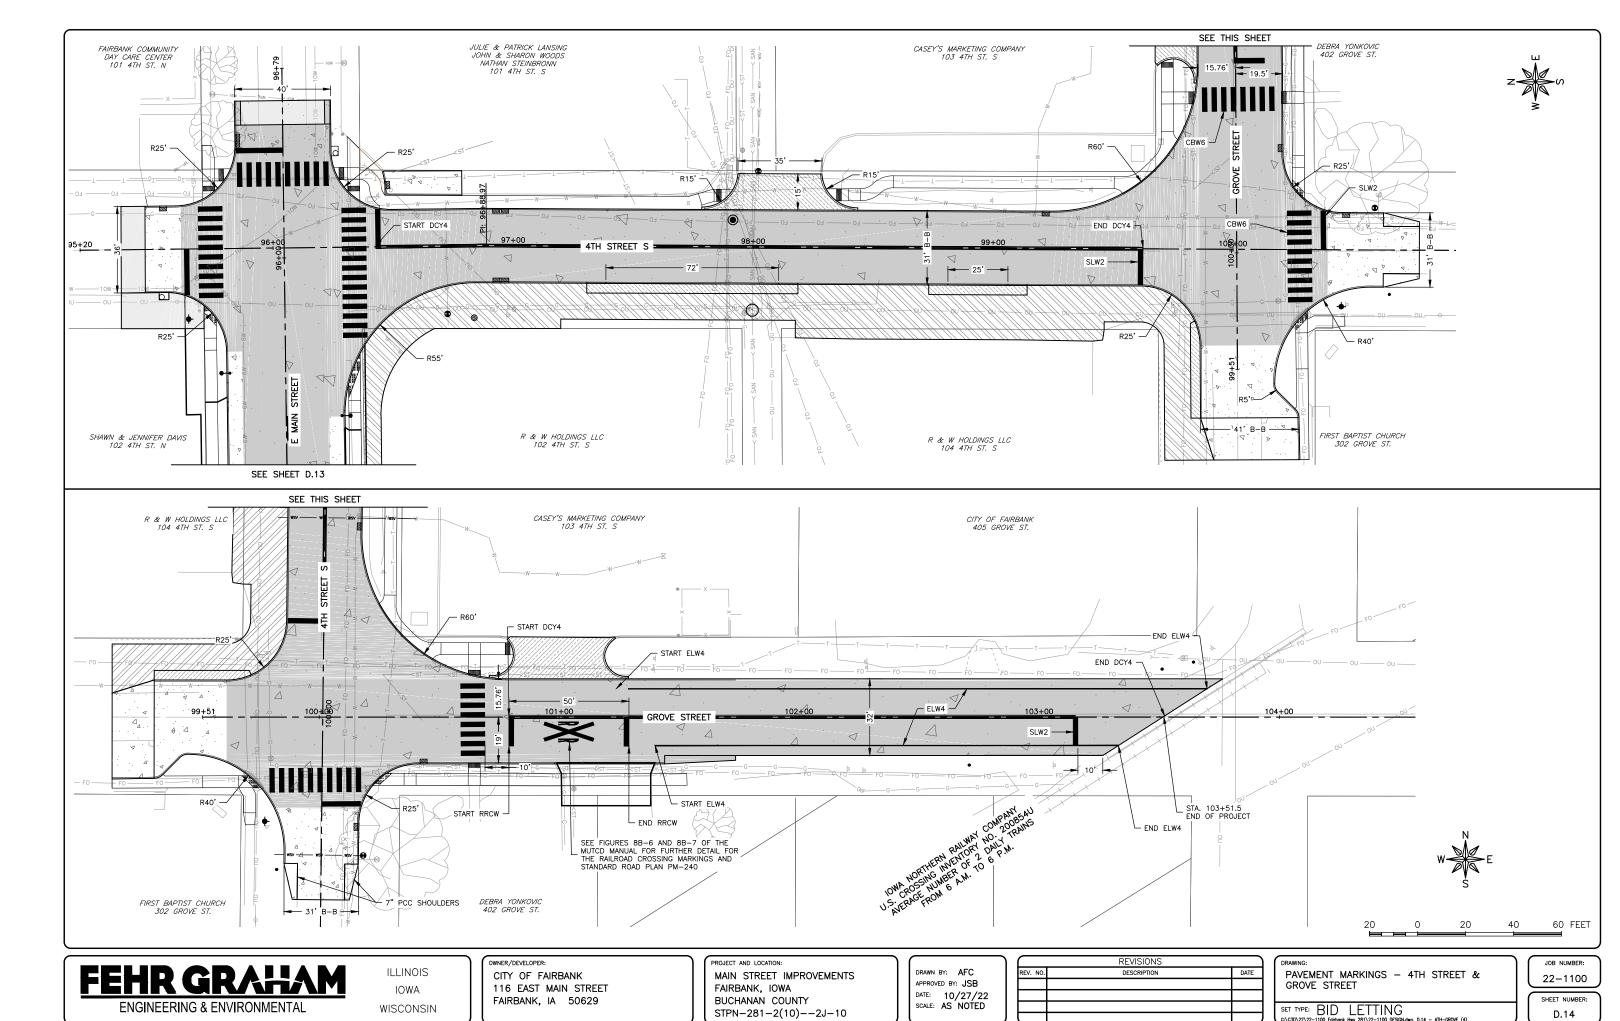

					А	LIGNMENT	COORDINAT	ΓES					
				Thi	s Data Entry S	Sheet fills Tab	101-16 MODIFIED	effective 10	-20-09				
			Point on Tanger	nt		Begin Curve		Simple C	urve PI or Maste	r PI of SCS		End Curve	
Name	Location	Chat.	Coord	inates	Chahian	Coord	inates	Chat.	Coord	linates	Chahian	Coord	inates
		Station	Y (Northing)	X (Easting)	Station	Y (Northing)	X (Easting)	Station	Y (Northing)	X (Easting)	Station	Y (Northing)	X (Easting)
L1	FAIRBANK ST.	65+03.23	8,895,774.38	15,551,784.27									
L2	WALNUT ST.	66+09.40	8,895,774.14	15,551,890.44									
L3	MAIN ST.	69+66.10	8,896,130.83	15,551,893.85									
C1	MAIN ST.				78+43.84	8,896,128.95	15,552,771.59	79+27.48	8,896,128.77	15,552,855.36	80+11.00	8,896,139.76	15,552,938.27
L4	MAIN ST.	80+11.00	8,896,139.76	15,552,938.27									
C2	MAIN ST.				81+68.97	8,896,160.48	15,553,094.88	81+76.16	8,896,161.43	15,553,102.02	81+83.42	8,896,161.55	15,553,109.28
L5	MAIN ST.	81+83.42	8,896,161.55	15,553,109.28									
L6	MAIN ST.	83+25.88	8,896,163.83	15,553,251.72									
L7	MAIN ST.	85+80.35	8,896,163.88	15,553,506.19									
L8	4TH ST.	96+04.19	8,896,172.29	15,554,530.00									
L9	4TH ST.	96+88.97	8,896,087.91	15,554,530.60									
L10	GROVE ST.	100+01.49	8,895,775.40	15,554,527.67									

CIRCULAR CURVE DATA								
This Data Entry Sheet fills Tab 101-17 MODIFIED effective 4-19-11								
							Remarks	
Location	ΔSCS	Curve Data						
		ΔC	T	L	R	E		
MAIN ST.		07°39'42"	83.7	167.15	1250	2.79		
MAIN ST.		06°37'19"	7.23	14.45	125	0.21		
ŀ	MAIN ST.	Location ΔSCS MAIN ST.	This Data Entry Sheet fills Tab Location ΔSCS ΔC MAIN ST. 07'39'42"	This Data Entry Sheet fills Tab 101-17 MODIFI Location ΔSCS ΔC T MAIN ST. 07'39'42" 83.7	This Data Entry Sheet fills Tab 101-17 MODIFIED effective 4- Location $\Delta SCS = \frac{\Delta C}{\Delta C} = \frac{T}{L}$ MAIN ST. $07^{\circ}39^{\circ}42^{\circ\prime\prime} = 83.7 = 167.15$	This Data Entry Sheet fills Tab 101-17 MODIFIED effective 4-19-11 Location ΔSCS Curve Data ΔC T L R MAIN ST. 07'39'42" 83.7 167.15 1250	This Data Entry Sheet fills Tab 101-17 MODIFIED effective 4-19-11 Location ΔSCS Curve Data ΔC T L R E MAIN ST. 07'39'42" 83.7 167.15 1250 2.79	

		SURVEY	CONTROL	INFORMATION
CONTROL POIN	ITS			
POINT NUMBER	NORTHING	EASTING	ELEVATION	DESCRIPTION
CP 100	8895760.81	15551921.22	976.15	1/2" REBAR WITH FG ORANGE CAP
CP 101	8896107.09	15551858.44	976.30	CUT "X" NE INTK PCC
CP 102	8896140.63	15551858.48	976.89	1/2" REBAR WITH ALUMINUM FG CAP, OLD CP5
CP 103	8896147.78	15552412.59	970.91	1/2" REBAR WITH FG ORANGE CAP
CP 104	8896121.74	15553066.71	970.22	1/2" REBAR WITH FG ORANGE CAP
CP 105	8896197.90	15553563.76	969.31	CUT "X"
CP 106	8896134.99	15553277.43	970.07	1/2" REBAR WITH FG ORANGE CAP
CP 107	8896131.22	15553931.27	974.71	CUT "X"
CP 108	8896197.49	15554271.73	979.77	1/2" REBAR WITH FG ORANGE CAP
CP 109	8896138.05	15554557.37	983.34	1/2" REBAR WITH FG ORANGE CAP
CP 110	8895744.33	15554484.97	986.30	1/2" REBAR WITH FG ORANGE CAP
CP 112	8896204.86	15554504.25	982.42	MAG NAIL
CP 3041	8896190.22	15553480.74	968.11	CUT "X" ON NORTH SANITARY RIM
BENCHMARKS				
BM 1001	8896147.20	15553254.77	974.06	FIRE HYDRANT - CUT "X" SOUTH WALL, EAST OF BRIDGE
BM 1002	8896162.94	15552340.21	973.58	FIRE HYDRANT - CUT "X" ON BURY BOLT
BM 1003	8896088.24	15552699.40	968.78	FIRE HYDRANT - CUT "X" ON MUELLER BOLT
BM 1065	8896183.89	15553100.64	972.20	FIRE HYDRANT - TOP ROUND BOLT
BM 1455	8896178.70	15551914.80	977.77	FIRE HYDRANT - NE BURY BOLT
BM 1951	8895801.48	15551916.20	979.15	FIRE HYDRANT - TOP BOLT
BM 3268	8896194.23	15553930.58	976.21	FIRE HYDRANT - CUT "X" ON NW BURY BOLT
BM 3944	8896222.22	15553989.01	975.47	FIRE HYDRANT - BURY TAG BOLT
BM 4238	8896150.00	15554576.19	984.63	FIRE HYDRANT - CUT "X" SE BURY BOLT
BM 4471	8895745.47	15554546.09	989.19	FIRE HYDRANT - CUT "X" SW BURY BOLT
BM 5501	8895756.28	15554832.56	990.72	NW ANCHOR BOLT ON RR CROSSING SIGN
	•	•		



CITY OF FAIRBANK 116 EAST MAIN STREET FAIRBANK, IA 50629 PROJECT AND LOCATION:

MAIN STREET IMPROVEMENTS
FAIRBANK, IOWA
BUCHANAN COUNTY
STPN-281-2(10)--2J-10

DRAWN BY: AFC
APPROVED BY: JSB
DATE: 10/27/22
SCALE: AS NOTED

$\overline{}$	REVISIONS	
REV. NO.	DESCRIPTION	DATE
\Box		

DRAWING:
BENCHMARKS & CENTERLINE DATA

SET TYPE: BID LETTING

JOB NUMBER:

22-1100

SHEET NUMBER:

G.01



ILLINOIS IOWA WISCONSIN owner/developer: CITY OF FAIRBANK 116 EAST MAIN STREET FAIRBANK, IA 50629 PROJECT AND LOCATION:

MAIN STREET IMPROVEMENTS
FAIRBANK, IOWA
BUCHANAN COUNTY
STPN-281-2(10)--2J-10

DRAWN BY: AFC
APPROVED BY: JSB
DATE: 10/27/22
SCALE: AS NOTED

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REV. NO.	DESCRIPTION	DATE	
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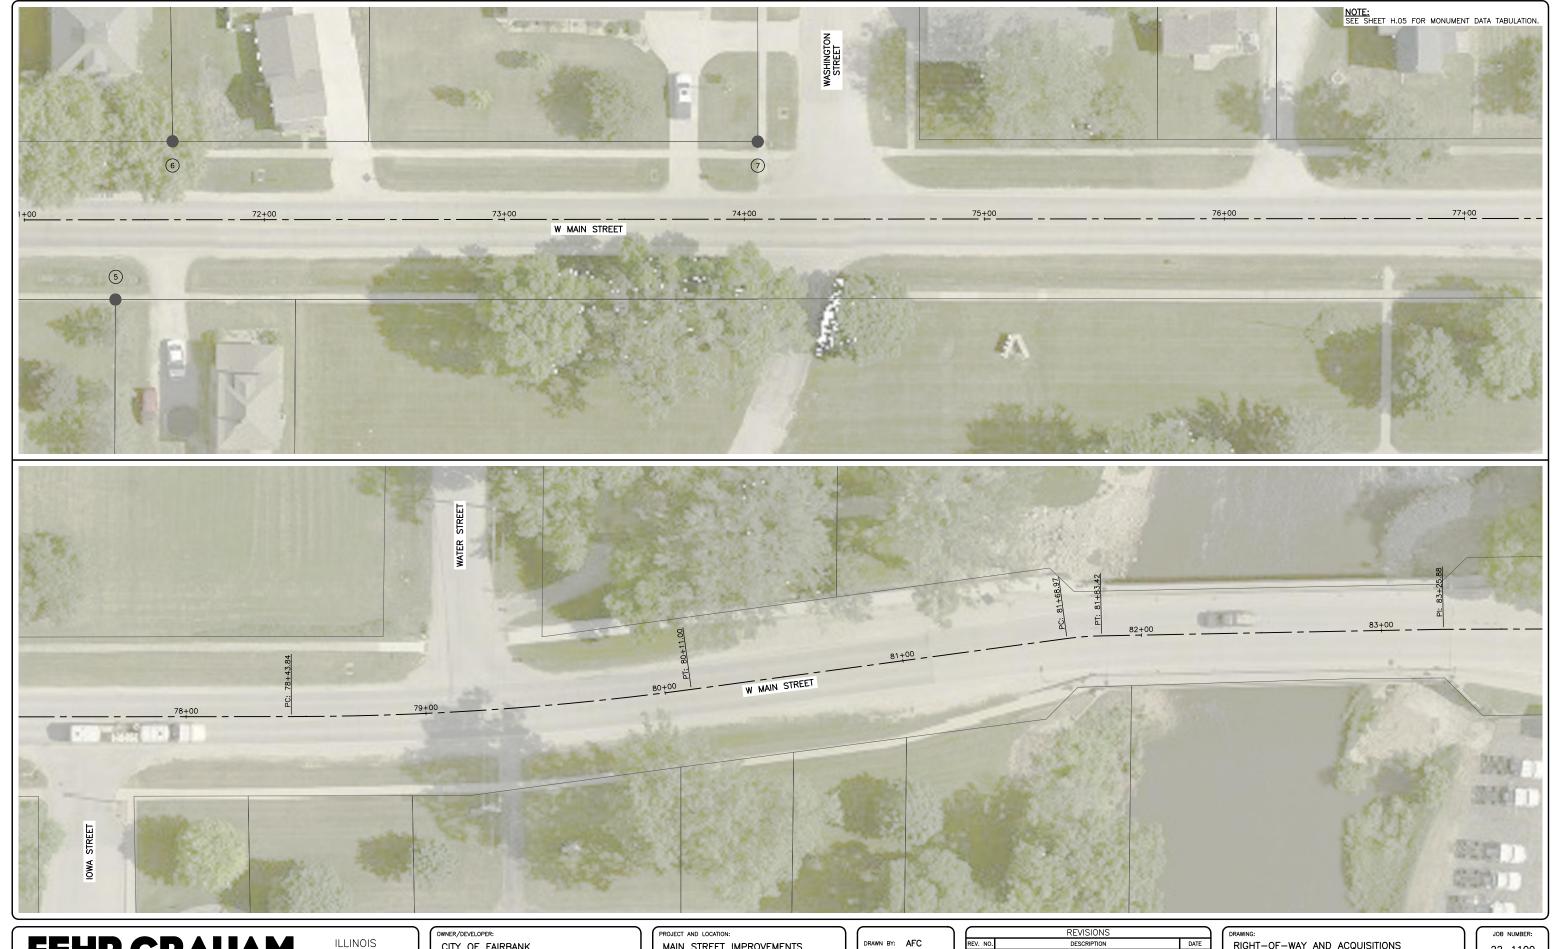
DRAWING:
RIGHT-OF-WAY AND ACQUISITIONS

SET TYPE: BID LETTING

G\(C30\22\22-1100 Fairbank Hwy 281\Plans\22-1100 PLANS.dwg, H.01

JOB NUMBER: 22-1100

H.O1



ILLINOIS IOWA WISCONSIN CITY OF FAIRBANK 116 EAST MAIN STREET FAIRBANK, IA 50629

PROJECT AND LOCATION:

MAIN STREET IMPROVEMENTS
FAIRBANK, IOWA BUCHANAN COUNTY STPN-281-2(10)--2J-10

APPROVED BY: JSB
DATE: 10/27/22
SCALE: AS NOTED


$\overline{}$	REVISIONS		1
REV. NO.	DESCRIPTION	DATE	

RIGHT-OF-WAY AND ACQUISITIONS

SET TYPE: BID LETTING

22-1100

H.02

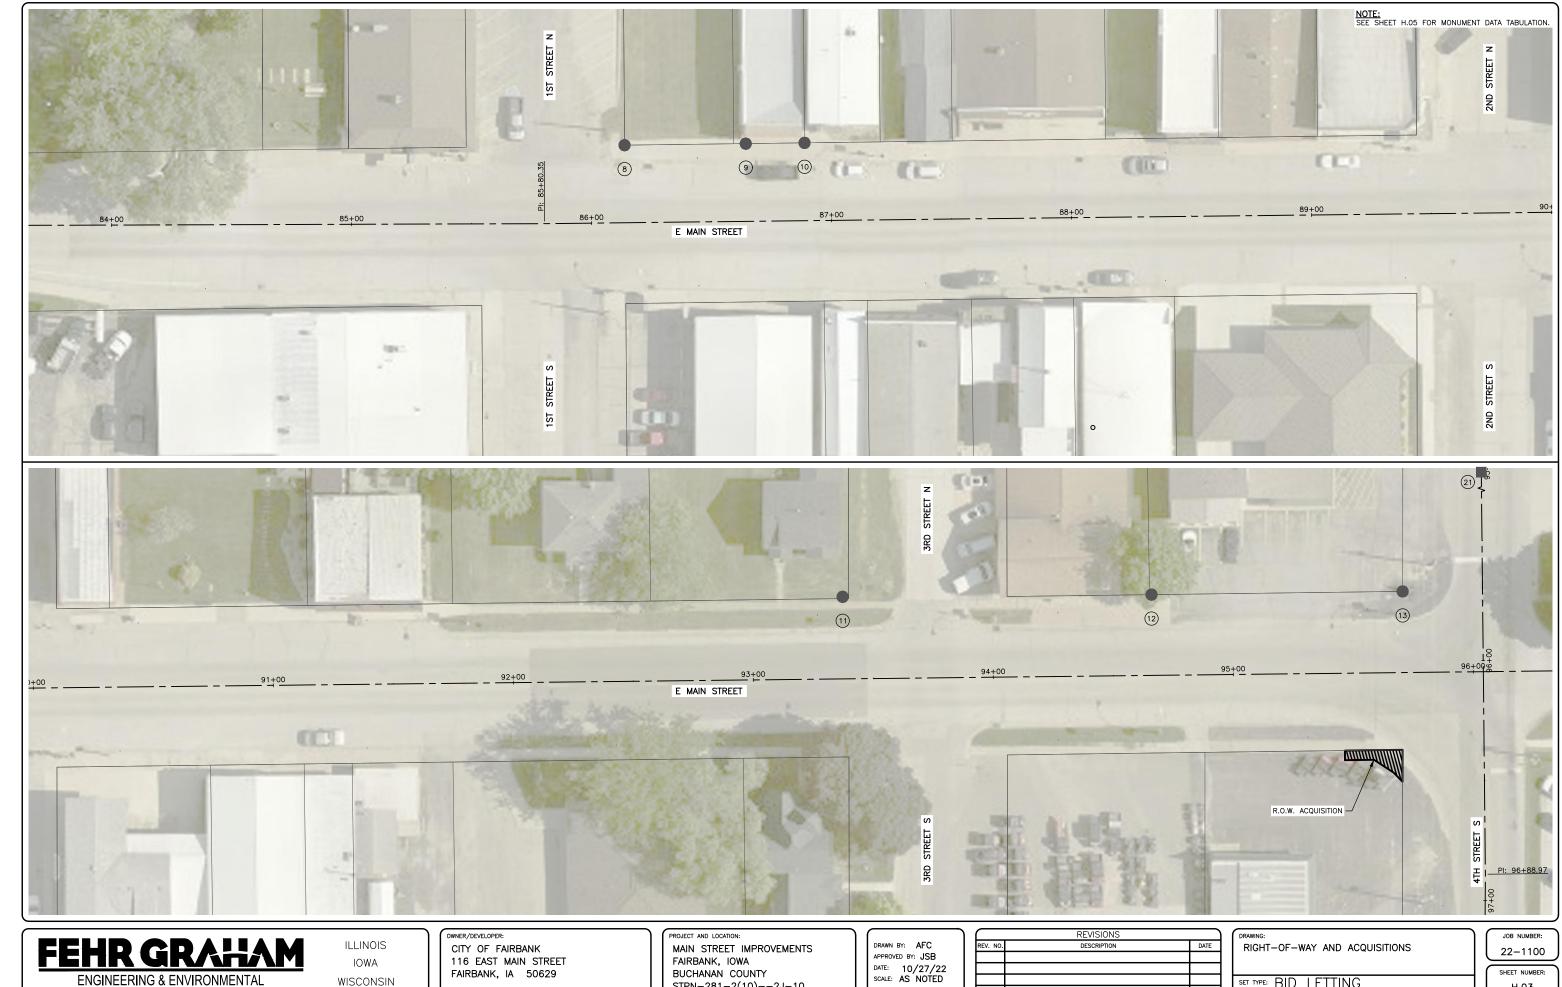

WISCONSIN

FAIRBANK, IA 50629

BUCHANAN COUNTY STPN-281-2(10)--2J-10

APPROVED BY: JSB


DATE: 10/27/22

SCALE: AS NOTED

	REVISIONS	
REV. NO.	DESCRIPTION	DATE

SET TYPE: BID LETTING

H.03

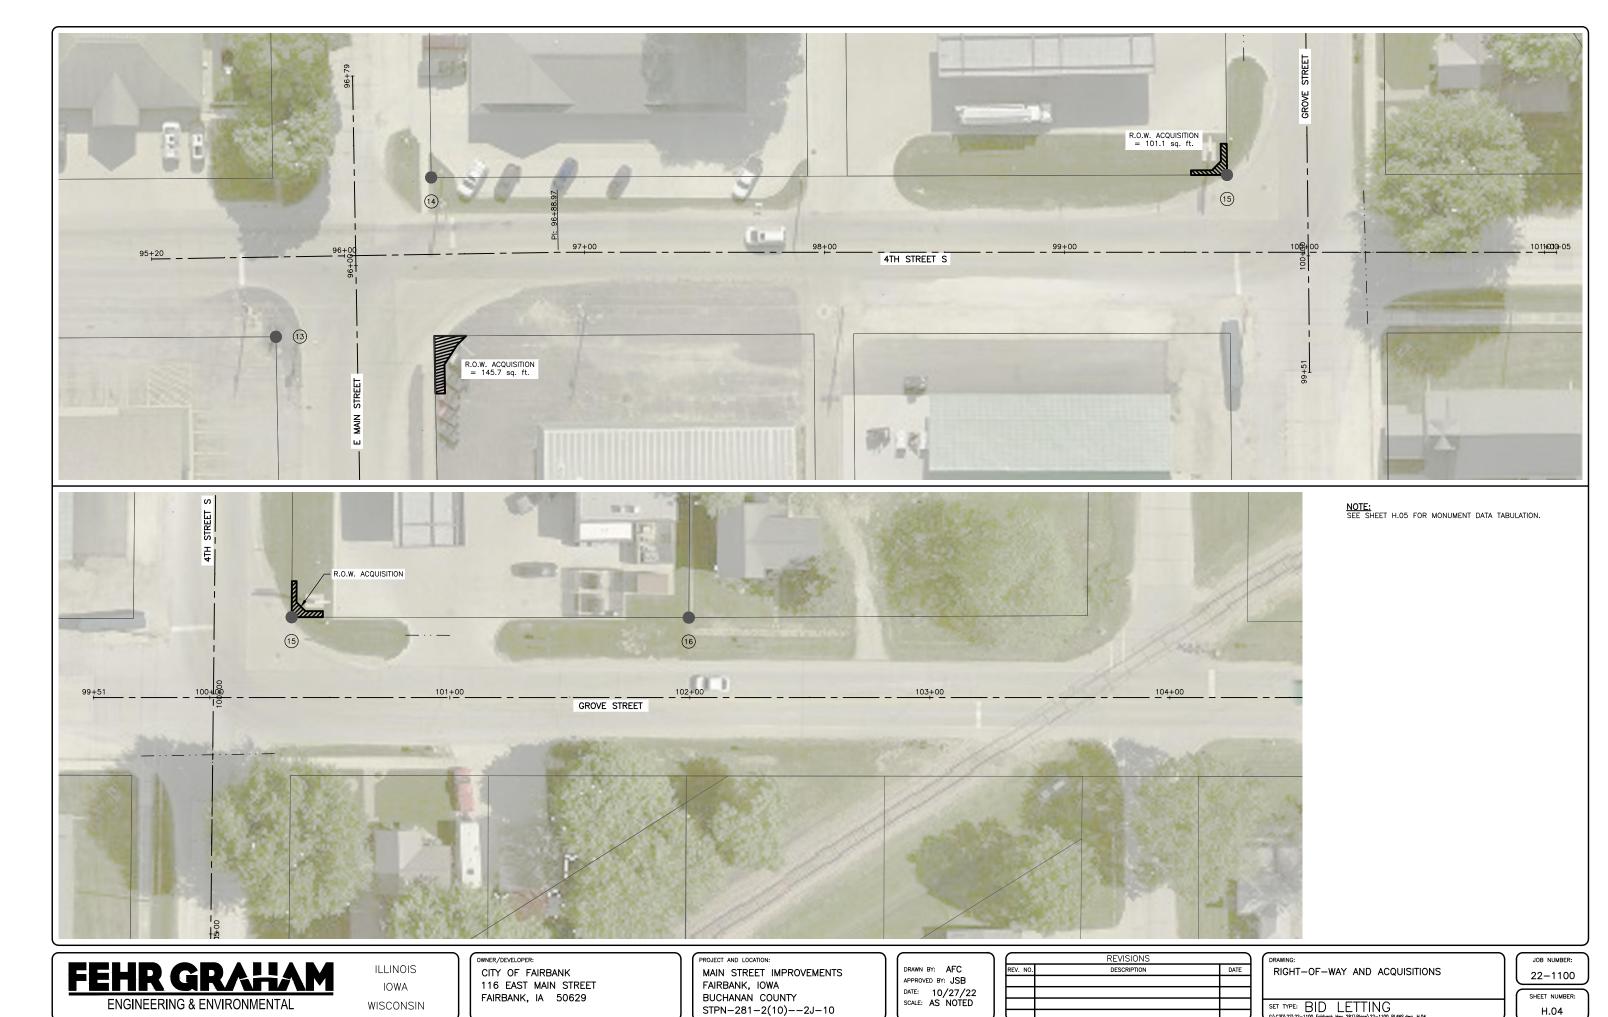

Managed But							
		Monume	nt Data				
Point Number	Road Monument	Found	Northing	Easting	Station	Offset	Point number
1	N/A	1/2" REBAR W/YPC #8812	8,895,905.99	15,551,924.72	67+41.57	33.02	6014
2	N/A	1/2" REBAR W/YPC #8812	8,895,934.67	15,551,925.00	67+70.25	32.97	6015
3	N/A	1" PIPE	8,896,005.40	15,551,925.50	68+40.98	32.85	6028
4	N/A	TBAR	8,896,163.67	15,551,927.15	69+99.26	32.98	6016
5	N/A	1/2" IRON PIN	8,896,097.31	15,552,065.66	71+37.98	33.21	6027
6	N/A	1/2" REBAR	8,896,162.99	15,552,089.60	71+61.88	-32.67	6024
7	N/A	TBAR	8,896,162.20	15,552,333.50	74+05.68	-32.31	6025
8	N/A	LEAD PLUG	8,896,196.50	15,553,539.69	86+14.11	-32.35	3433
9	N/A	LEAD PLUG	8,896,196.98	15,553,590.18	86+64.61	-32.41	3434
10	N/A	LEAD PLUG	8,896,197.23	15,553,614.68	86+89.11	-32.47	3435
11	N/A	1/2" REBAR W/YPC #9961	8,896,204.30	15,554,263.18	93+37.65	-34.20	6012
12	N/A	1/2" REBAR W/OPC	8,896,204.83	15,554,391.89	94+66.35	-33.67	6011
13	N/A	PK NAIL	8,896,205.87	15,554,496.44	95+70.98	-33.82	6010
14	N/A	TBAR	8,896,140.53	15,554,562.30	96+36.58	-32.07	6005
15	N/A	1/2" REBAR W/YPC #4640	8,895,808.95	15,554,560.22	99+67.64	-32.23	6009
16	N/A	1/2" REBAR W/YPC #4640	8,895,809.14	15,554,725.61	101+99.57	-33.33	6001
17	PI/SECTION CORNER	TORQUE SCREW WSSW IDOT	8,895,777.93	15,550,572.05	N/A	N/A	700
18	PI/SECTION CORNER	1/2" REBAR	8,895,773.94	15,551,890.44	66+09.40	0.21	704
19	PI/SECTION CORNER	1/4" IRON PIN	8,896,130.83	15,551,893.85	69+66.10	0.00	707
20	PI/SECTION CORNER	5/8" IRON PIN	8,897,199.86	15,551,905.22	N/A	N/A	705
21	PI/SECTION CORNER	MAG NAIL	8,897,209.67	15,554,544.38	N/A	N/A	714

LEGEND



OPC

YPC

FOUND SECTION CORNER AS DESCRIPTED FOUND OTHER AS DESCRIPTED FOUND ROAD POINT EXISTING PROPERTY LINE ORANGE PLASTIC CAP YELLOW PLASTIC CAP

NOTE:
PRIOR TO THE PCC PAVEMENT — REPLACE PROJECT, A SURVEY WAS PERFORMED TO LOCATE EXISTING ROAD ALIGNMENT AND SEARCH FOR PROPERTY CORNER MONUMENTS ALONG THE PROJECT RIGHT—OF—WAY, ALL WITHIN THE PUBLIC IMPROVEMENT CORRIDOR. THIS SURVEY INDICATES WHAT WAS FOUND AND WHERE IT WAS FOUND IN RELATION TO THE ALIGNMENT. THIS SURVEY IS PERFORMED TO HELP PRESERVE THE PEDIGREE OF THE MONUMENTS FOR THE ROAD ALIGNMENT.



ILLINOIS IOWA WISCONSIN OWNER/DEVELOPER: CITY OF FAIRBANK 116 EAST MAIN STREET FAIRBANK, IA 50629

PROJECT AND LOCATION: MAIN STREET IMPROVEMENTS FAIRBANK, IOWA BUCHANAN COUNTY STPN-281-2(10)--2J-10

DRAWN BY: AFC APPROVED BY: JSB
DATE: 10/27/22
SCALE: AS NOTED

$\overline{}$	REVISIONS	
REV. NO.	DESCRIPTION	DATE

MONUMENT DATA SET TYPE: BID LETTING

JOB NUMBER: 22-1100 SHEET NUMBER:

H.05

511 TRAVEL RESTRICTIONS This Data Entry Sheet fills Tab 108-25 effective 10-21-14 Construction Projected Maint. Bridge No. Location Type of Construction Feature Existing Route Direction County Object Type Structure ID, or FHWA Measurement Remarks Restriction Measurement as Signed Measurement EAST/WEST *NOTE, CONTRACTOR TO NOTIFY 511 REGARDING CONSTRUCTION WORK RESTRICTIONS REGARDING FLAGGERS AND ONE LANE TRAFFIC.

TRAFFIC CONTROL PLAN

This Data Entry Sheet fills Tab 108-23A effective 8-1-08

REFER TO TABULATION 108-26A FOR TRAFFIC CONTROL SPECIFICS.

TRAFFIC CONTROL ON THIS PROJECT SHALL BE IN ACCORDANCE WITH STANDARD ROAD PLANS LISTED ON TAB 105-4 AND AS DETAILED ELSEWHERE IN THE J SHEETS. FOR ADDITIONAL COMPLEMENTARY INFORMATION, REFER TO PART 6 OF THE MANUAL OF UNIFORM TRAFFIC CONTROL DEVICES AND THE CURRENT STANDARD SPECIFICATIONS. THE CONTRACTOR SHALL BE RESPONSIBLE FOR INSTALLING, MAINTAINING AND REMOVING ALL DETOUR AND TRAFFIC CONTROL SIGNING.

WORK THAT DIRECTLY AFFECTS TRAFFIC MOVEMENT AND FLOW, SUCH AS STAGING CHANGES, TEMPORARY STRIPING/SIGNING, ETC. SHALL NOT BE ALLOWED BETWEEN 6:00 AM FRIDAY AND 9:00 PM SUNDAY. THE ENGINEER RESERVES THE RIGHT TO MODIFY THE HOURS SPECIFIED ABOVE TO ACCOMMODATE UNEXPECTED TRAFFIC FLOWS. COORDINATE WITH THE ENGINEER A MINIMUM OF TWO (2) WEEKS PRIOR TO CHANGES IN THE PROPOSED TRAFFIC PATTERNS.

FAIRBANK ISLAND DAYS WILL TAKE PLACE FROM JUNE 21ST THROUGH JUNE 25TH 2023. CONSTRUCTION CAN PROCEED DURING FAIRBANK ISLAND DAYS, EXTRA PRECAUTION SHOULD BE TAKEN DURING THIS FESTIVAL TO MINIMIZE INCONVENIENCE TO VEHICULAR AND PEDESTRIAN USERS AS MUCH AS POSSIBLE. PLEASE COORDINATE WITH THE ENGINEER AND CITY OF FAIRBANK IN THE WEEK PRIOR TO FAIRBANK ISLAND DAYS TO DISCUSS WHAT SAFETY PRECAUTIONS CAN BE TAKEN FOR THE FESTIVAL.

CONTRACTOR TO MAINTAIN STORM WATER FLOW THROUGHOUT THE DURATION OF THE PROJECT. THE CONTRACTOR SHALL TAKE MEASURES TO PREVENT TRACKING OR SPILLING OF DIRT, MUD OR OTHER FOREIGN MATERIALS ONTO ALL STREETS.

IOWA 281

- MAINTAIN TRAFFIC, BOTH EASTBOUND AND WESTBOUND, AT ALL TIMES DURING THOSE STAGES WHICH DO NOT INCLUDE A CLOSURE SEGMENT, OR IF SHOWN OTHERWISE
- IOWA 281 DETOUR UTILIZING C57 AND W13 SHALL BE SET UP AT THE START OF THE PROJECT AND SHALL REMAIN IN PLACE UNTIL THE PROJECT IS SUBSTANTIALLY COMPLETED, AS DIRECTED BY THE ENGINEER.
- LOCAL DETOURS SHALL BE SET UP FOR CLOSURES DURING STAGES 2, 3, AND 4, SEE J SHEETS FOR FURTHER DETAILS.

STAGING NOTES

This Data Entry Sheet fills Tab 108-26A effective 8-1-08

PROJECT SHALL BE STAGED TO MINIMIZE INCONVENIENCE TO VEHICULAR AND

THE STAGING AS SHOWN IS THE INTENDED METHOD OF CONSTRUCTION FOR THIS PROJECT. ANY REQUEST FOR CHANGES TO THE STAGING SHALL BE SUBMITTED TO THE PROJECT. ANY REQUEST FOR CHANGES TO THE STANDING STREET BY STANDING TO THE CITY OF FAIRBANK AND TOWN DOT FOR REVIEW AND APPROVAL BY CHANGE ORDER. NO ADDITIONAL PAYMENT SHALL BE MADE FOR CHANGES IN TRAFFIC CONTROL OR STAGING SUBMITTED BY THE CONTRACTOR AND APPROVED BY THE CITY AND IOWA DOT.

WORK SHALL BEGIN WITH STAGE 1A AND SHALL PROCEED SEQUENTIALLY THROUGH STAGE

STAGES 3 AND 4 SHALL NOT BE CONSTRUCTED CONCURRENTLY.

STAGE 5 SHALL NOT BEGIN PRIOR TO THE COMPLETION OF STAGES 1A AND 1B, AND SHALL BE COMPLETED PRIOR TO COMMENCING STAGE 6. STAGES 5 AND 6 MAY BE COMPLETED IN CONJUNCTION WITH STAGES 2, 3, AND 4.

STAGE 1A - CONSTRUCTION: THE NORTH HALF OF E. MAIN STREET FROM THE EAST SIDE OF THE LITTLE WAPSIPINICON RIVER BRIDGE TO THE EAST SIDE OF 1ST STREET, APPROXIMATELY STATION 86+50.
TRAFFIC CONTROL: MAINTAIN ALTERNATING ONE-WAY TRAFFIC WITH THE USE OF

TEMPORARY TRAFFIC SIGNALS PER STANDARD ROAD PLAN TC-216 ON THE SOUTH HALF OF E. MAIN STREET PER SHEET 1.05

- PAVEMENT REMOVAL
- WATER MAIN CONNECTION AND INSTALLATION
- STORM SEWER SUBDRAIN
- PCC STREET AND SIDEWALK PAVING

STAGE 1B - CONSTRUCTION: THE SOUTH HALF OF E. MAIN STREET FROM THE EAST SIDE OF THE LITTLE WAPSIPINICON RIVER BRIDGE TO THE EAST SIDE OF 1ST STREET, APPROXIMATELY STATION 86+50.

TRAFFIC CONTROL: MAINTAIN ALTERNATING ONE-WAY TRAFFIC WITH THE USE OF TEMPORARY TRAFFIC SIGNALS PER STANDARD ROAD PLAN TC-216 ON THE NEW PAVEMENT ON THE NORTH HALF OF E. MAIN STREET PER SHEET J.06.

- PAVEMENT REMOVAL
- STORM SEWER WORK
- SUBDRATN
- PCC STREET, DRIVEWAY, AND SIDEWALK PAVING

TAGE 2 - CONSTRUCTION: E. MAIN STREET FROM THE EAST SIDE OF 1ST STREET TO

TRAFFIC CONTROL: LOCAL DETOUR SHALL BE SET UP PER SHEET J.07.

- PAVEMENT REMOVAL WATER MAIN CONNECTION AND INSTALLATION
- STORM SEWER SUBDRAIN
- PCC STREET, DRIVEWAY, AND SIDEWALK PAVING

TAGE 3 - CONSTRUCTION: 4TH STREET FROM E. MAIN STREET TO GROVE STREET. FRAFFIC CONTROL: LOCAL DETOUR SHALL BE SET UP PER SHEET J.08.

- WATER MAIN CONNECTION AND INSTALLATION
- STORM SEWER
- SUBDRAIN
- PCC STREET, DRIVEWAY, AND SIDEWALK PAVING

STAGE 4 - CONSTRUCTION: GROVE STREET FROM 4TH STREET TO IOWA NORTHERN

TRAFFIC CONTROL: LOCAL DETOUR TO BE SET UP PER SHEET J.09

- PAVEMENT REMOVAL
- WATER MAIN CONNECTION AND INSTALLATION
- STORM SEWER
- PCC STREET, SIDEWALK AND DRIVEWAY PAVING

STAGE 5 - CONSTRUCTION: W. MAIN STREET TRAFFIC CONTROL: TC-212

- STORM SEWER
- HMA SHOULDER

TAGE 6 - CONSTRUCTION: FAIRBANK STREET, WALNUT STREET, W. MAIN STREET TRAFFIC CONTROL: FLAGGERS AND PILOT CAR

HMA MILL AND OVERLAY

OWNER/DEVELOPER



ILLINOIS IOWA

WISCONSIN

116 EAST MAIN STREET FAIRBANK, IA 50629

CITY OF FAIRBANK

MAIN STREET IMPROVEMENTS FAIRBANK, IOWA BUCHANAN COUNTY STPN-281-2(10)--2J-10

PROJECT AND LOCATION

DRAWN BY: AFC APPROVED BY: JSB DATE: 10/27/22 SCALE: AS NOTED


REVISIONS					
REV. NO.	DESCRIPTION	DATE			

TRAFFIC CONTROL AND STAGING NOTES

SET TYPE: BID LETTING

JOB NUMBER: 22-1100 SHEET NUMBER:

J.01

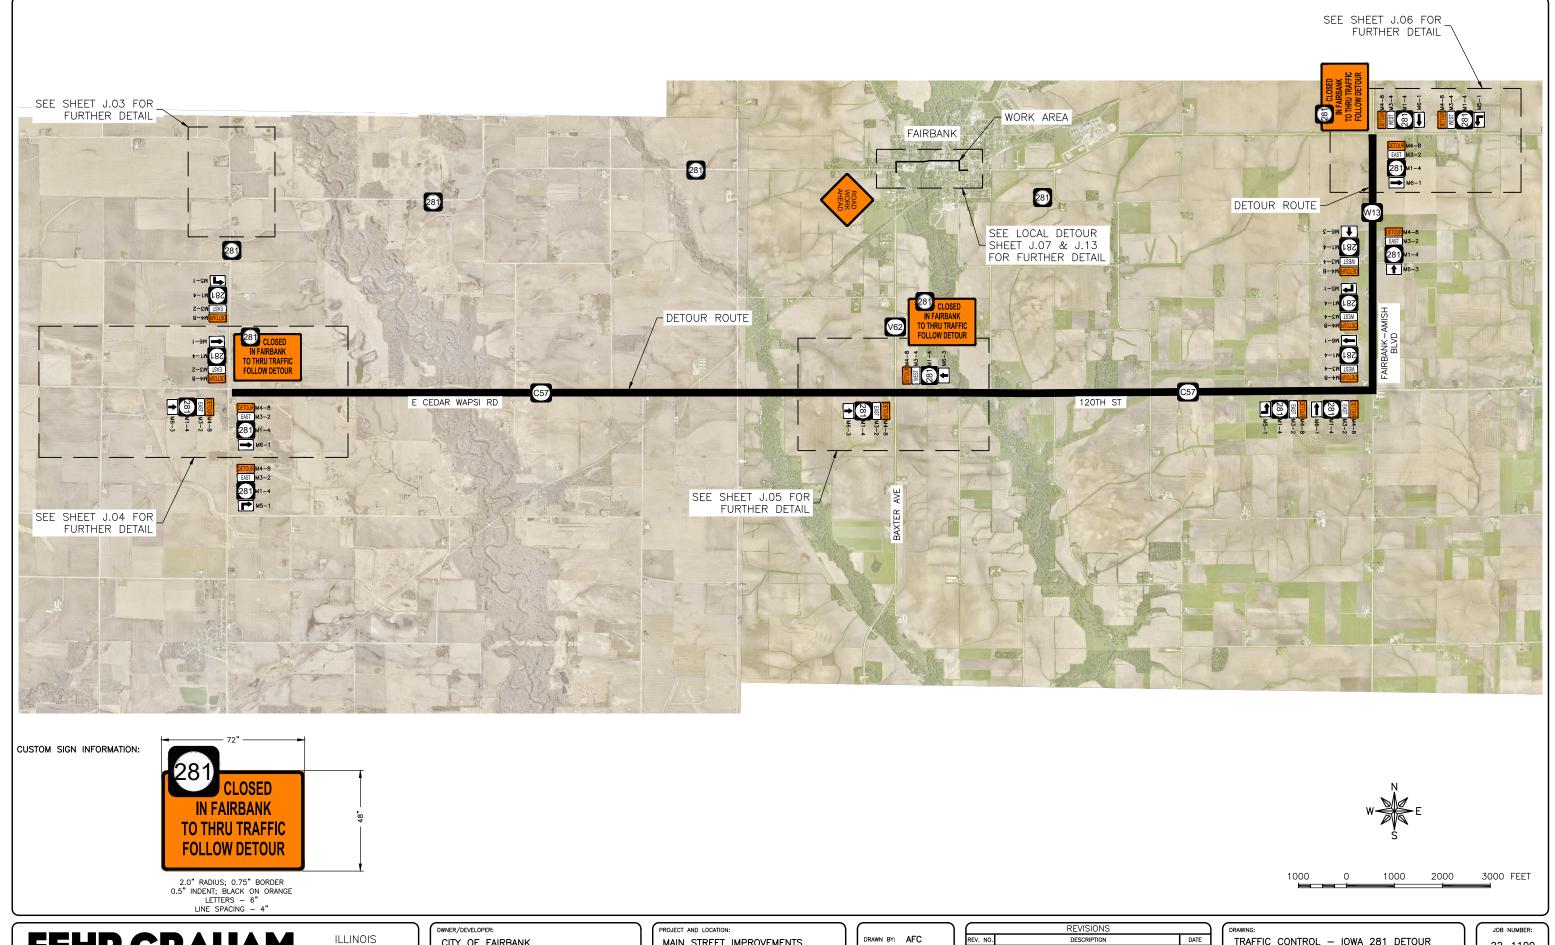

ENGINEERING & ENVIRONMENTAL

CITY OF FAIRBANK

IOWA

WISCONSIN

116 EAST MAIN STREET FAIRBANK, IA 50629

MAIN STREET IMPROVEMENTS FAIRBANK, IOWA BUCHANAN COUNTY STPN-281-2(10)--2J-10

APPROVED BY: JSB DATE: 10/27/22 SCALE: AS NOTED


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TRAFFIC CONTROL - IOWA 281 DETOUR

SET TYPE: BID LETTING

22-1100

SHEET NUMBER: J.02



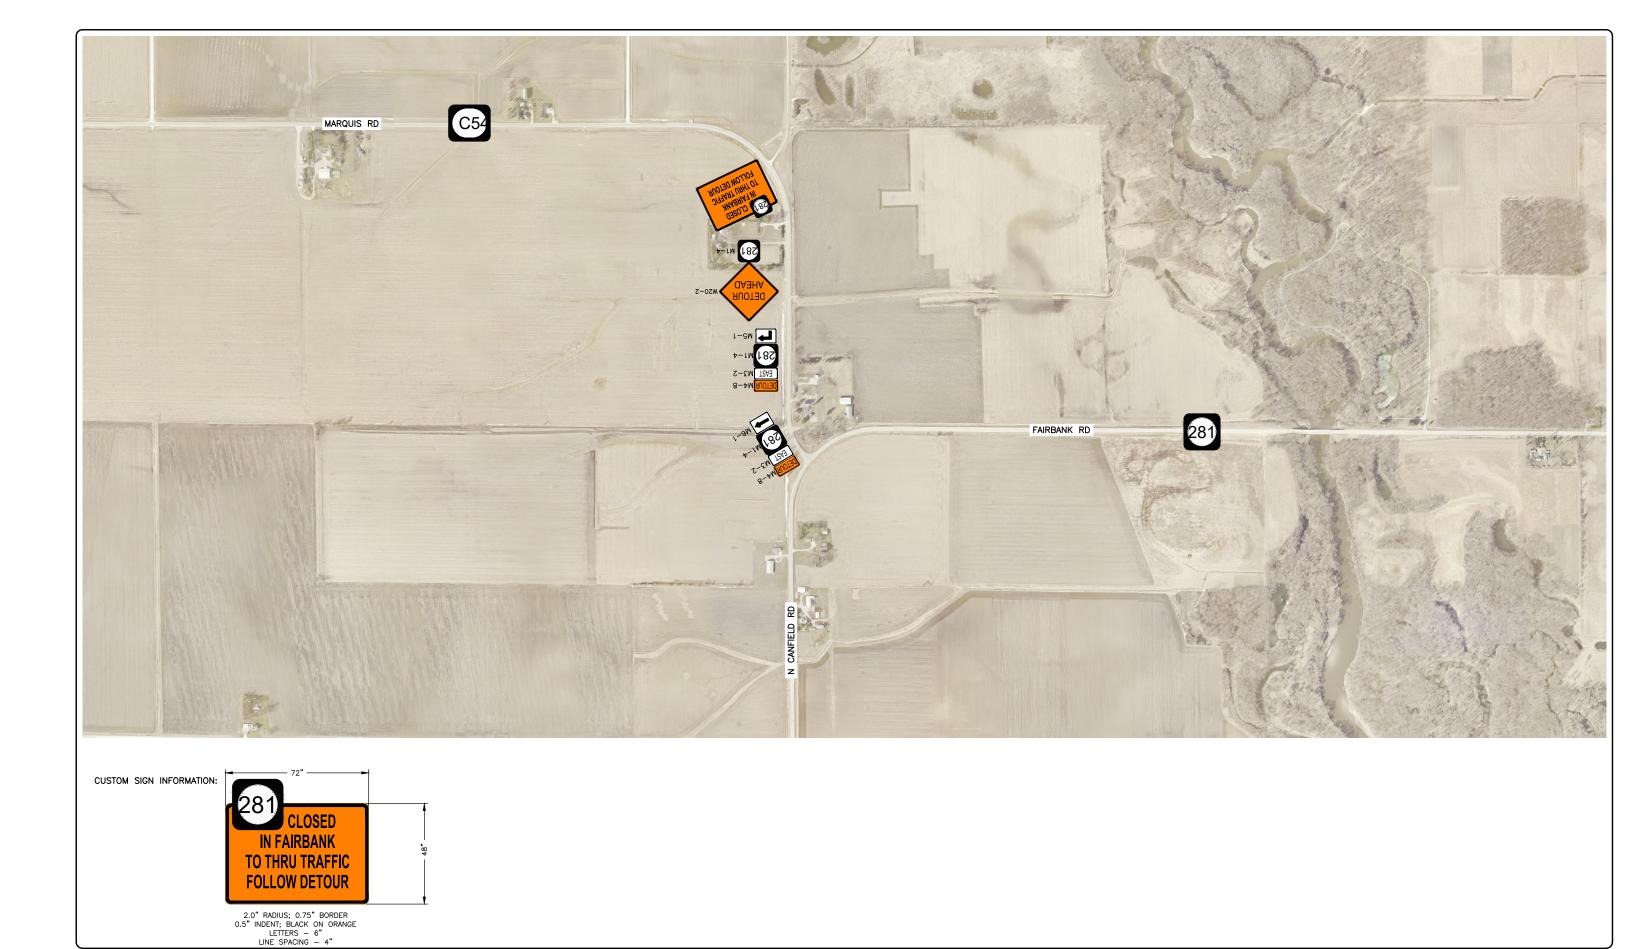

OWNER/DEVELOPER:

CITY OF FAIRBANK

116 EAST MAIN STREET
FAIRBANK, IA 50629

PROJECT AND LOCATION:

MAIN STREET IMPROVEMENTS
FAIRBANK, IOWA
BUCHANAN COUNTY
STPN-281-2(10)--2J-10

DRAWN BY: AFC
APPROVED BY: JSB
DATE: 10/27/22
SCALE: AS NOTED

	REVISIONS	
REV. NO.	DESCRIPTION	DATE


DRAWING:
TRAFFIC CONTROL — IOWA 281 DETOUR

SET TYPE: BID LETTING
G:\C30\22\22-1100 Fgirbonk Hwy 281\Plans\22-1100 PIANS.dwg. J.03

22-1100

SHEET NUMBER:

J.03

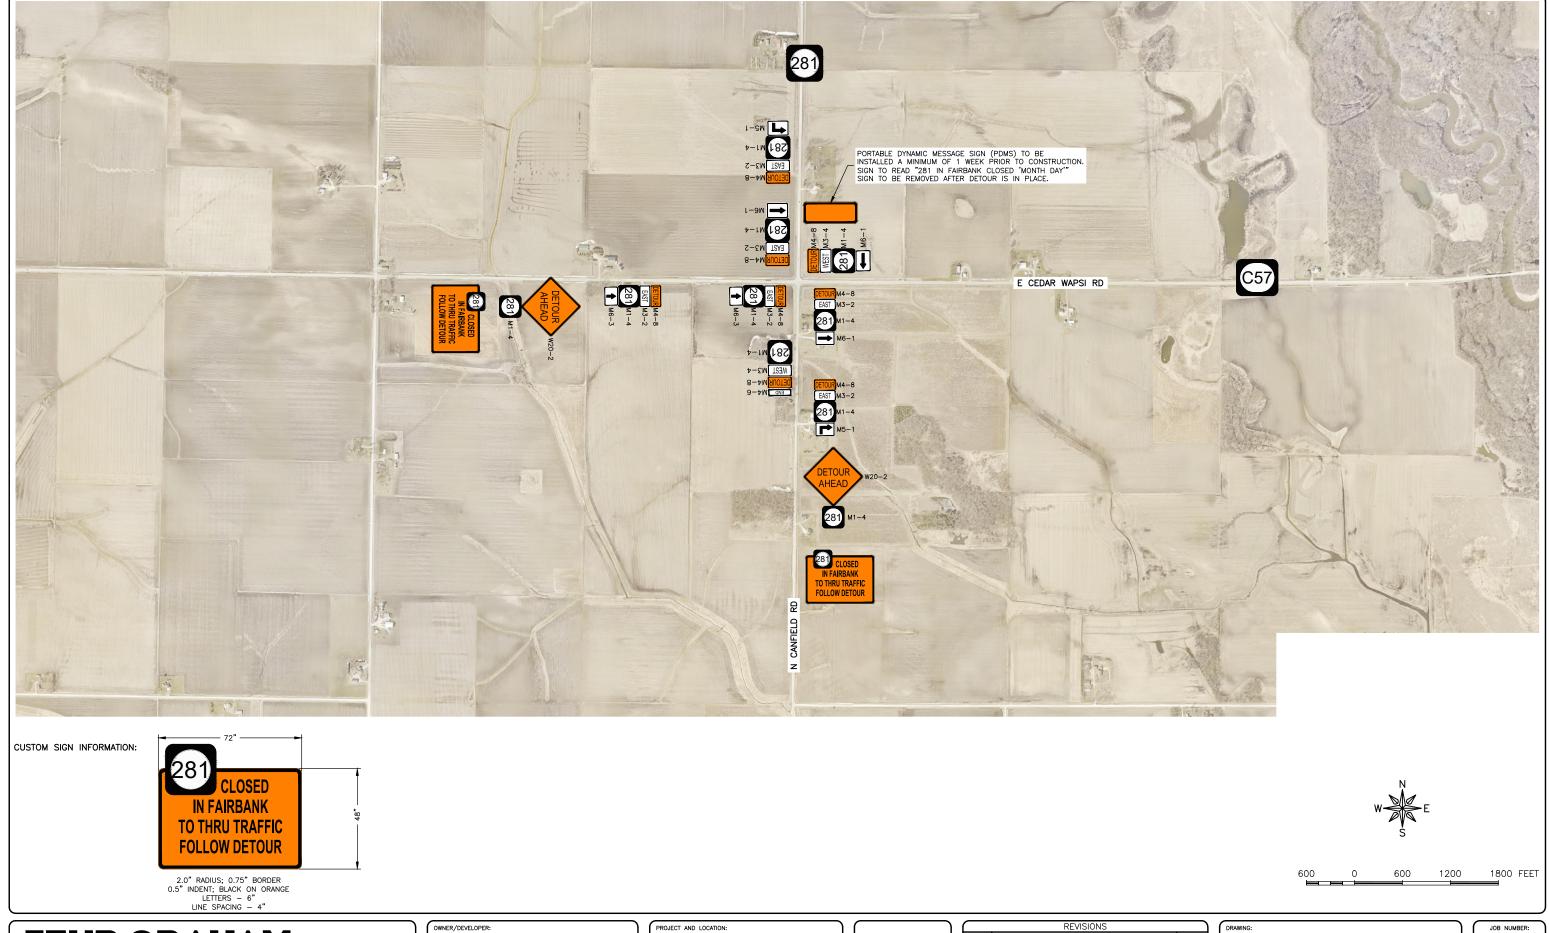

ILLINOIS IOWA WISCONSIN

CITY OF FAIRBANK 116 EAST MAIN STREET FAIRBANK, IA 50629 MAIN STREET IMPROVEMENTS
FAIRBANK, IOWA
BUCHANAN COUNTY
STPN-281-2(10)--2J-10

DRAWN BY: AFC
APPROVED BY: JSB
DATE: 10/27/22
SCALE: AS NOTED

	REVISIONS	
REV. NO.	DESCRIPTION	DATE

DRAWING:
TRAFFIC CONTROL — IOWA 281 DETOUR


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G:\C30\22\22-1100 Fgirbank Hwy 281\Plans\22-1100 PLANS.dwa, J.04


JOB NUMBER:

22-1100

SHEET NUMBER:

J.04

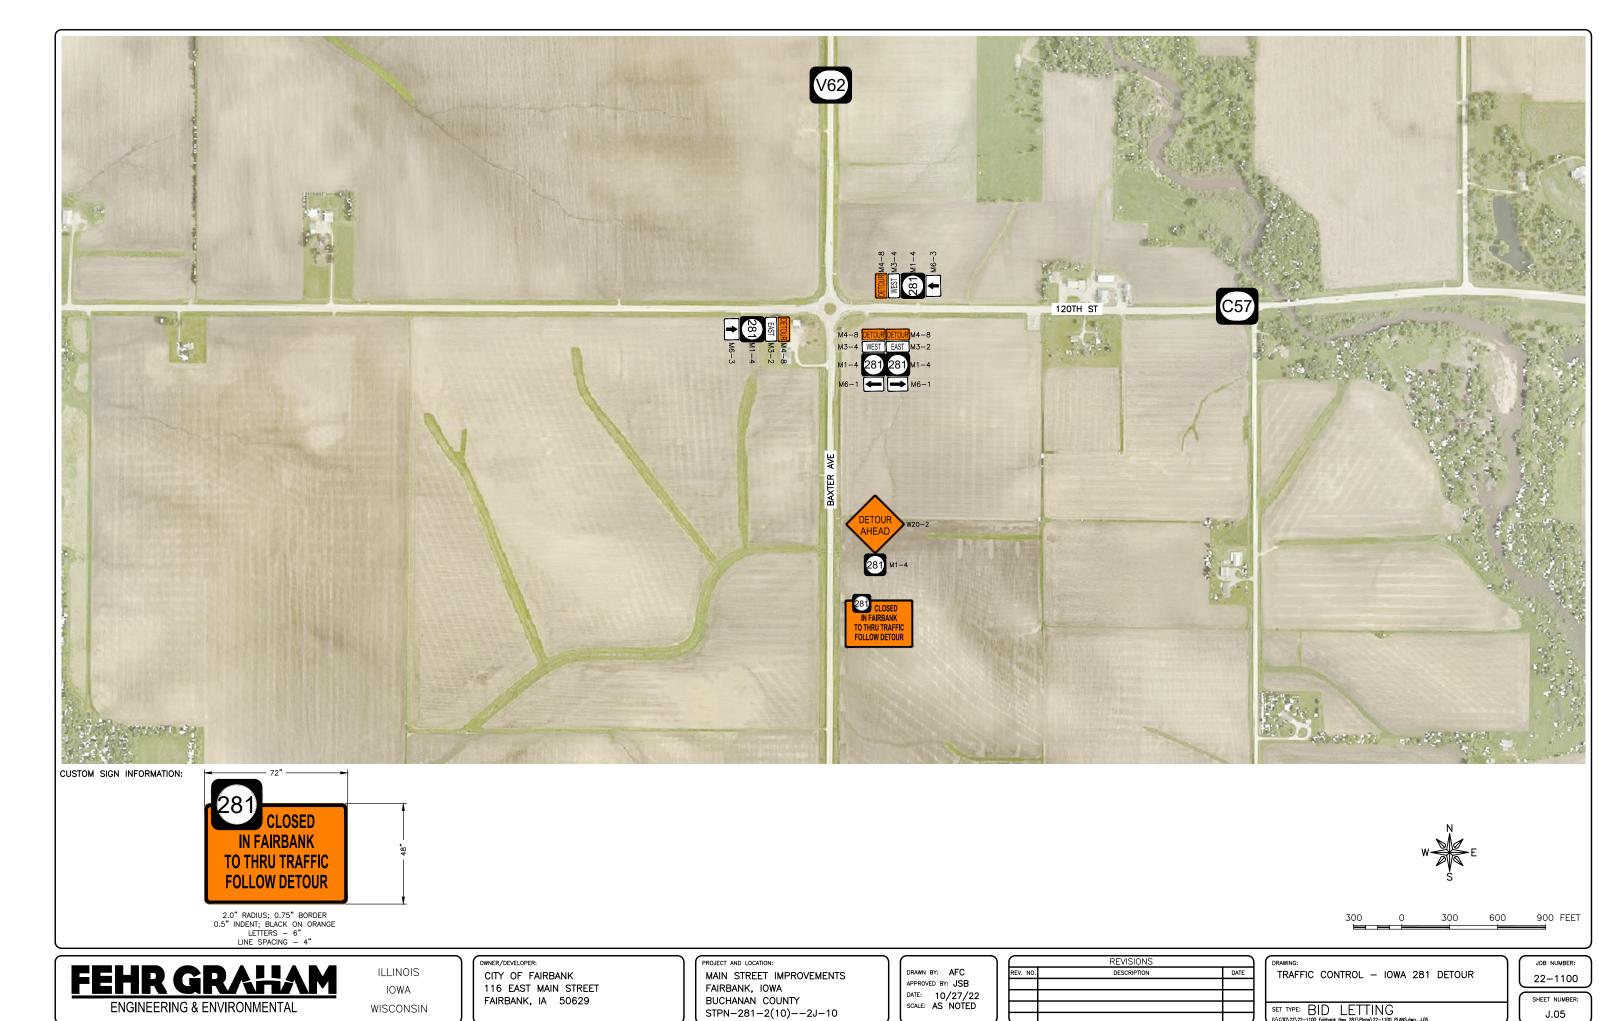

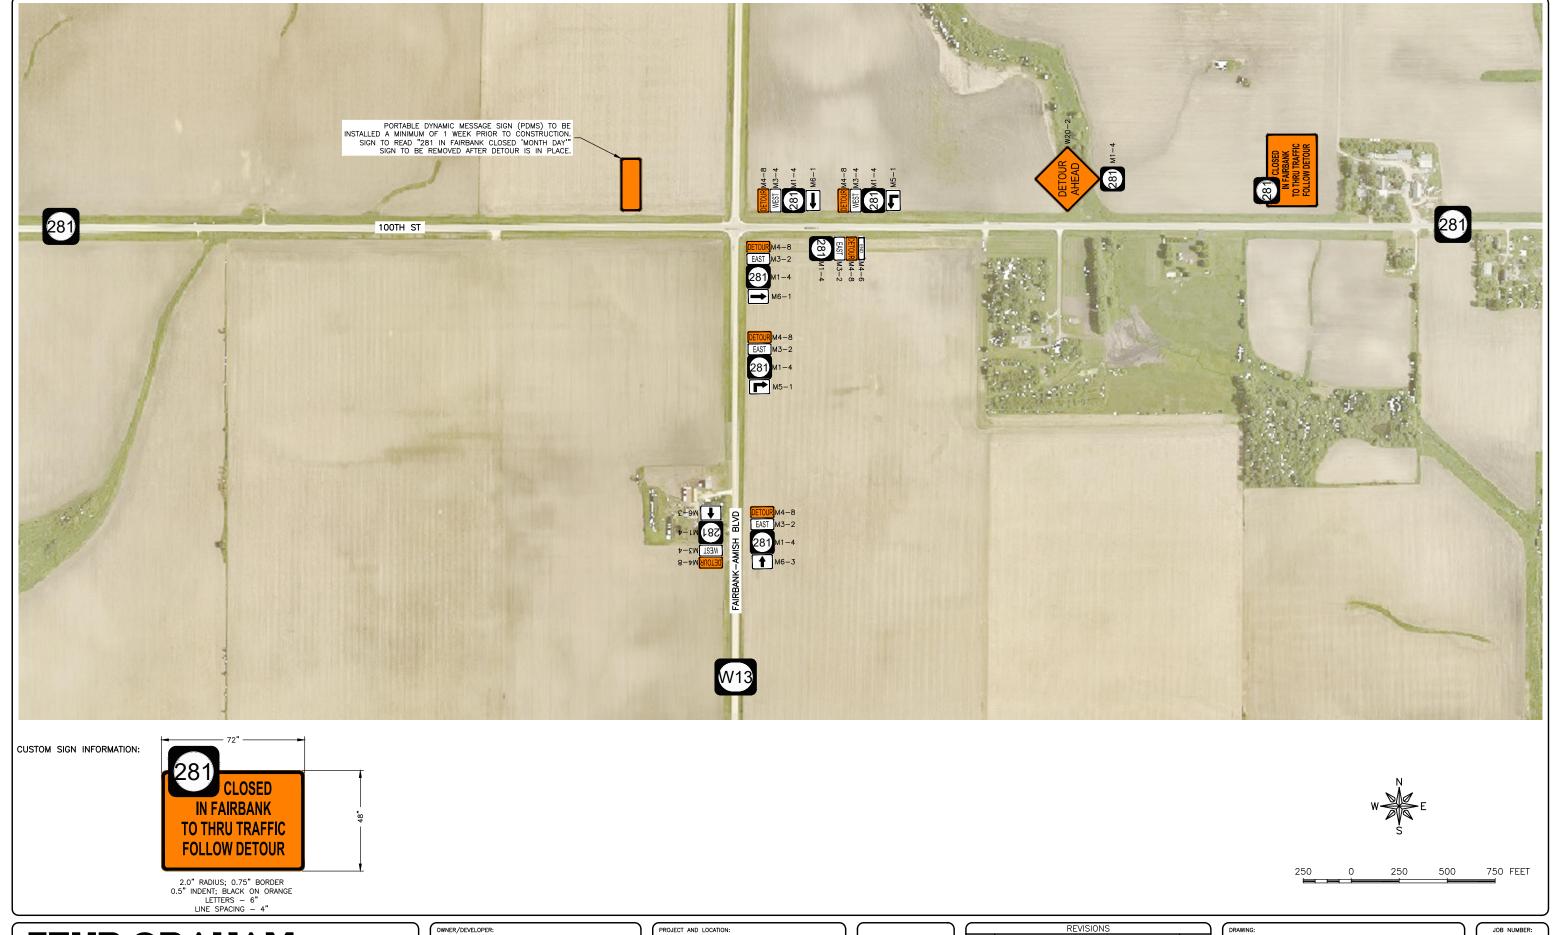

ILLINOIS IOWA

WISCONSIN

CITY OF FAIRBANK 116 EAST MAIN STREET FAIRBANK, IA 50629

MAIN STREET IMPROVEMENTS FAIRBANK, IOWA BUCHANAN COUNTY STPN-281-2(10)--2J-10

DRAWN BY: AFC APPROVED BY: JSB

DATE: 10/27/22


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REVISIONS		
REV. NO.	DESCRIPTION	DATE

TRAFFIC CONTROL - IOWA 281 DETOUR

SET TYPE: BID LETTING

22-1100 SHEET NUMBER: J.06

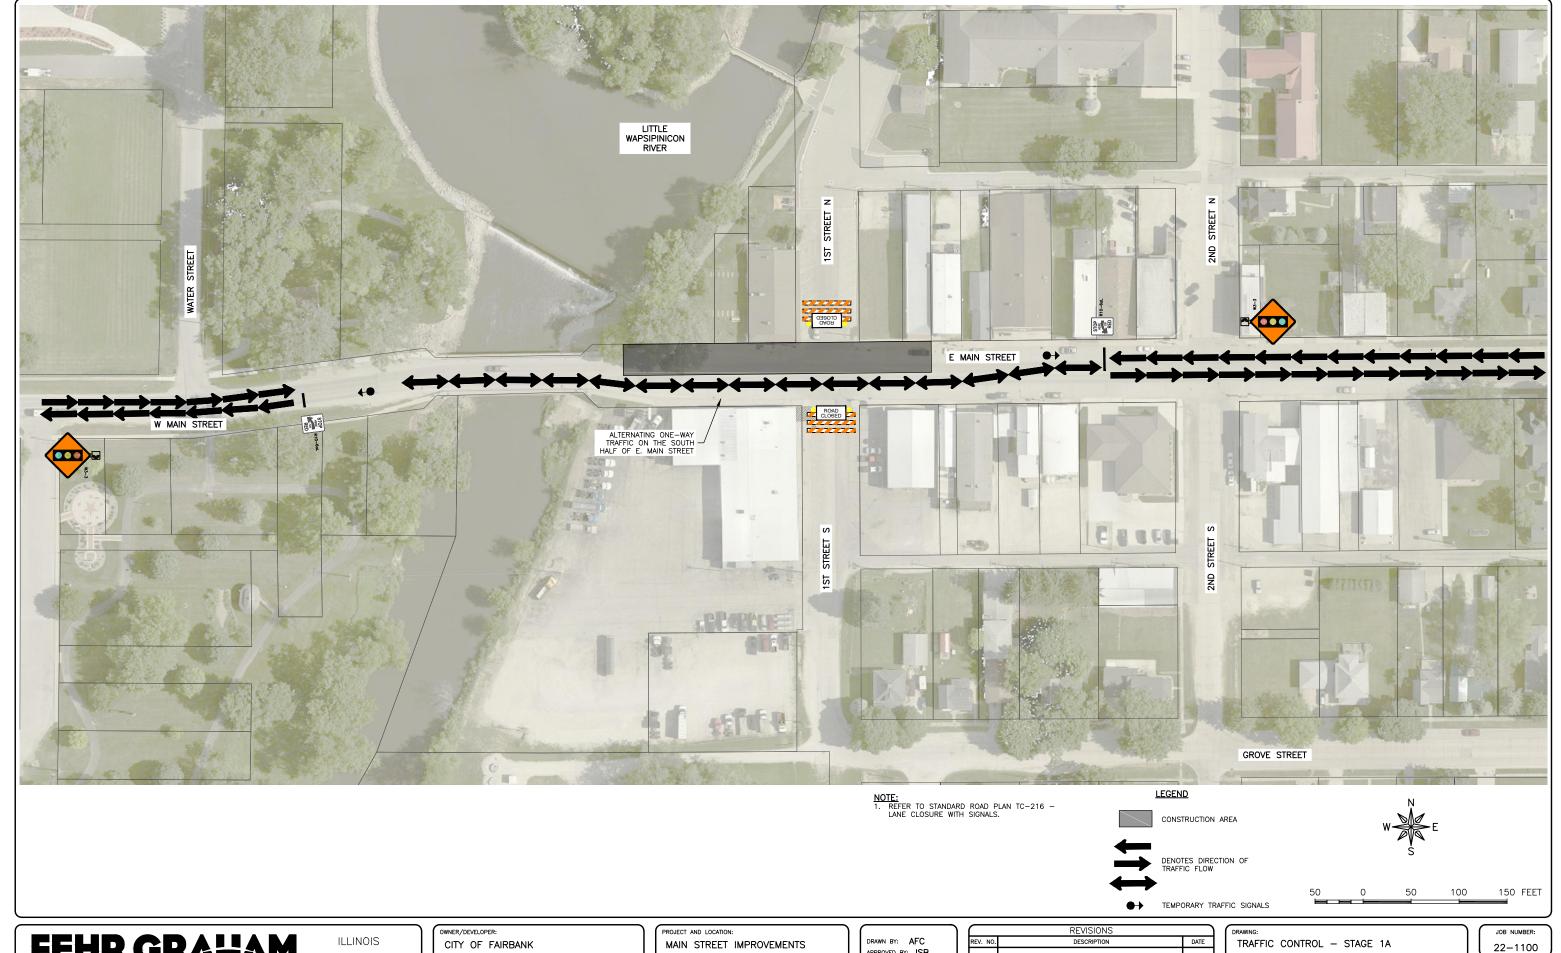

IOWA WISCONSIN 116 EAST MAIN STREET FAIRBANK, IA 50629


FAIRBANK, IOWA BUCHANAN COUNTY STPN-281-2(10)--2J-10 APPROVED BY: JSB
DATE: 10/27/22
SCALE: AS NOTED

	REVISIONS	
REV. NO.	DESCRIPTION	DATE

SET TYPE: BID LETTING

22-1100 SHEET NUMBER:

J.07

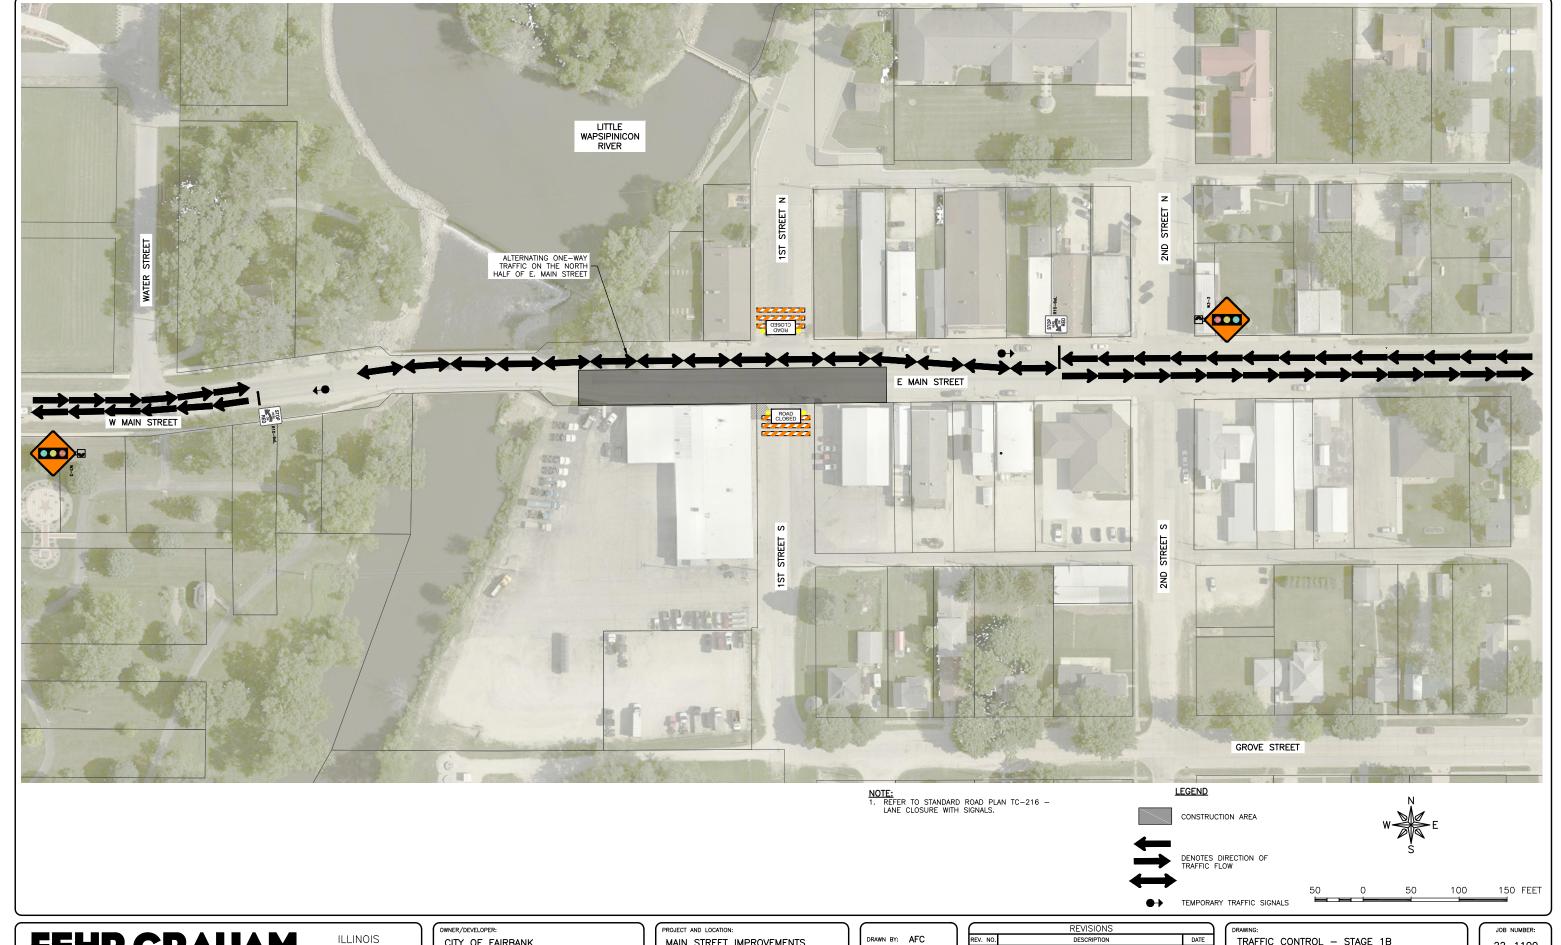

ILLINOIS IOWA WISCONSIN owner/developer:
CITY OF FAIRBANK
116 EAST MAIN STREET
FAIRBANK, IA 50629


MAIN STREET IMPROVEMENTS
FAIRBANK, IOWA
BUCHANAN COUNTY
STPN-281-2(10)--2J-10


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	REVISIONS	
REV. NO.	DESCRIPTION	DATE

DRAWING:
TRAFFIC CONTROL — STAGE 1B

SET TYPE: BID LETTING
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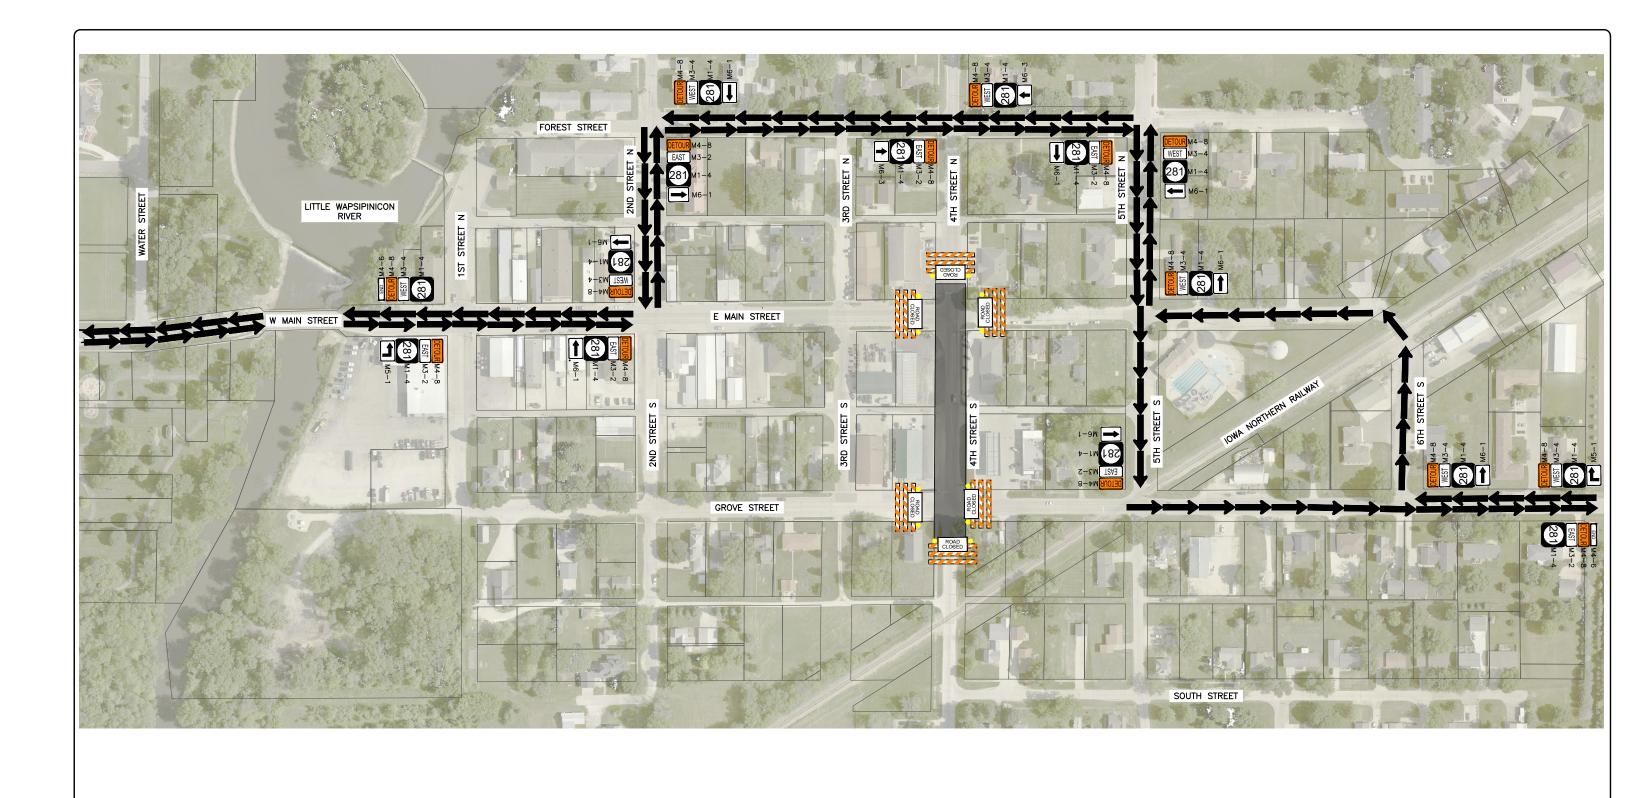
owner/developer: CITY OF FAIRBANK 116 EAST MAIN STREET FAIRBANK, IA 50629 PROJECT AND LOCATION:


MAIN STREET IMPROVEMENTS
FAIRBANK, IOWA
BUCHANAN COUNTY
STPN-281-2(10)--2J-10
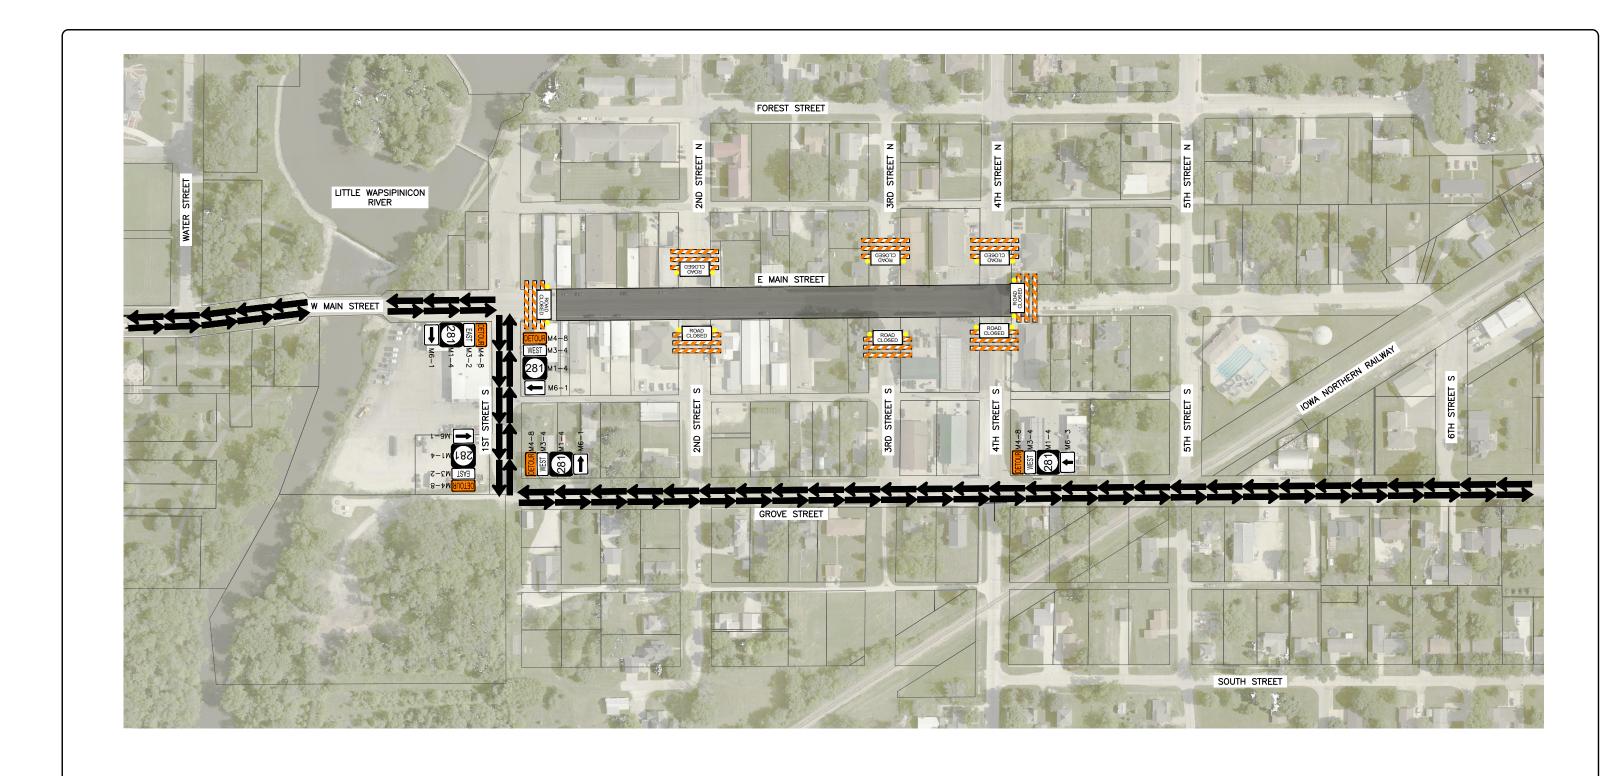
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DRAWN BY: AFC		REV. NO.	
APPROVED BY: JSB			
DATE: 10/27/22			
SCALE: AS NOTED			
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REV. NO.	DESCRIPTION	DATE	
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DRAWING: TRAFFIC CONTROL — STAGE 2
SET TYPE: BID LETTING

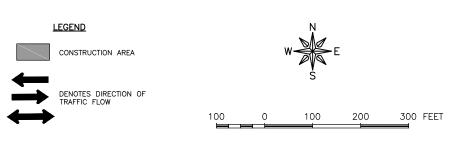



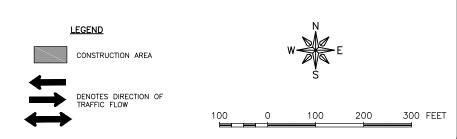

owner/developer: CITY OF FAIRBANK 116 EAST MAIN STREET FAIRBANK, IA 50629 PROJECT AND LOCATION:


MAIN STREET IMPROVEMENTS
FAIRBANK, IOWA
BUCHANAN COUNTY
STPN-281-2(10)--2J-10


DRAWN BY: AFC
APPROVED BY: JSB
DATE: 10/27/22
SCALE: AS NOTED

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REV. NO.	DESCRIPTION	DATE	ı
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DRAWING:
TRAFFIC CONTROL — STAGE 3

SET TYPE: BID LETTING



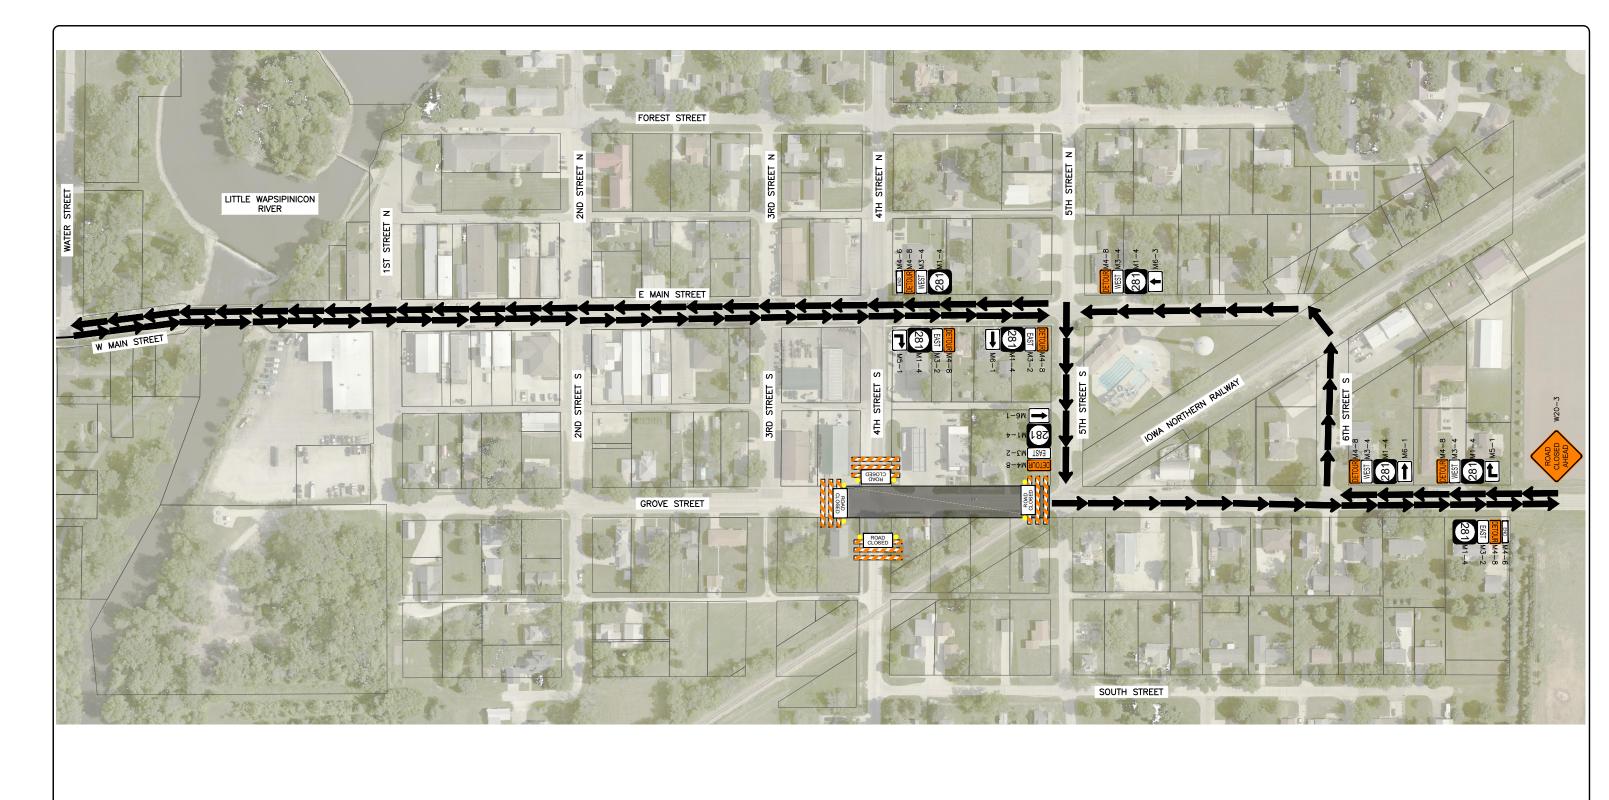

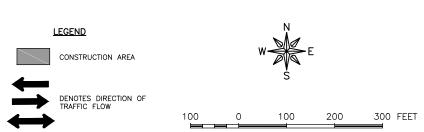

owner/developer: CITY OF FAIRBANK 116 EAST MAIN STREET FAIRBANK, IA 50629 PROJECT AND LOCATION:


MAIN STREET IMPROVEMENTS
FAIRBANK, IOWA
BUCHANAN COUNTY
STPN-281-2(10)--2J-10


DRAWN BY: AFC
APPROVED BY: JSB
DATE: 10/27/22
SCALE: AS NOTED

	REVISIONS	
REV. NO.	DESCRIPTION	DATE

DRAWING:
TRAFFIC CONTROL — STAGE 4

SET TYPE: BID LETTING

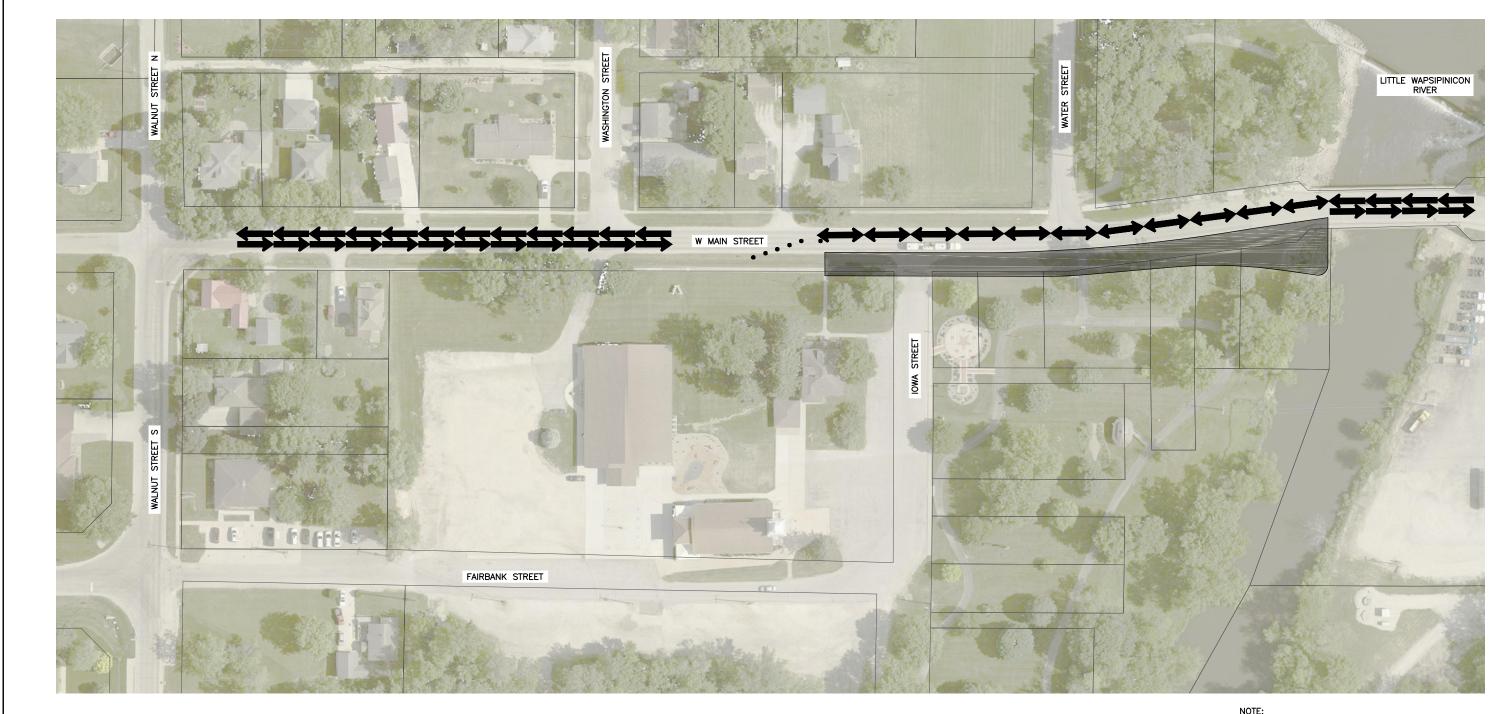

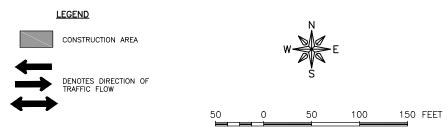

FEHR GRAHAM

ENGINEERING & ENVIRONMENTAL

ILLINOIS IOWA WISCONSIN owner/developer: CITY OF FAIRBANK 116 EAST MAIN STREET FAIRBANK, IA 50629 PROJECT AND LOCATION:


MAIN STREET IMPROVEMENTS
FAIRBANK, IOWA
BUCHANAN COUNTY
STPN-281-2(10)--2J-10


DRAWN BY: AFC
APPROVED BY: JSB
DATE: 10/27/22
SCALE: AS NOTED

REVISIONS		
REV. NO.	DESCRIPTION	DATE

DRAWING:
TRAFFIC CONTROL — STAGE 5

SET TYPE: BID LETTING

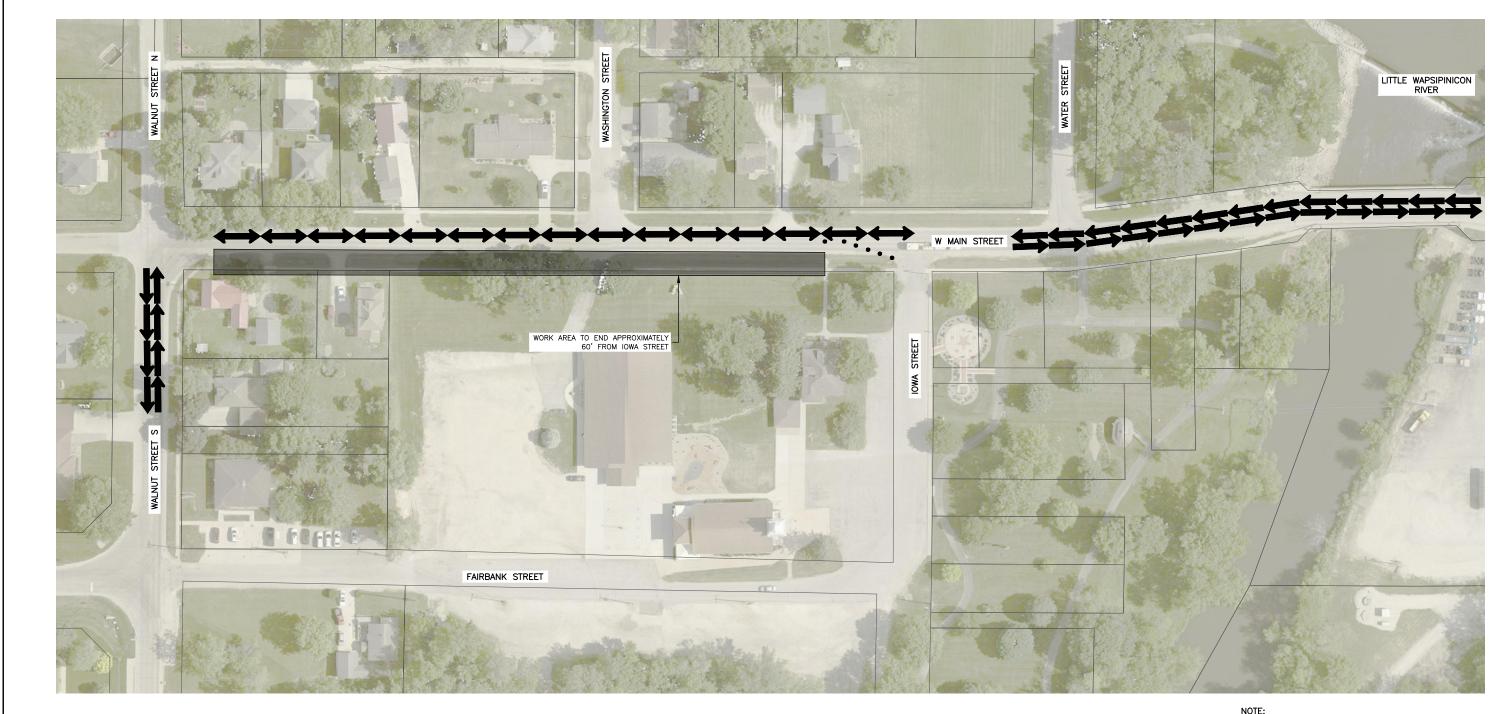

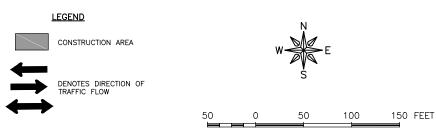

FEHR GRAHAM
ENGINEERING & ENVIRONMENTAL

ILLINOIS IOWA WISCONSIN owner/developer: CITY OF FAIRBANK 116 EAST MAIN STREET FAIRBANK, IA 50629 PROJECT AND LOCATION:


MAIN STREET IMPROVEMENTS
FAIRBANK, IOWA
BUCHANAN COUNTY
STPN-281-2(10)--2J-10


DRAWN BY: AFC
APPROVED BY: JSB
DATE: 10/27/22
SCALE: AS NOTED

REVISIONS		
REV. NO.	DESCRIPTION	DATE

DRAWING:
TRAFFIC CONTROL — STAGE 5

SET TYPE: BID LETTING

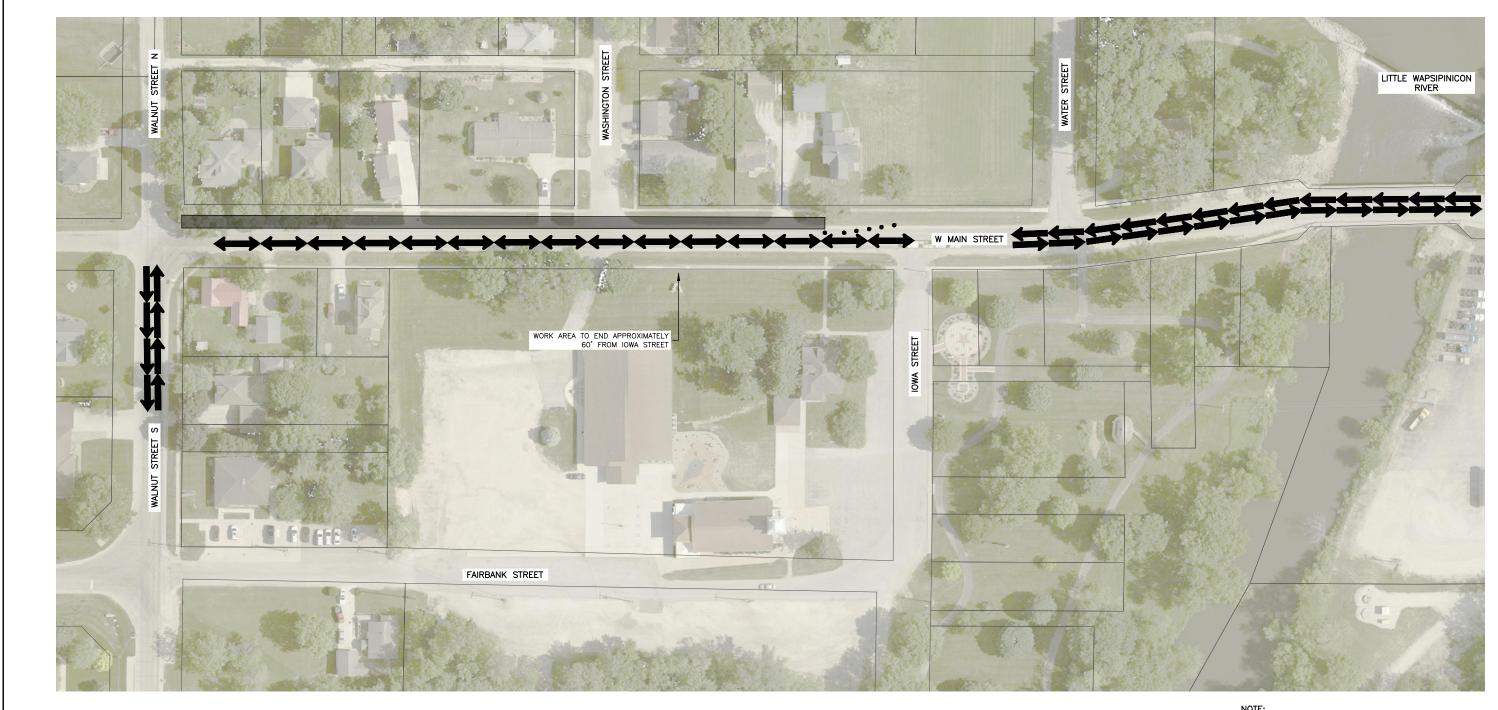

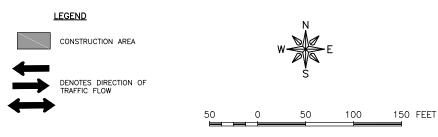

FEHR GRAHAM

ENGINEERING & ENVIRONMENTAL

ILLINOIS IOWA WISCONSIN owner/developer: CITY OF FAIRBANK 116 EAST MAIN STREET FAIRBANK, IA 50629 PROJECT AND LOCATION:


MAIN STREET IMPROVEMENTS
FAIRBANK, IOWA
BUCHANAN COUNTY
STPN-281-2(10)--2J-10


DRAWN BY: AFC
APPROVED BY: JSB
DATE: 10/27/22
SCALE: AS NOTED

REVISIONS		
REV. NO.	DESCRIPTION	DATE

DRAWING:
TRAFFIC CONTROL — STAGE 5

SET TYPE: BID LETTING

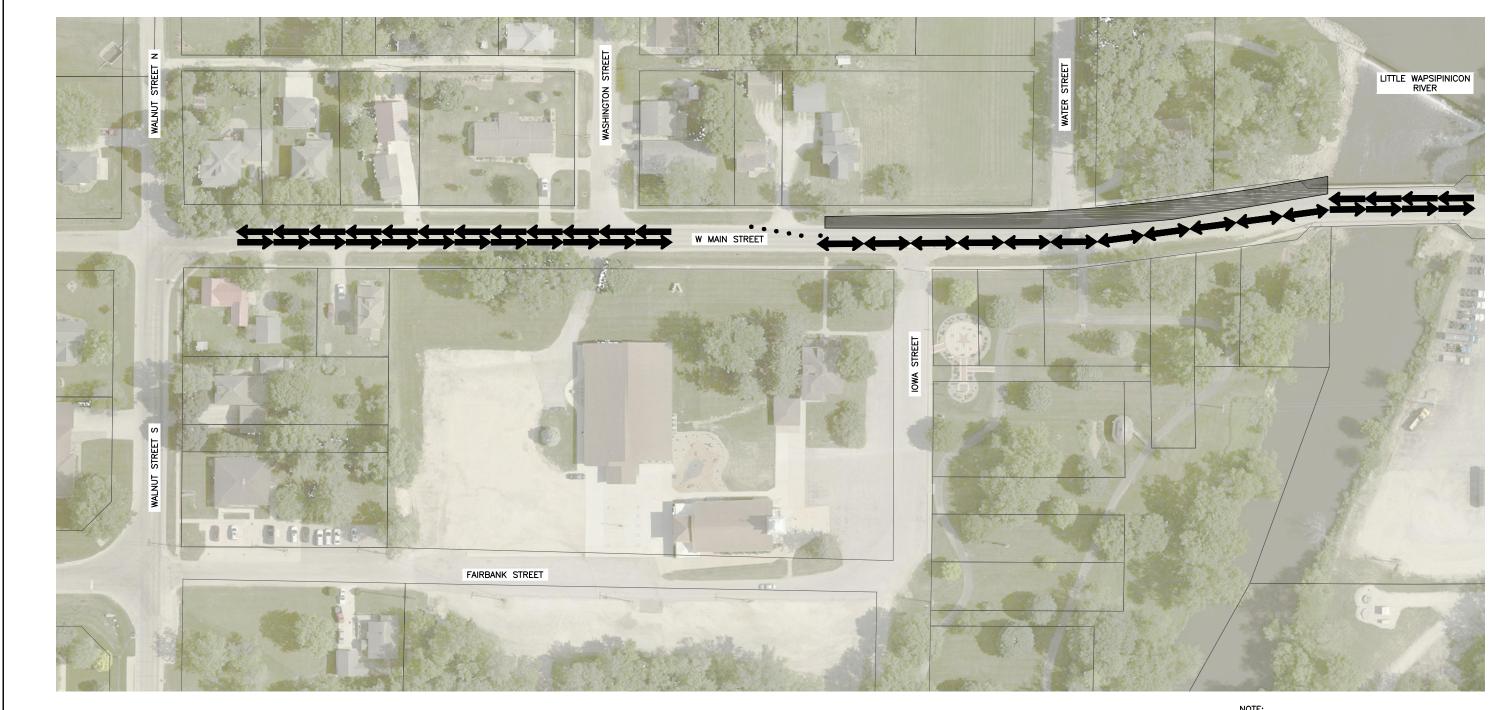

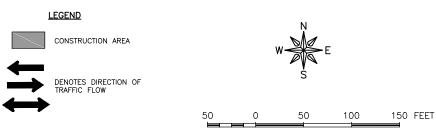

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ENGINEERING & ENVIRONMENTAL

ILLINOIS IOWA WISCONSIN owner/developer: CITY OF FAIRBANK 116 EAST MAIN STREET FAIRBANK, IA 50629 PROJECT AND LOCATION:


MAIN STREET IMPROVEMENTS
FAIRBANK, IOWA
BUCHANAN COUNTY
STPN-281-2(10)--2J-10


DRAWN BY: AFC
APPROVED BY: JSB
DATE: 10/27/22
SCALE: AS NOTED

REVISIONS		
REV. NO.	DESCRIPTION	DATE

DRAWING:
TRAFFIC CONTROL — STAGE 5

SET TYPE: BID LETTING

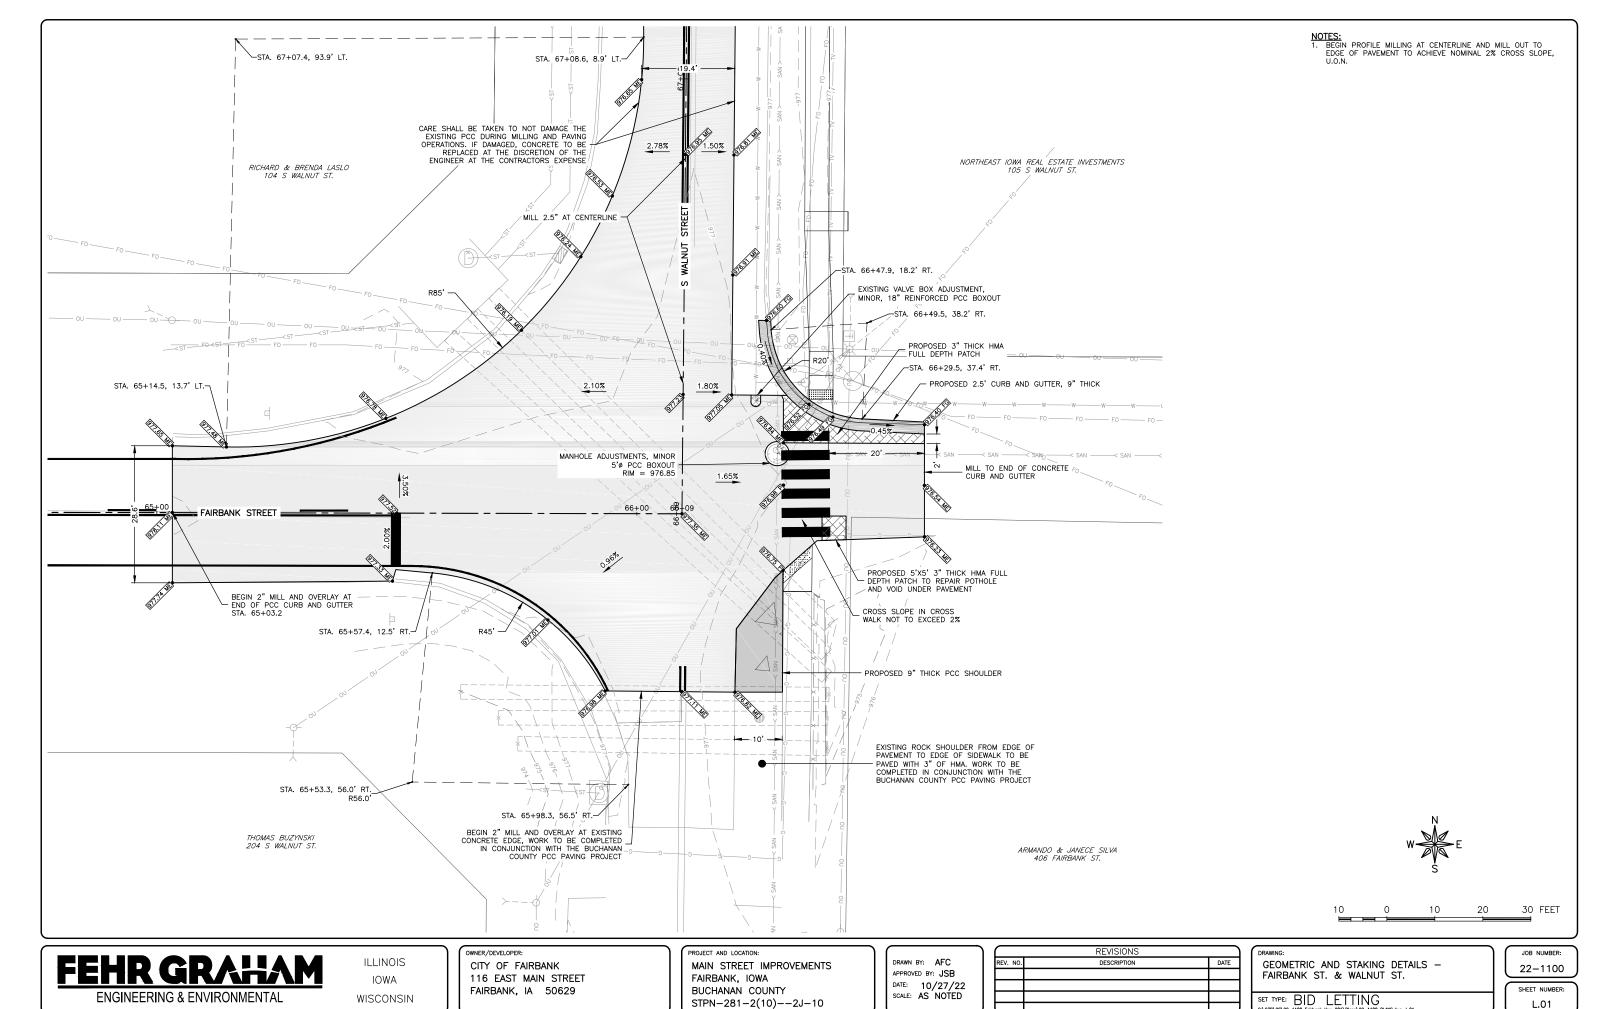

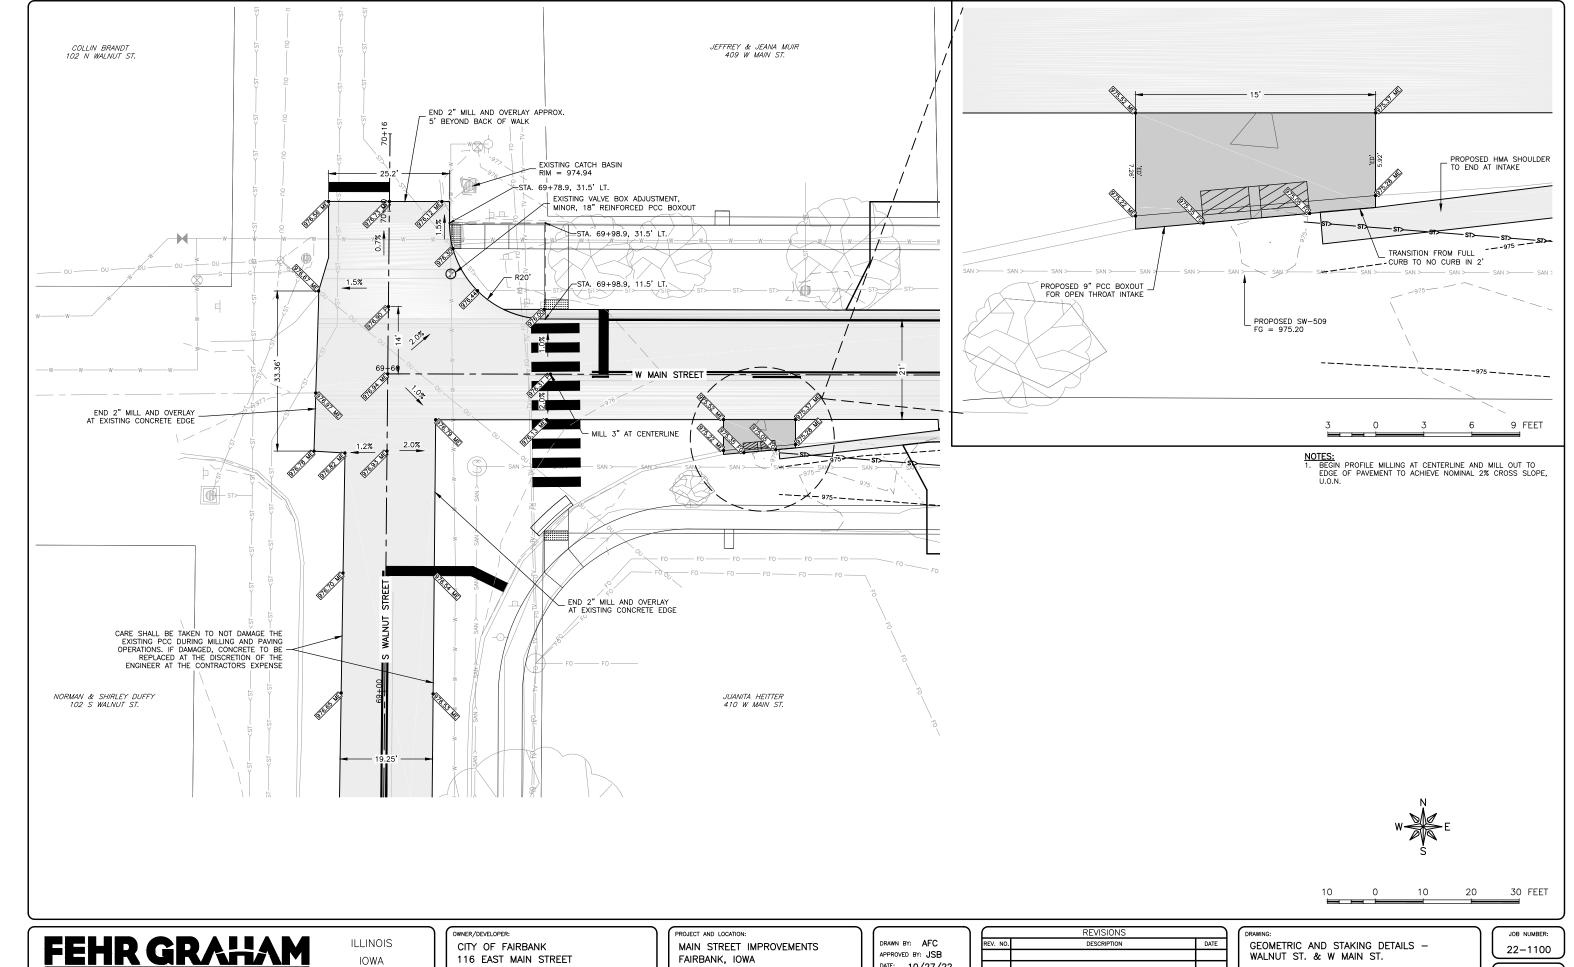

IOWA WISCONSIN

116 EAST MAIN STREET FAIRBANK, IA 50629


FAIRBANK, IOWA BUCHANAN COUNTY STPN-281-2(10)--2J-10 DATE: 10/27/22 SCALE: AS NOTED

REVISIONS		
REV. NO.	DESCRIPTION	DATE

GEOMETRIC AND STAKING DETAILS — WALNUT ST. & W MAIN ST.

SHEET NUMBER:

SET TYPE: BID LETTING L.02

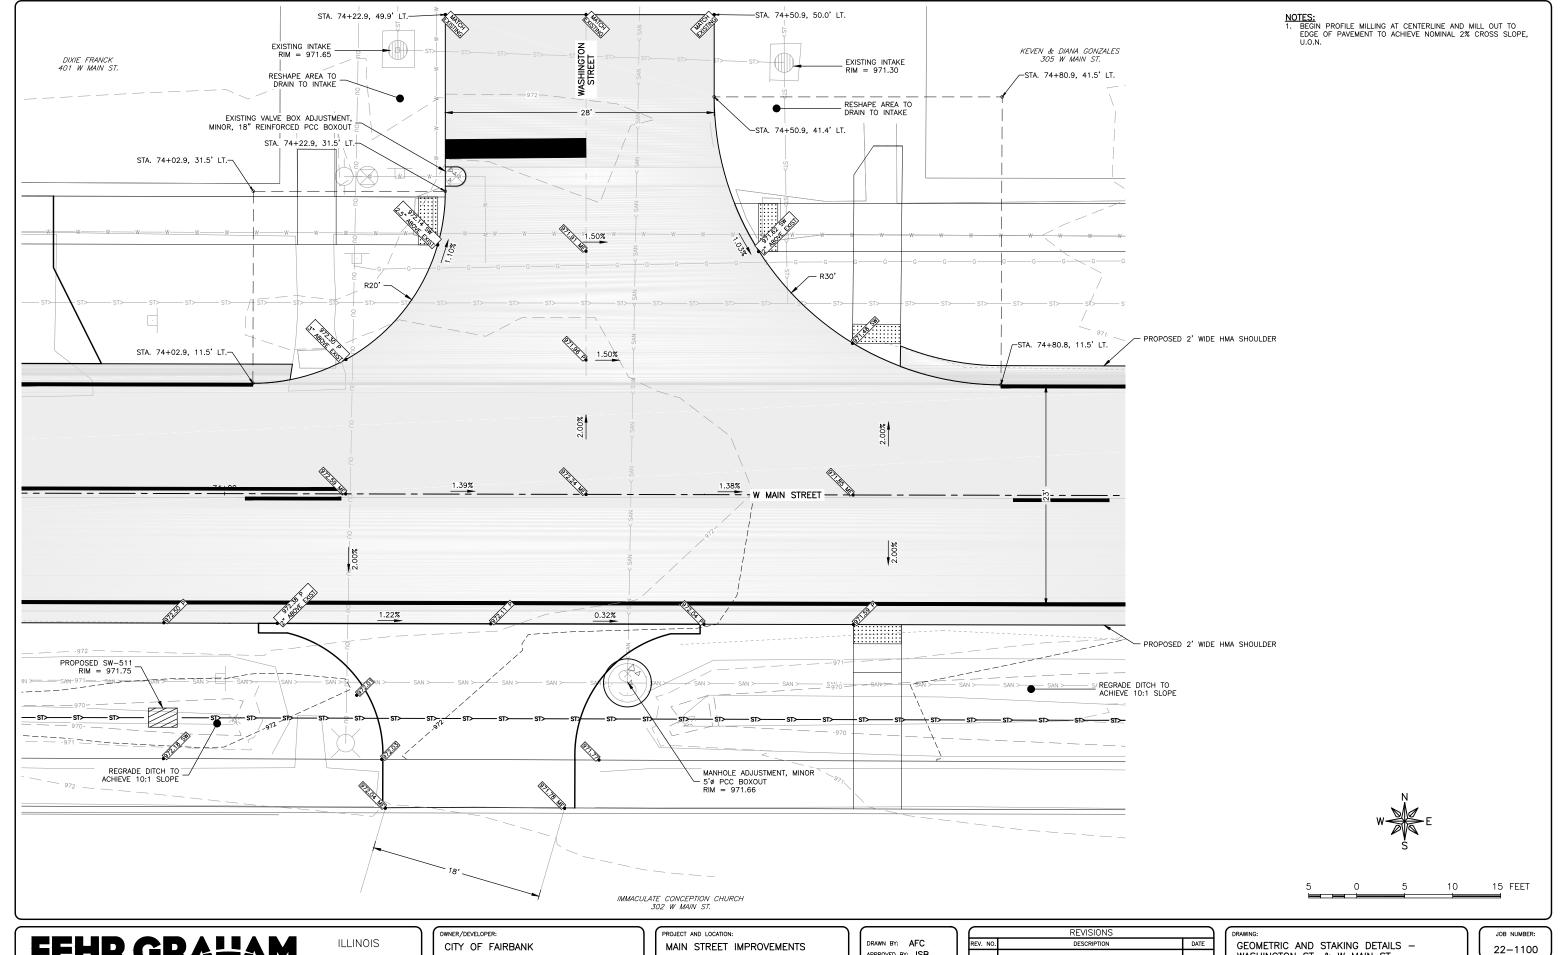

IOWA WISCONSIN 116 EAST MAIN STREET FAIRBANK, IA 50629

FAIRBANK, IOWA BUCHANAN COUNTY STPN-281-2(10)--2J-10

APPROVED BY: JSB DATE: 10/27/22 SCALE: AS NOTED


	REVISIONS	
EV. NO.	DESCRIPTION	DATE


GEOMETRIC AND STAKING DETAILS — WASHINGTON ST. & W MAIN ST.


SHEET NUMBER: SET TYPE: BID LETTING

PLOT DATE: 10/31/22 © 2022 FEHR GRAHAM

L.03

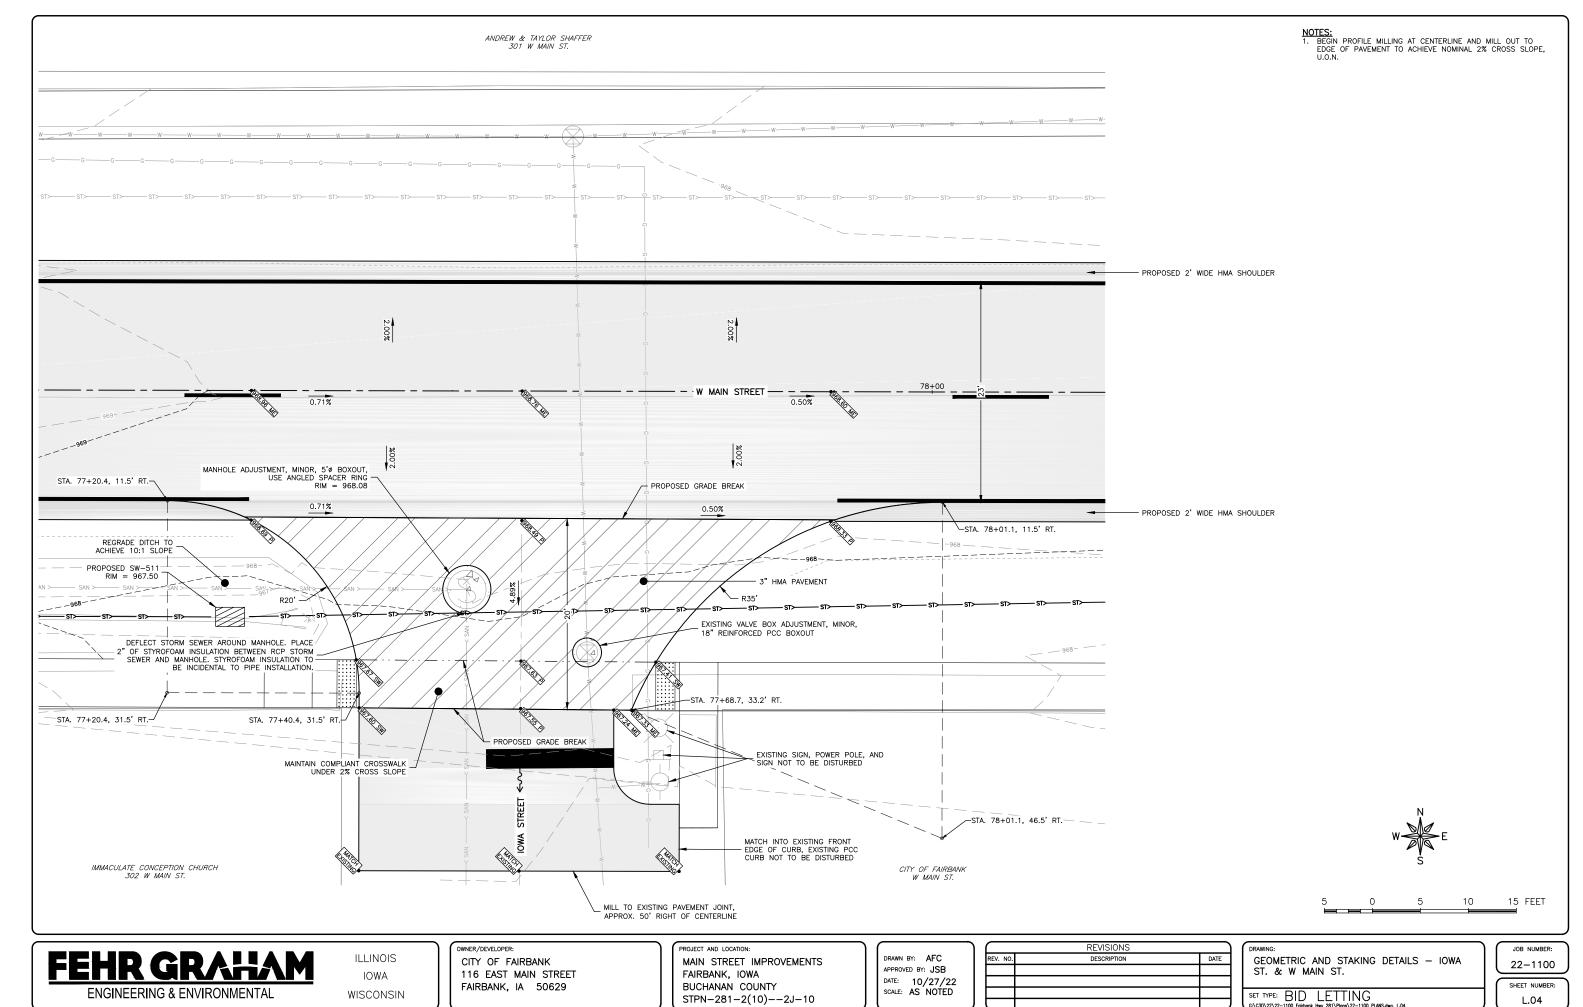

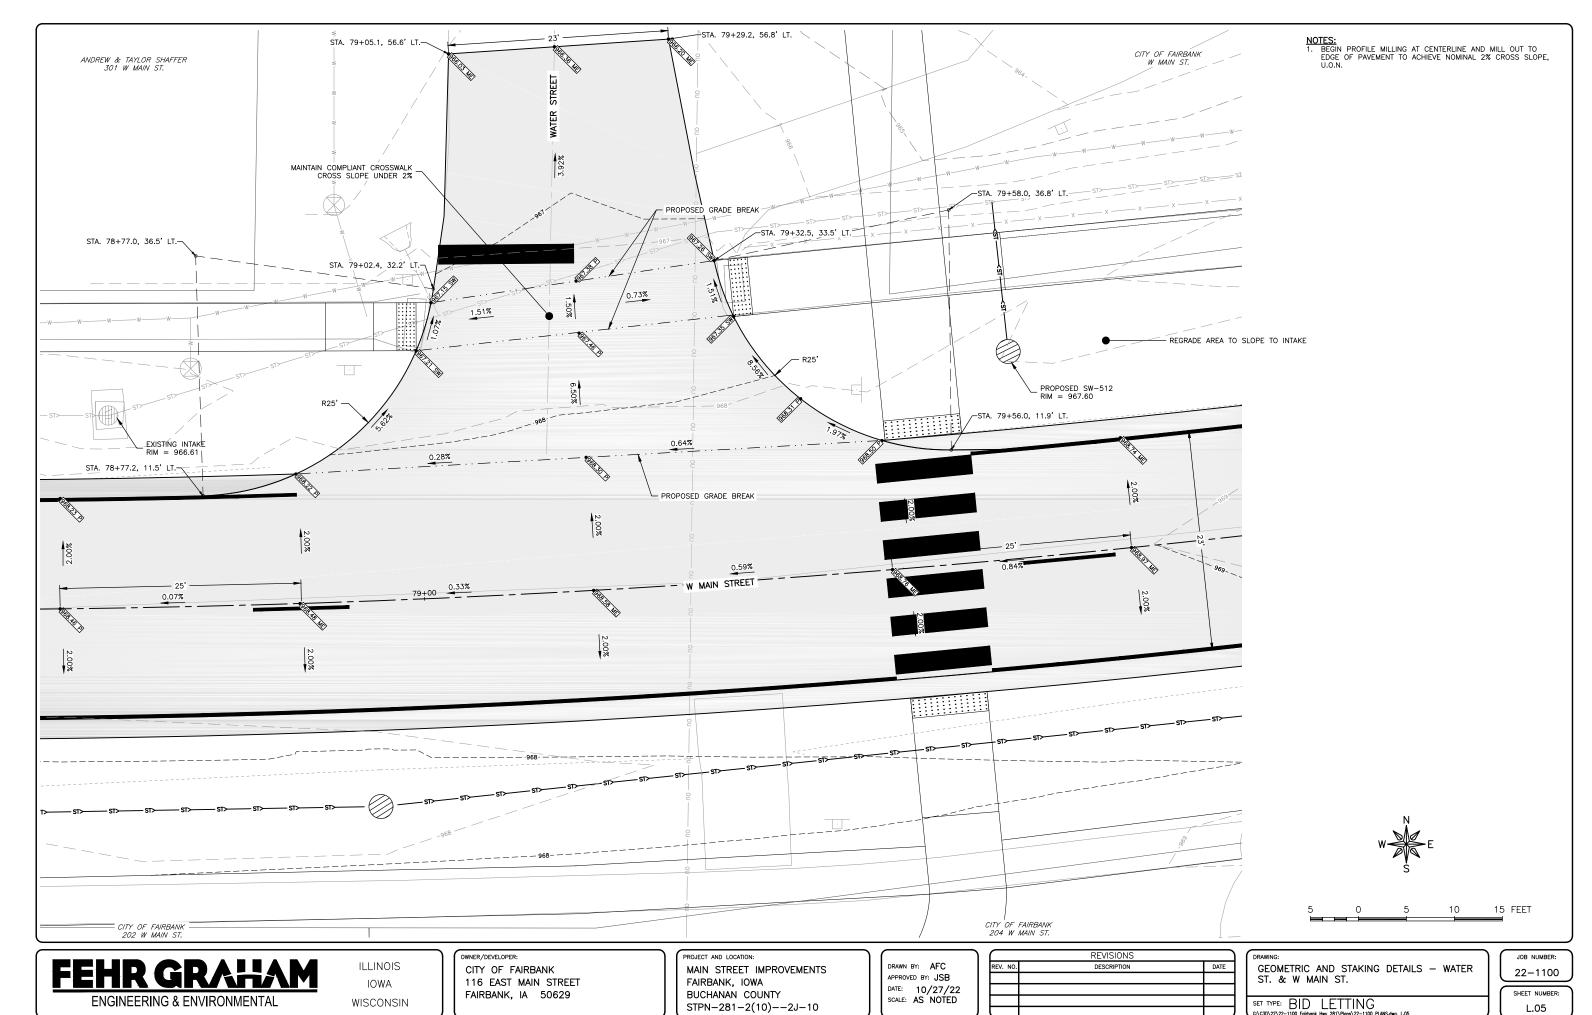

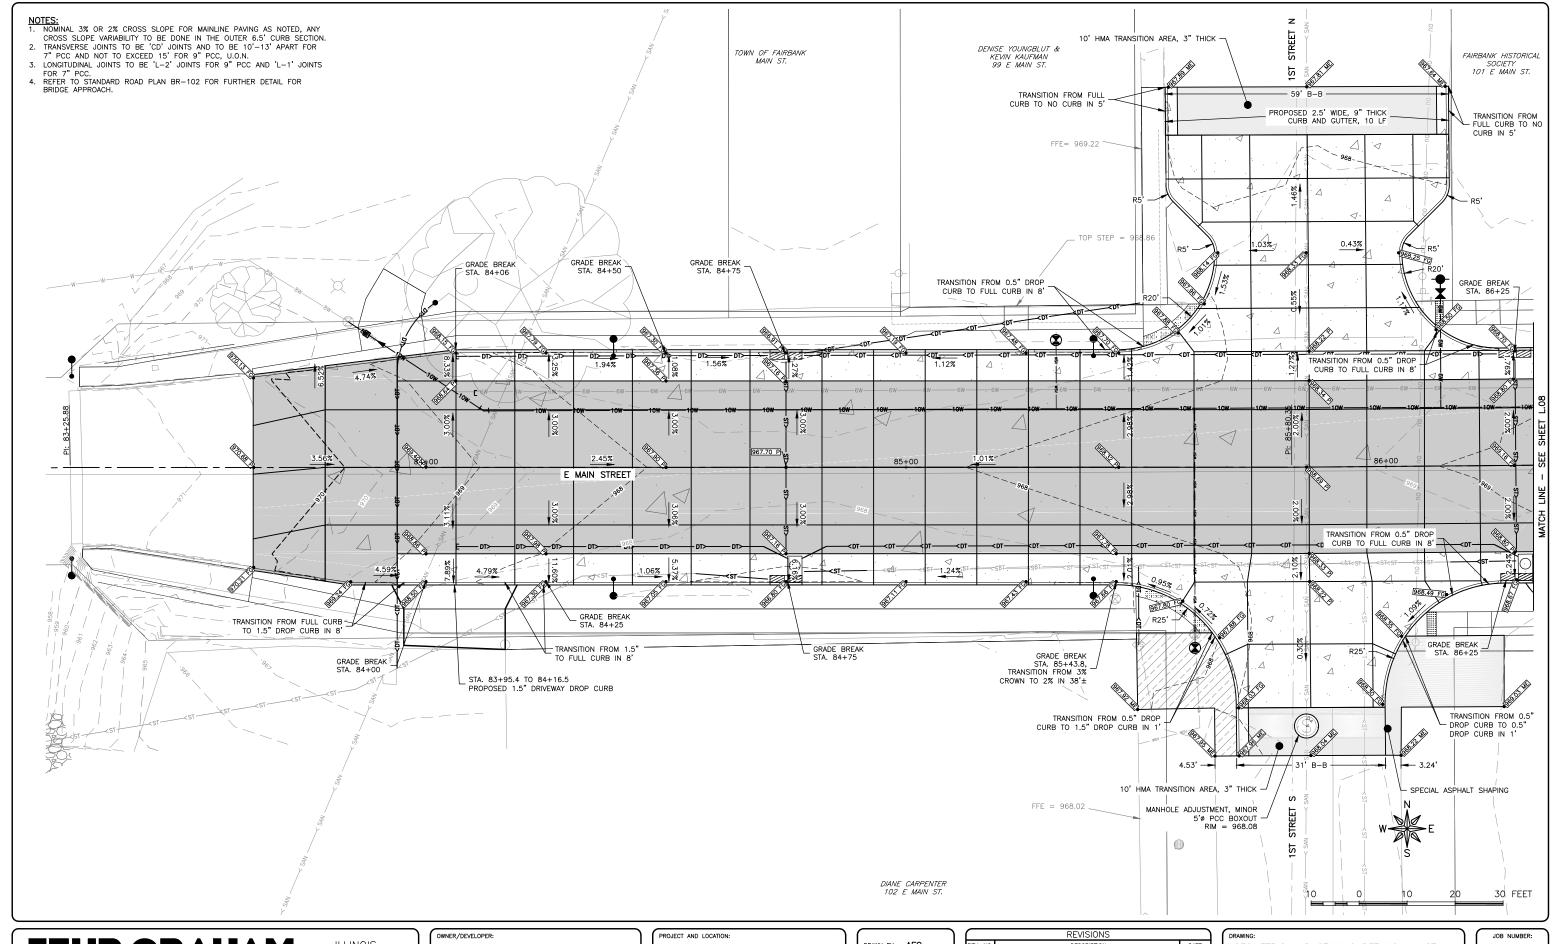

ILLINOIS IOWA WISCONSIN CITY OF FAIRBANK 116 EAST MAIN STREET FAIRBANK, IA 50629 PROJECT AND LOCATION:

MAIN STREET IMPROVEMENTS
FAIRBANK, IOWA
BUCHANAN COUNTY
STPN-281-2(10)--2J-10

DRAWN BY: AFC
APPROVED BY: JSB
DATE: 10/27/22
SCALE: AS NOTED

	REVISIONS	
REV. NO.	DESCRIPTION	DATE

DRAWING:

GEOMETRIC AND STAKING DETAILS — 1ST ST. & E MAIN ST.


SET TYPE: BID LETTING


JOB NUMBER:

22-1100

SHEET NUMBER:

L.06

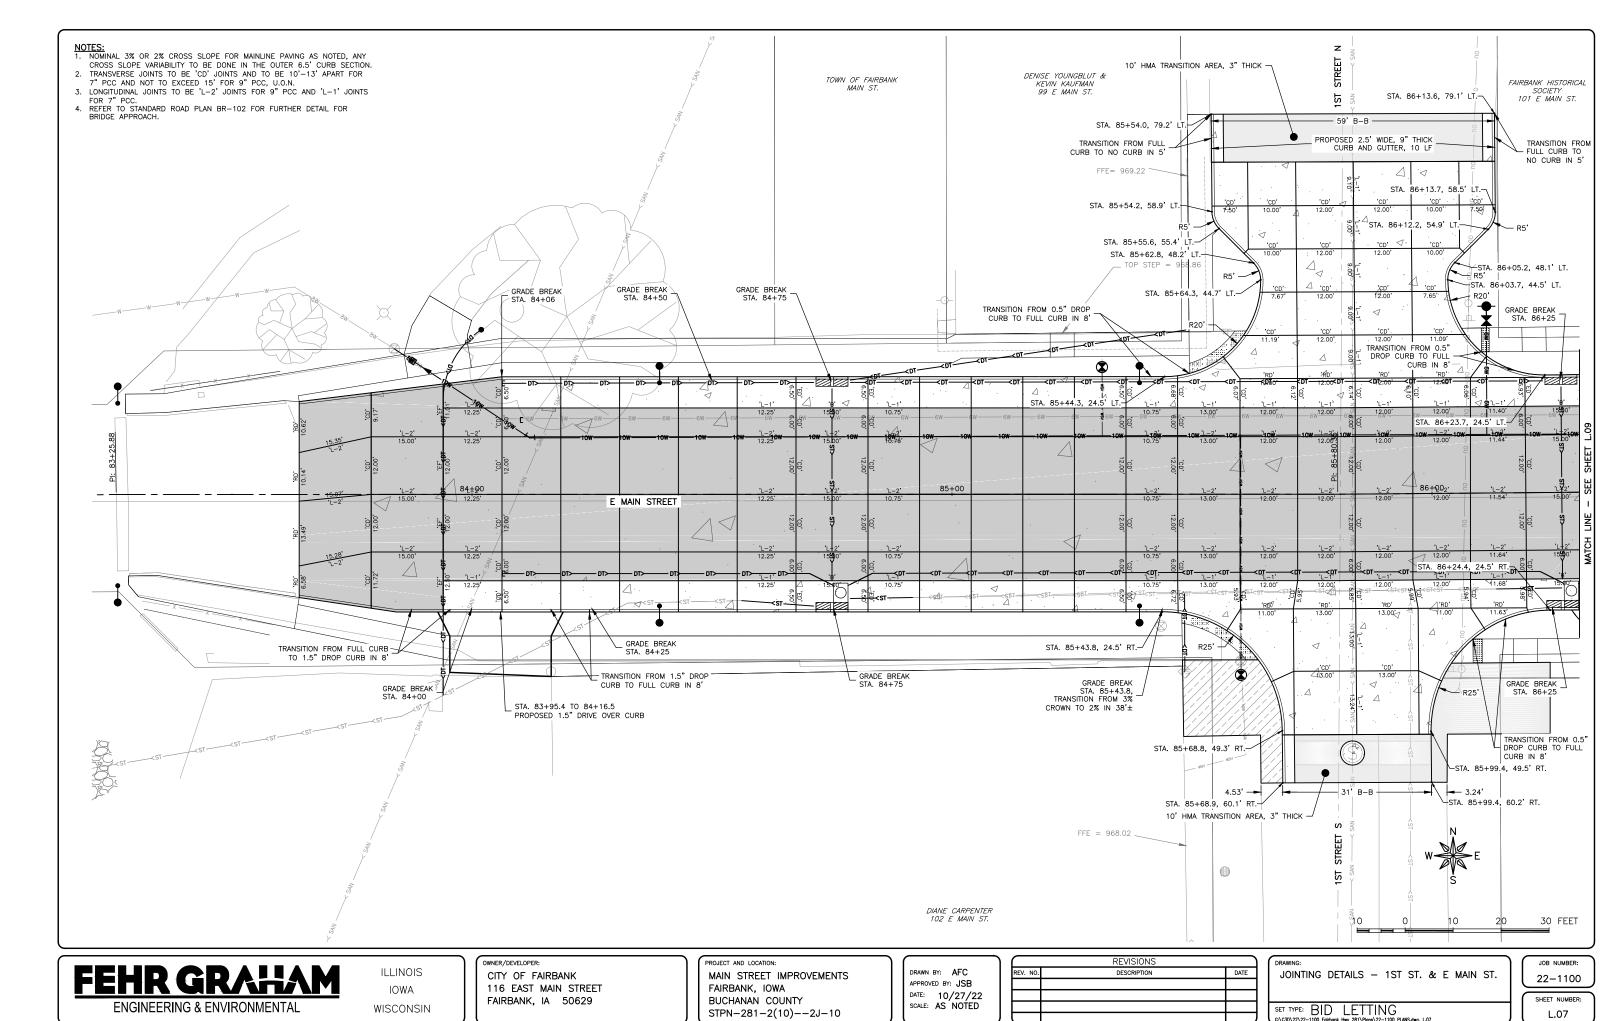

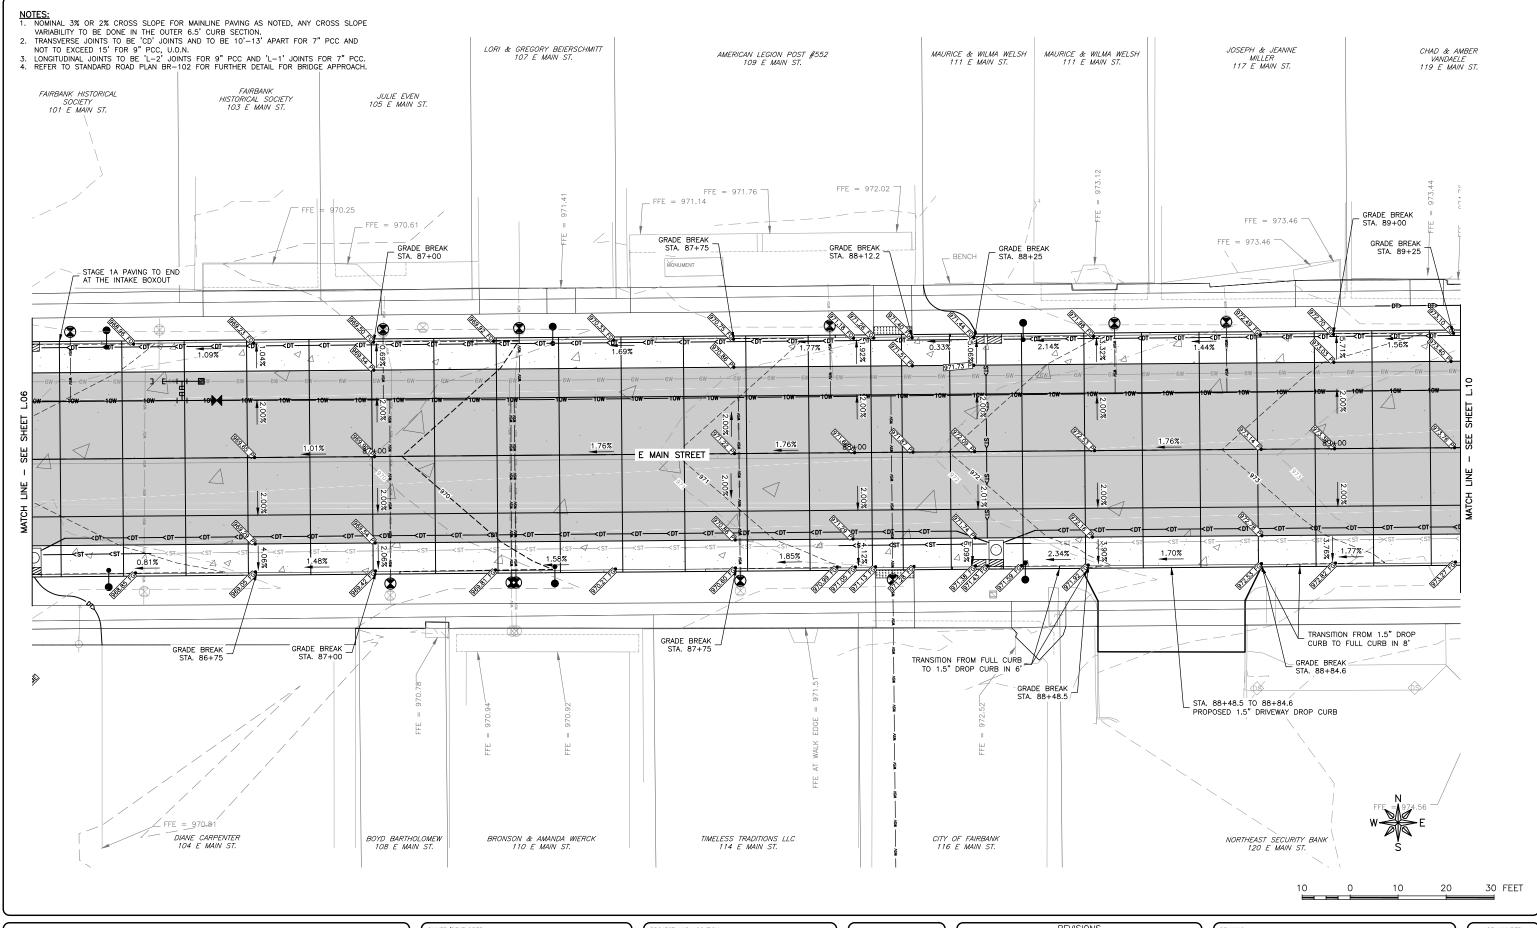

ILLINOIS IOWA WISCONSIN owner/developer:
CITY OF FAIRBANK
116 EAST MAIN STREET
FAIRBANK, IA 50629

PROJECT AND LOCATION:

MAIN STREET IMPROVEMENTS
FAIRBANK, IOWA
BUCHANAN COUNTY
STPN-281-2(10)--2J-10

DRAWN BY: AFC
APPROVED BY: JSB
DATE: 10/27/22
SCALE: AS NOTED

	REVISIONS	•
REV. NO.	DESCRIPTION	DATE

DRAWING:


GEOMETRIC AND STAKING DETAILS — E
MAIN ST.

SET TYPE: BID LETTING

JOB NUMBER:
22-1100

SHEET NUMBER:

L.08

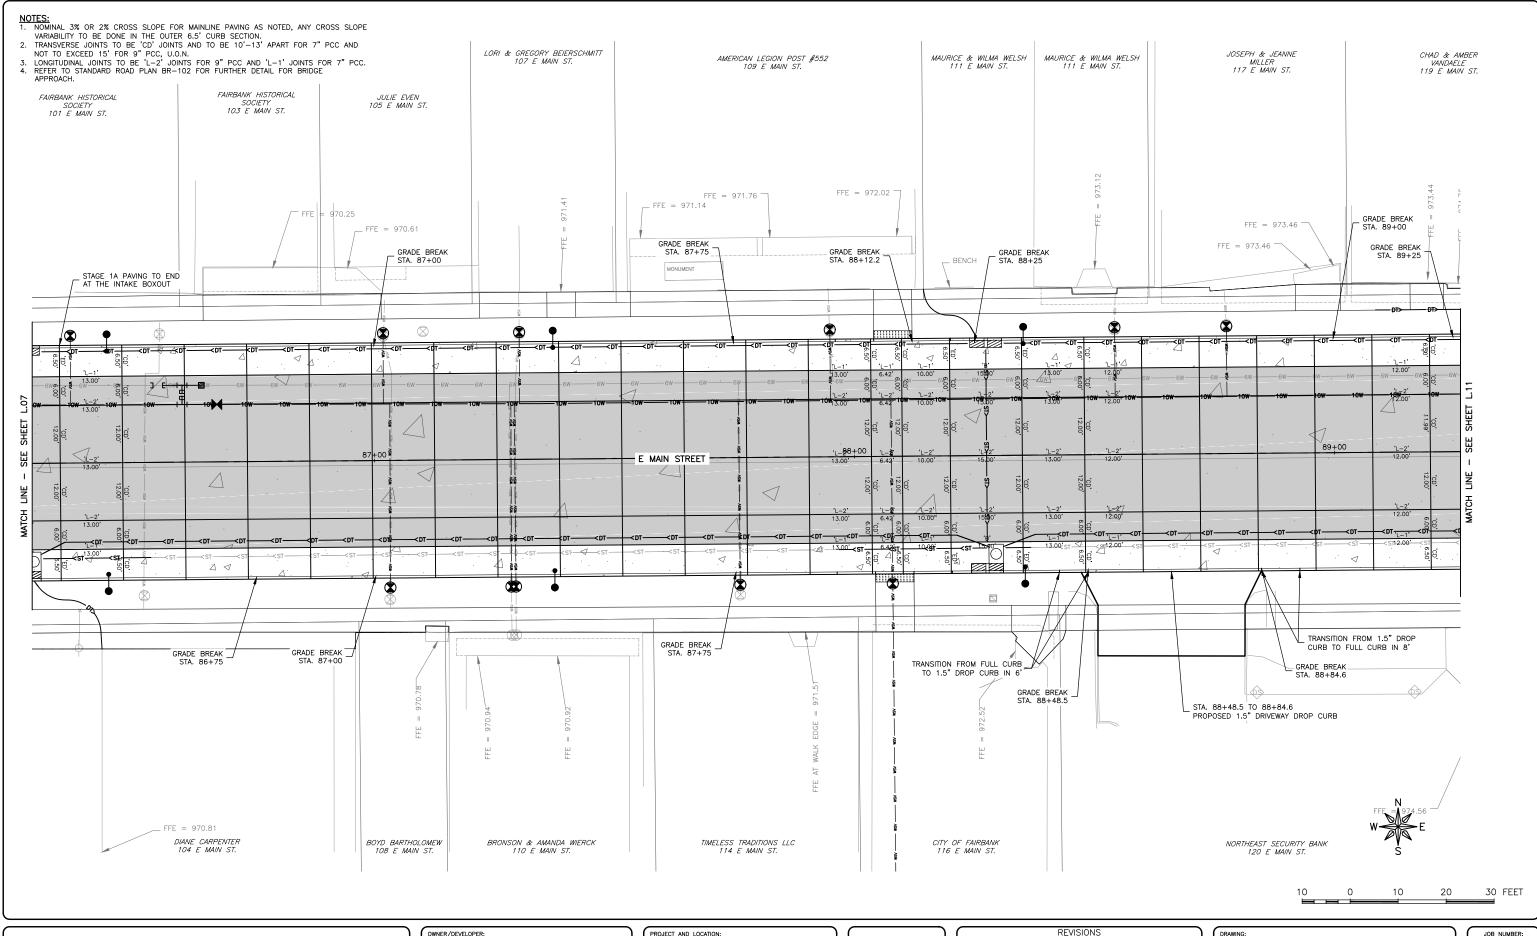

ILLINOIS IOWA WISCONSIN CITY OF FAIRBANK 116 EAST MAIN STREET FAIRBANK, IA 50629 PROJECT AND LOCATION:

MAIN STREET IMPROVEMENTS
FAIRBANK, IOWA
BUCHANAN COUNTY
STPN-281-2(10)--2J-10

DRAWN BY: AFC
APPROVED BY: JSB
DATE: 10/27/22
SCALE: AS NOTED

	REVISIONS	
REV. NO.	DESCRIPTION	DATE

DRAWING:


JOINTING DETAILS — E MAIN ST.

SET TYPE: BID LETTING

GCCW/27/22-1100 Foldback Hav. 28/19 Broad-122-1100 FIANS-date. L09

JOB NUMBER: 22-1100

SHEET NUMBER: L.09

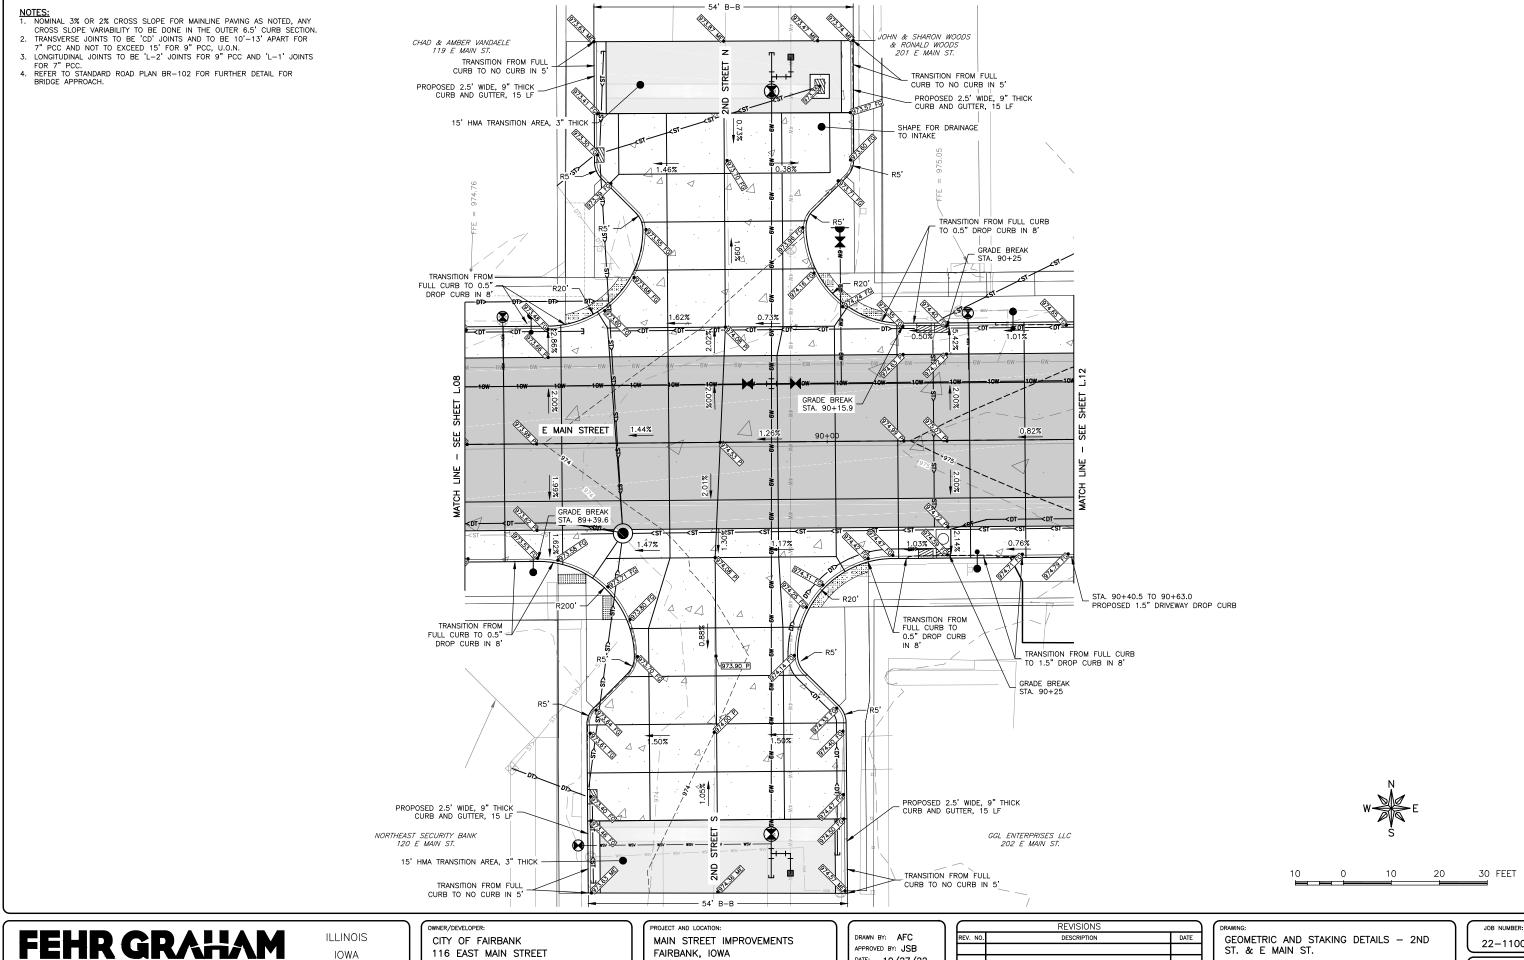

IOWA

WISCONSIN

116 EAST MAIN STREET FAIRBANK, IA 50629

FAIRBANK, IOWA BUCHANAN COUNTY STPN-281-2(10)--2J-10


APPROVED BY: JSB DATE: 10/27/22 SCALE: AS NOTED


	REVISIONS	
REV. NO.	DESCRIPTION	DATE

ST. & E MAIN ST.

SET TYPE: BID LETTING

22-1100 SHEET NUMBER:

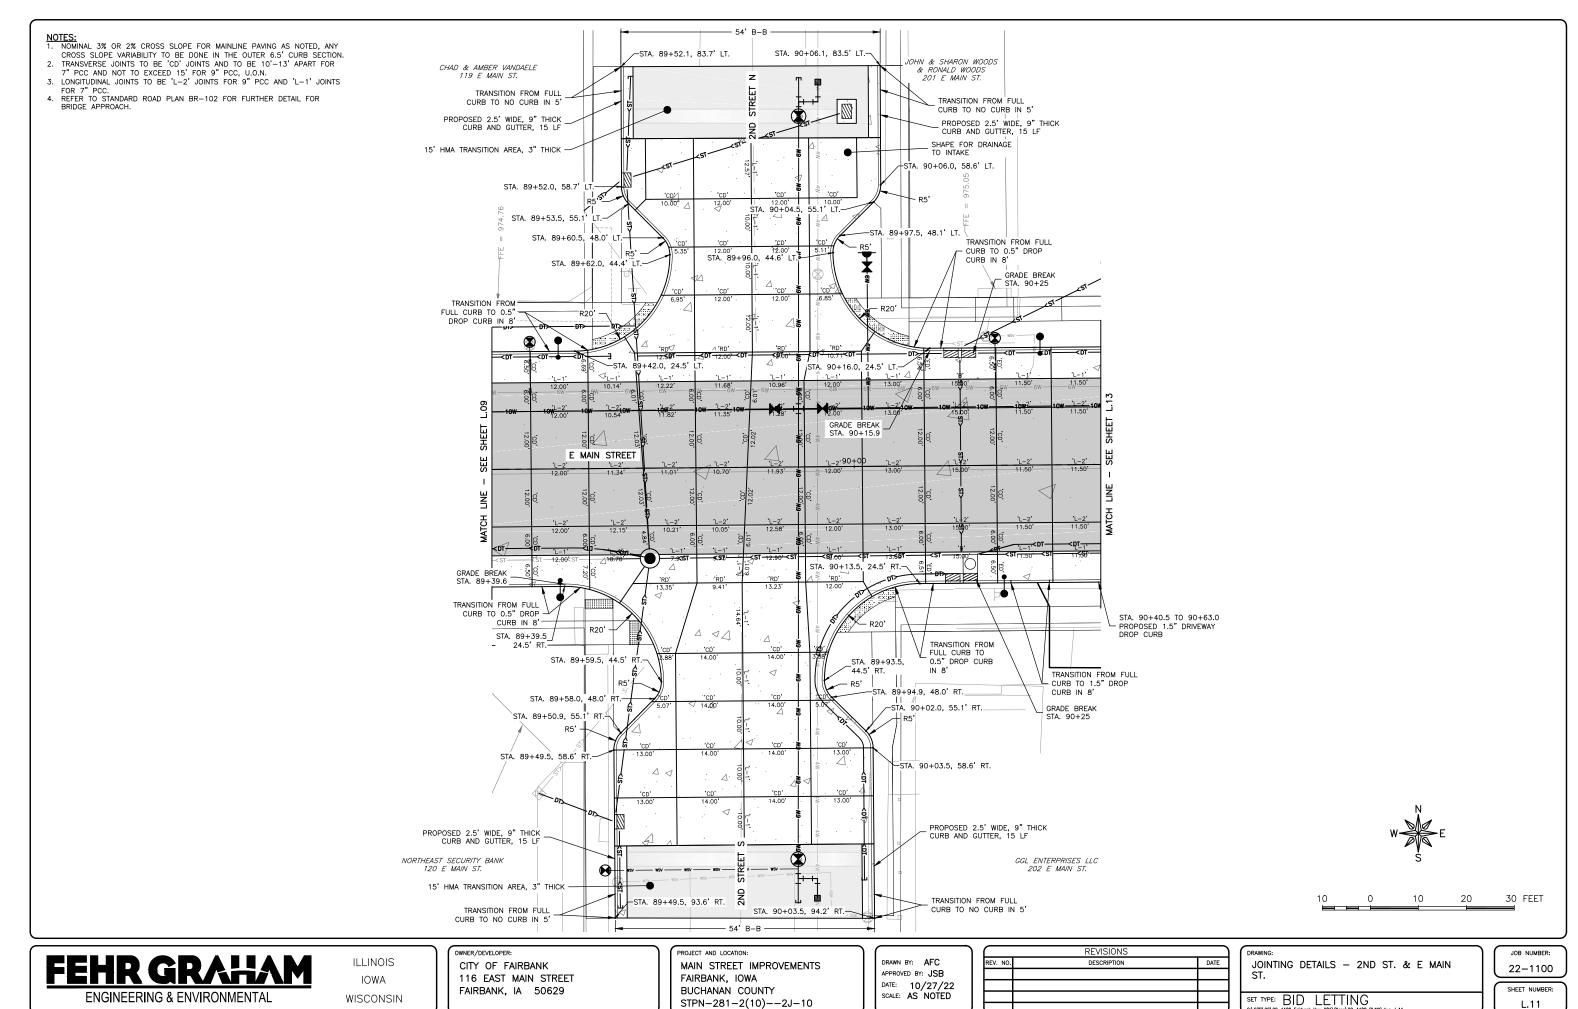

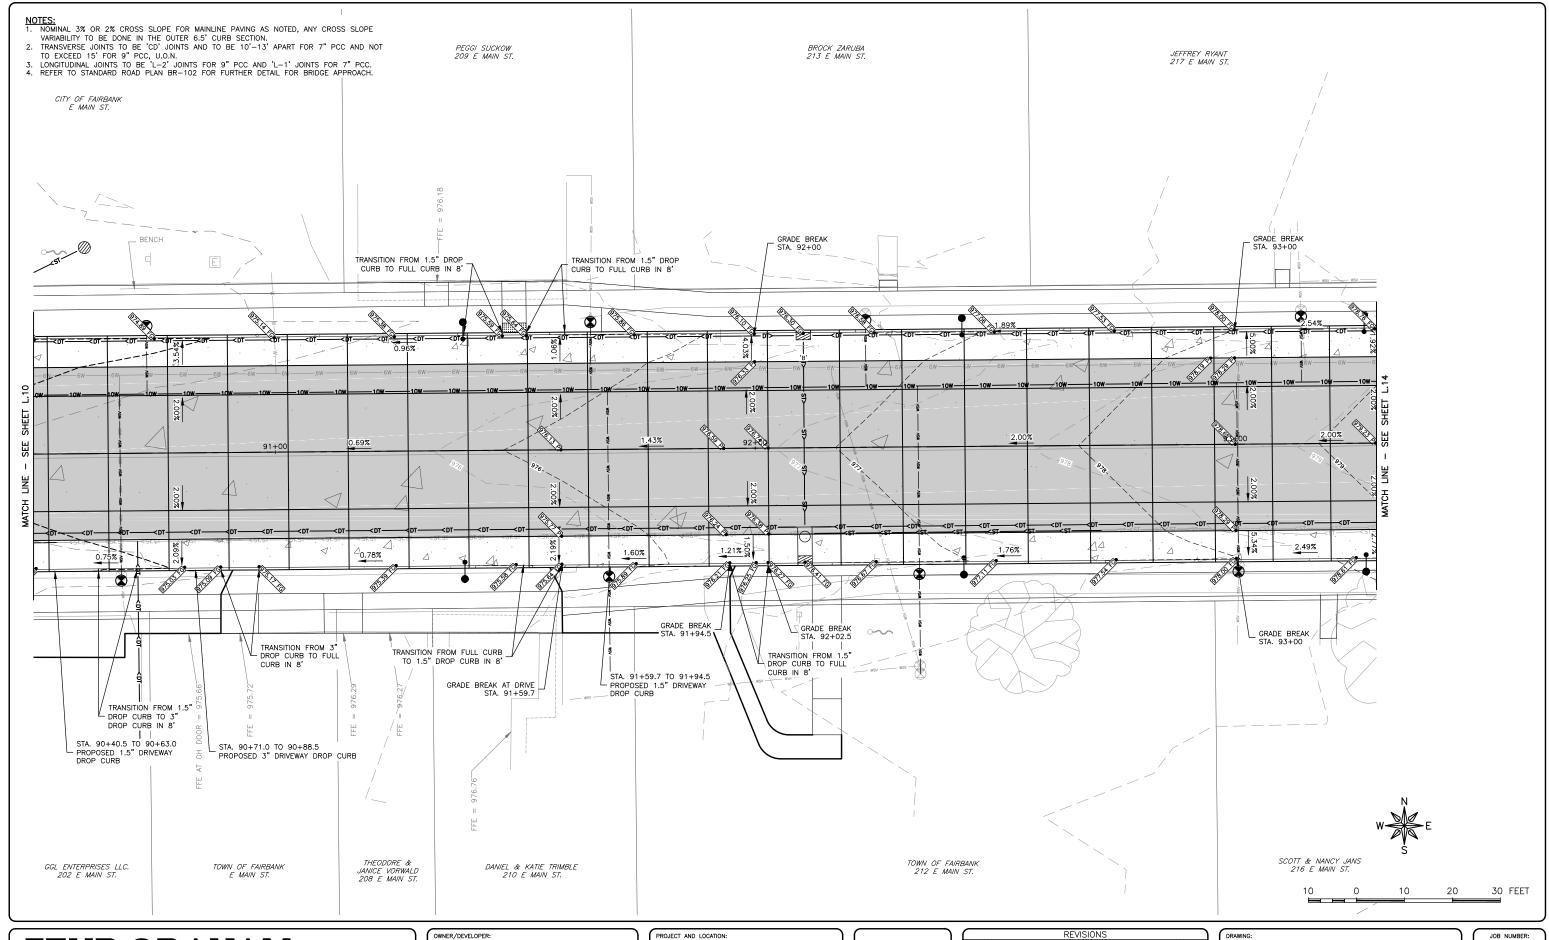



ILLINOIS IOWA WISCONSIN OWNER/DEVELOPER:

CITY OF FAIRBANK

116 EAST MAIN STREET
FAIRBANK, IA 50629

MAIN STREET IMPROVEMENTS
FAIRBANK, IOWA
BUCHANAN COUNTY
STPN-281-2(10)--2J-10

DRAWN BY: AFC
APPROVED BY: JSB
DATE: 10/27/22
SCALE: AS NOTED

	REVISIONS	
REV. NO.	DESCRIPTION	DATE


DRAWING: GEOMETRIC AND STAKING DETAILS — E MAIN ST.

SET TYPE: BID LETTING

JOB NUMBER:

22-1100

SHEET NUMBER:

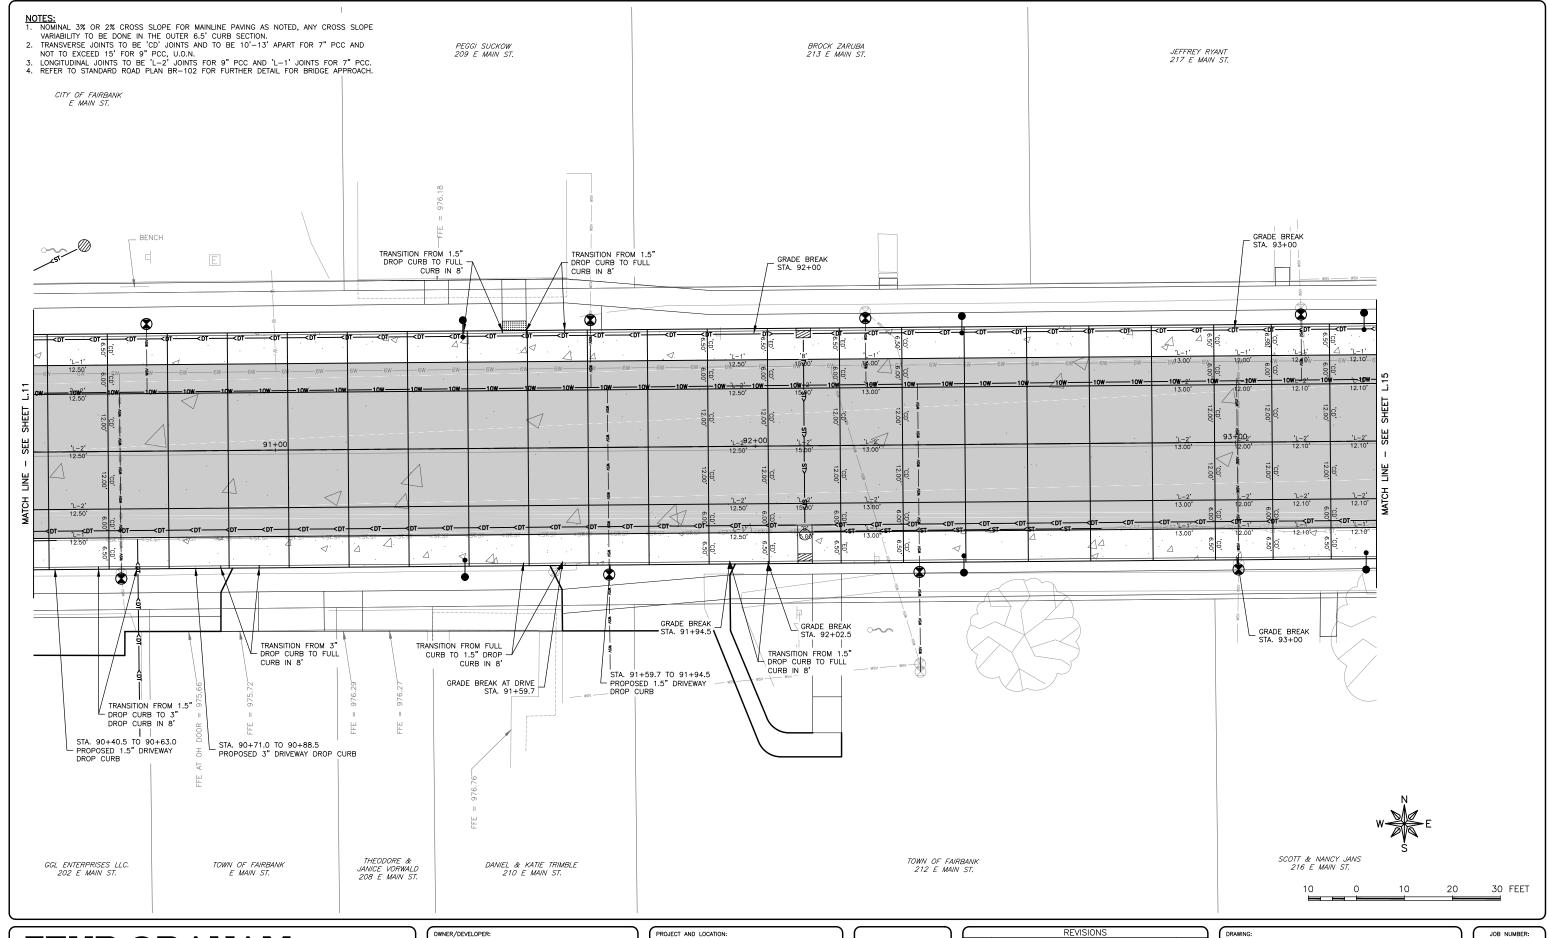



ILLINOIS IOWA WISCONSIN OWNER/DEVELOPER:
CITY OF FAIRBANK
116 EAST MAIN STREET
FAIRBANK, IA 50629

PROJECT AND LOCATION:

MAIN STREET IMPROVEMENTS
FAIRBANK, IOWA
BUCHANAN COUNTY
STPN-281-2(10)--2J-10

DRAWN BY: AFC
APPROVED BY: JSB
DATE: 10/27/22
SCALE: AS NOTED


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REV. NO.	DESCRIPTION	DATE	
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DRAWING:
JOINTING DETAILS — E MAIN ST.

SET TYPE: BID LETTING

JOB NUMBER:
22-1100

SHEET NUMBER:
L.13

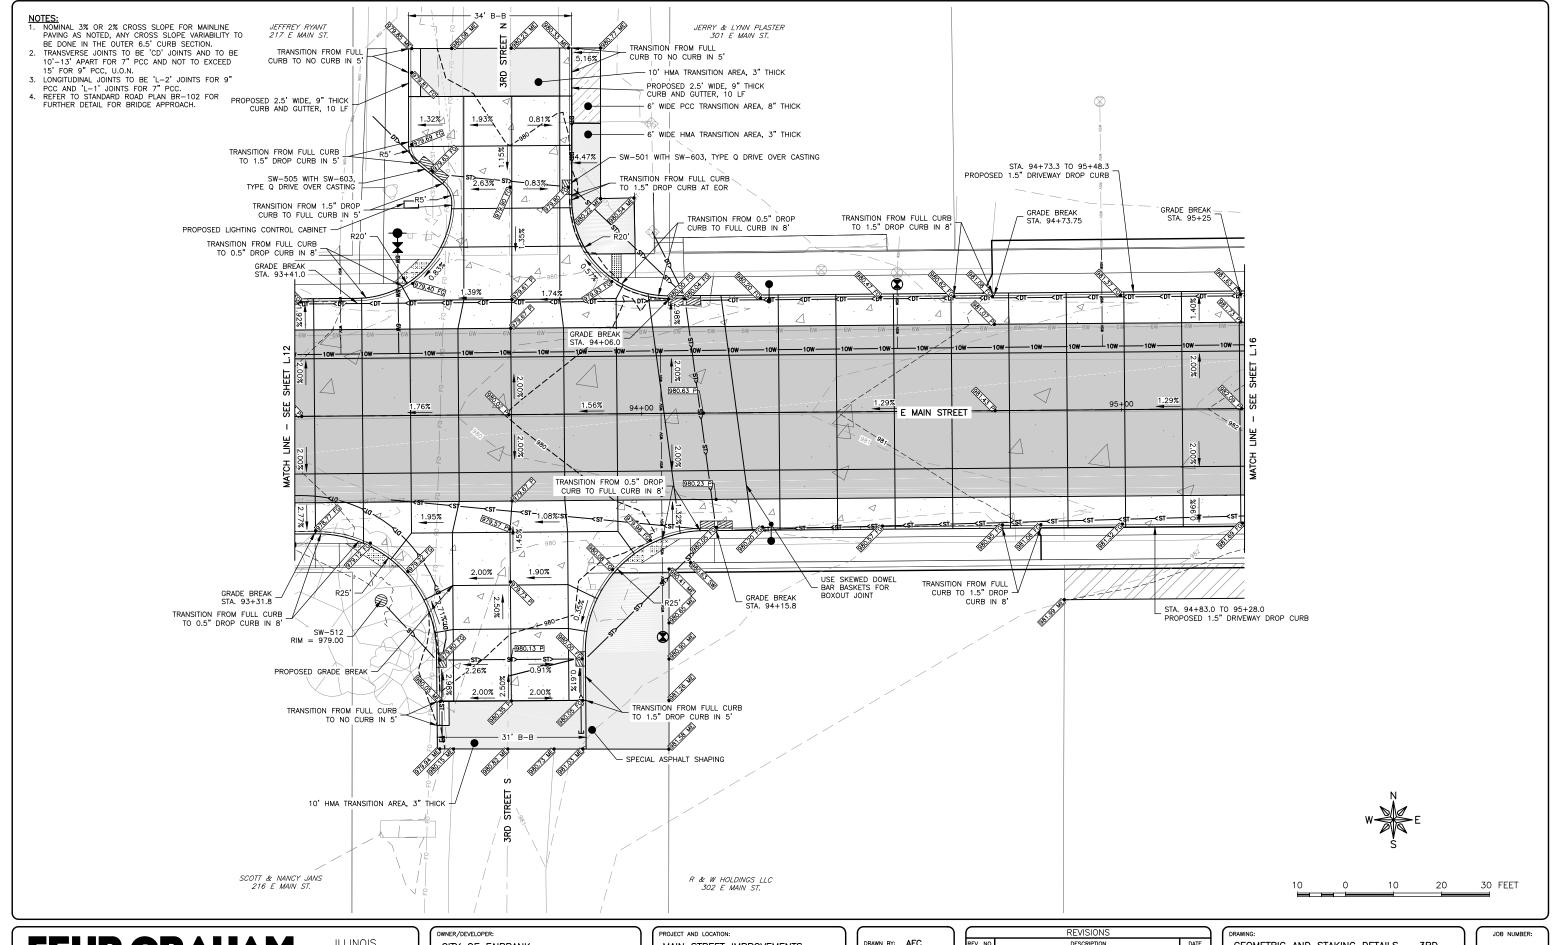

ILLINOIS IOWA

WISCONSIN

CITY OF FAIRBANK 116 EAST MAIN STREET FAIRBANK, IA 50629 PROJECT AND LOCATION:

MAIN STREET IMPROVEMENTS
FAIRBANK, IOWA
BUCHANAN COUNTY
STPN-281-2(10)--2J-10

DRAWN BY: AFC
APPROVED BY: JSB
DATE: 10/27/22
SCALE: AS NOTED

	REVISIONS	
REV. NO.	DESCRIPTION	DATE


GEOMETRIC AND STAKING DETAILS — 3RD ST. & E MAIN ST.

SET TYPE: BID LETTING
G\C30\22\22-1100 Fairbank Hwy 28\\Plans\22-1100 PIANS.dwa. L.1

22-1100

SHEET NUMBER:

L.14

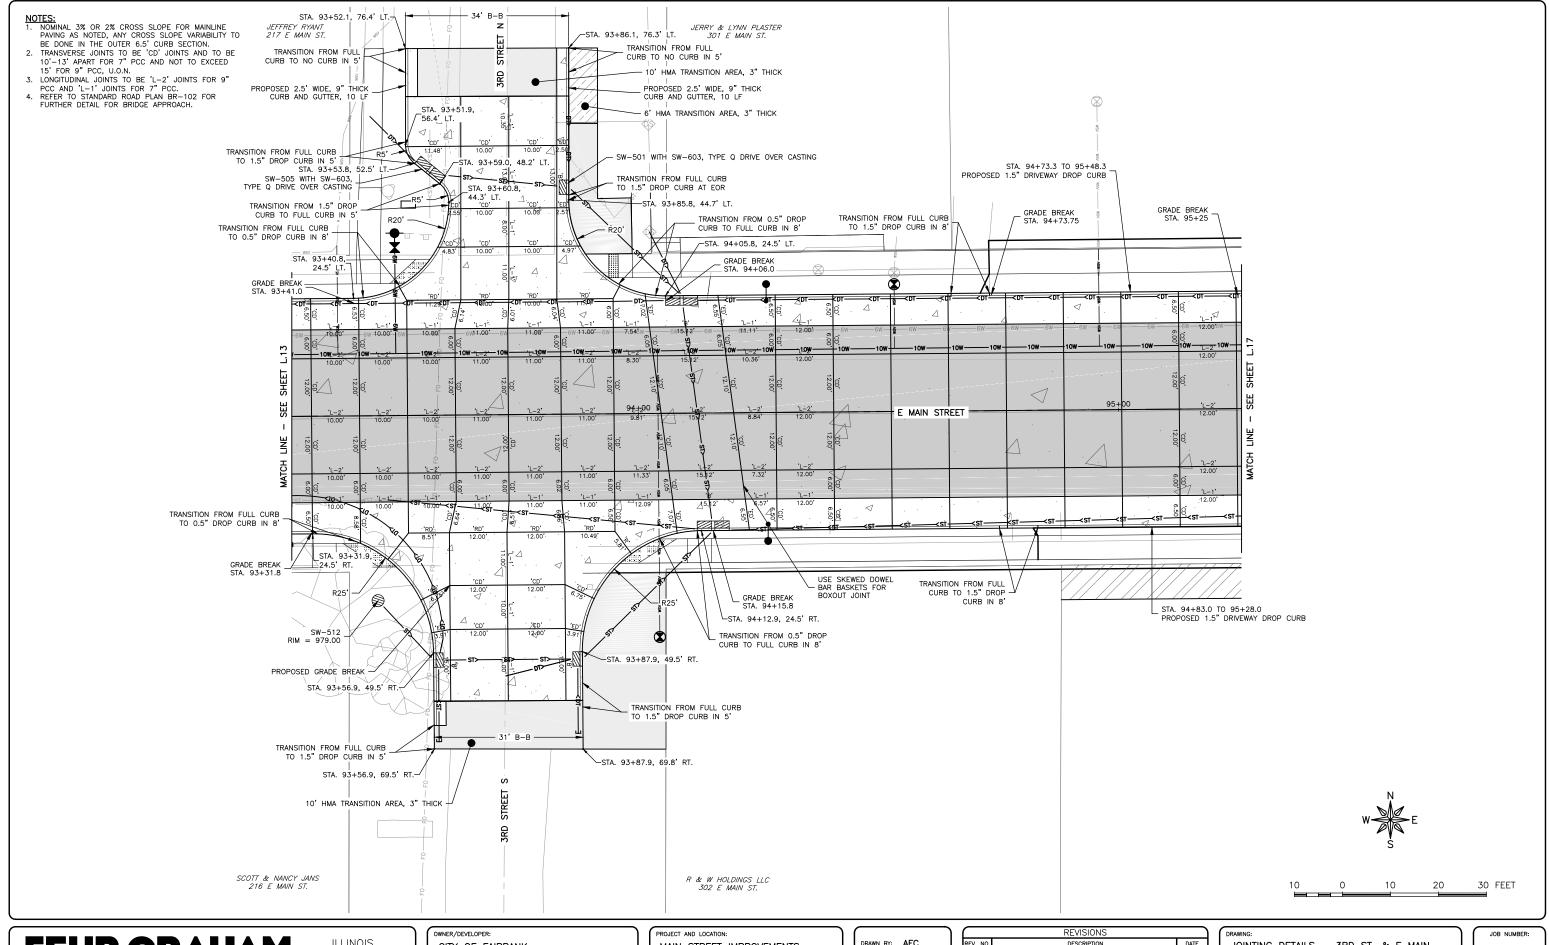

ILLINOIS IOWA

WISCONSIN

CITY OF FAIRBANK 116 EAST MAIN STREET FAIRBANK, IA 50629 MAIN STREET IMPROVEMENTS
FAIRBANK, IOWA
BUCHANAN COUNTY
STPN-281-2(10)--2J-10

DRAWN BY: AFC
APPROVED BY: JSB
DATE: 10/27/22
SCALE: AS NOTED

	REVISIONS	
REV. NO.	DESCRIPTION	DATE


JOINTING DETAILS — 3RD ST. & E MAIN ST.

SET TYPE: BID LETTING
GACTON 22/22-1100 Englands Name 28/19 Proph 22/2-1100 BIANS Amer. L. 15

22-1100

SHEET NUMBER:

L.15

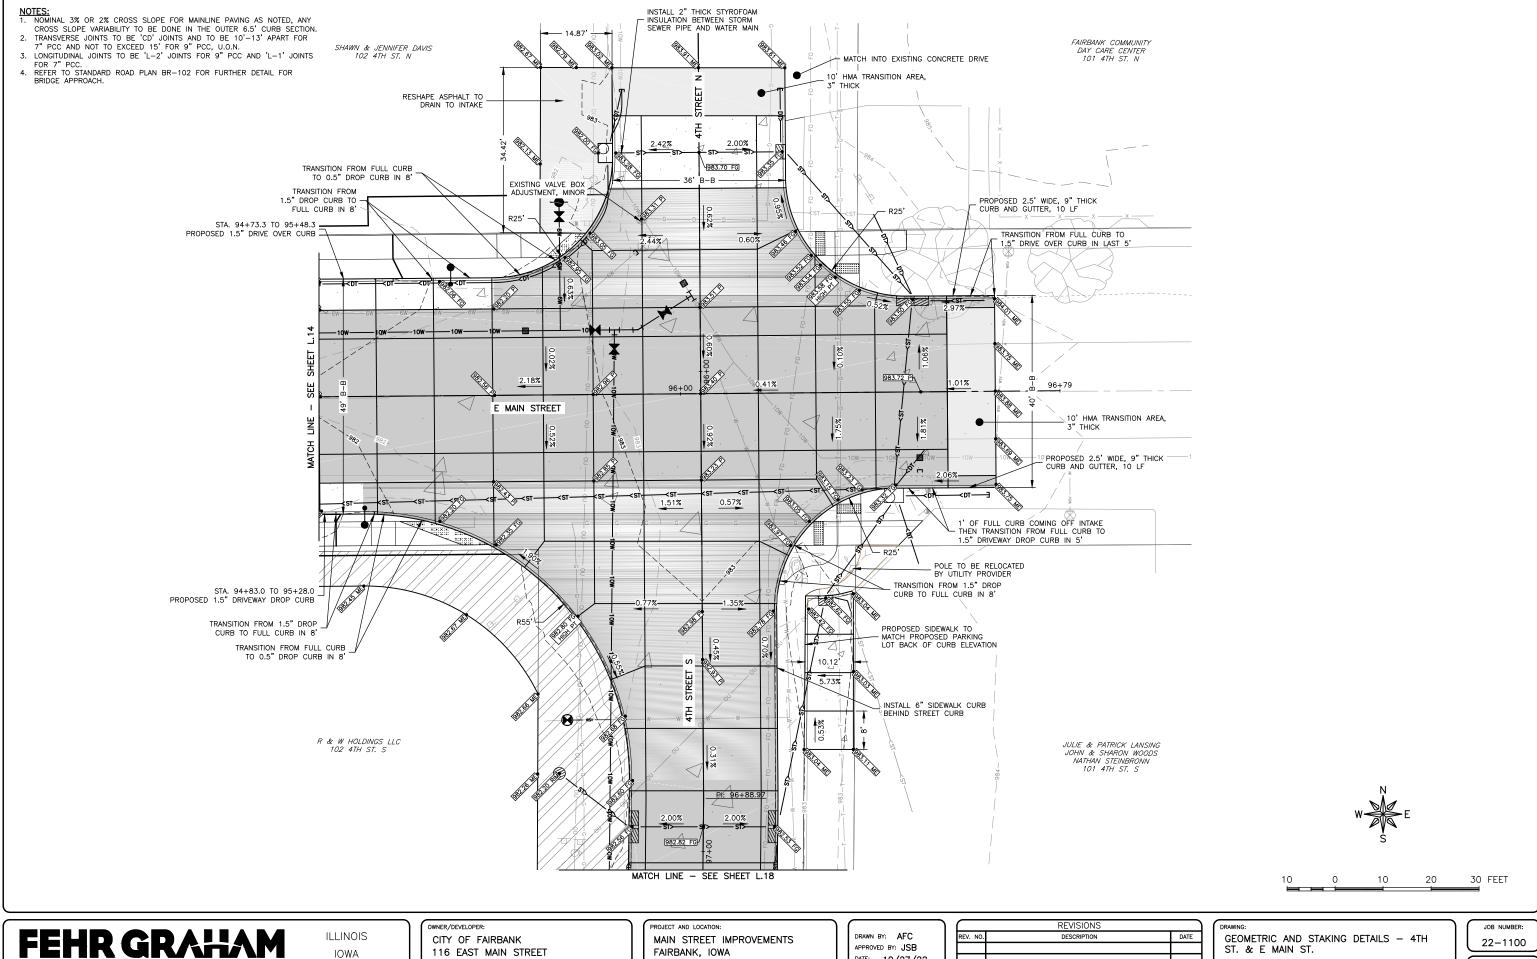

PLOT DATE: 10/31/22 © 2022 FEHR GRAHAM

ENGINEERING & ENVIRONMENTAL

116 EAST MAIN STREET

FAIRBANK, IA 50629

IOWA

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FAIRBANK, IOWA BUCHANAN COUNTY STPN-281-2(10)--2J-10

APPROVED BY: JSB DATE: 10/27/22 SCALE: AS NOTED


			REVISIONS	
	REV.	NO.	DESCRIPTION	DATE
2				
)				

GEOMETRIC AND STAKING DETAILS - 4TH ST. & E MAIN ST.

SET TYPE: BID LETTING

22-1100

SHEET NUMBER: L.16

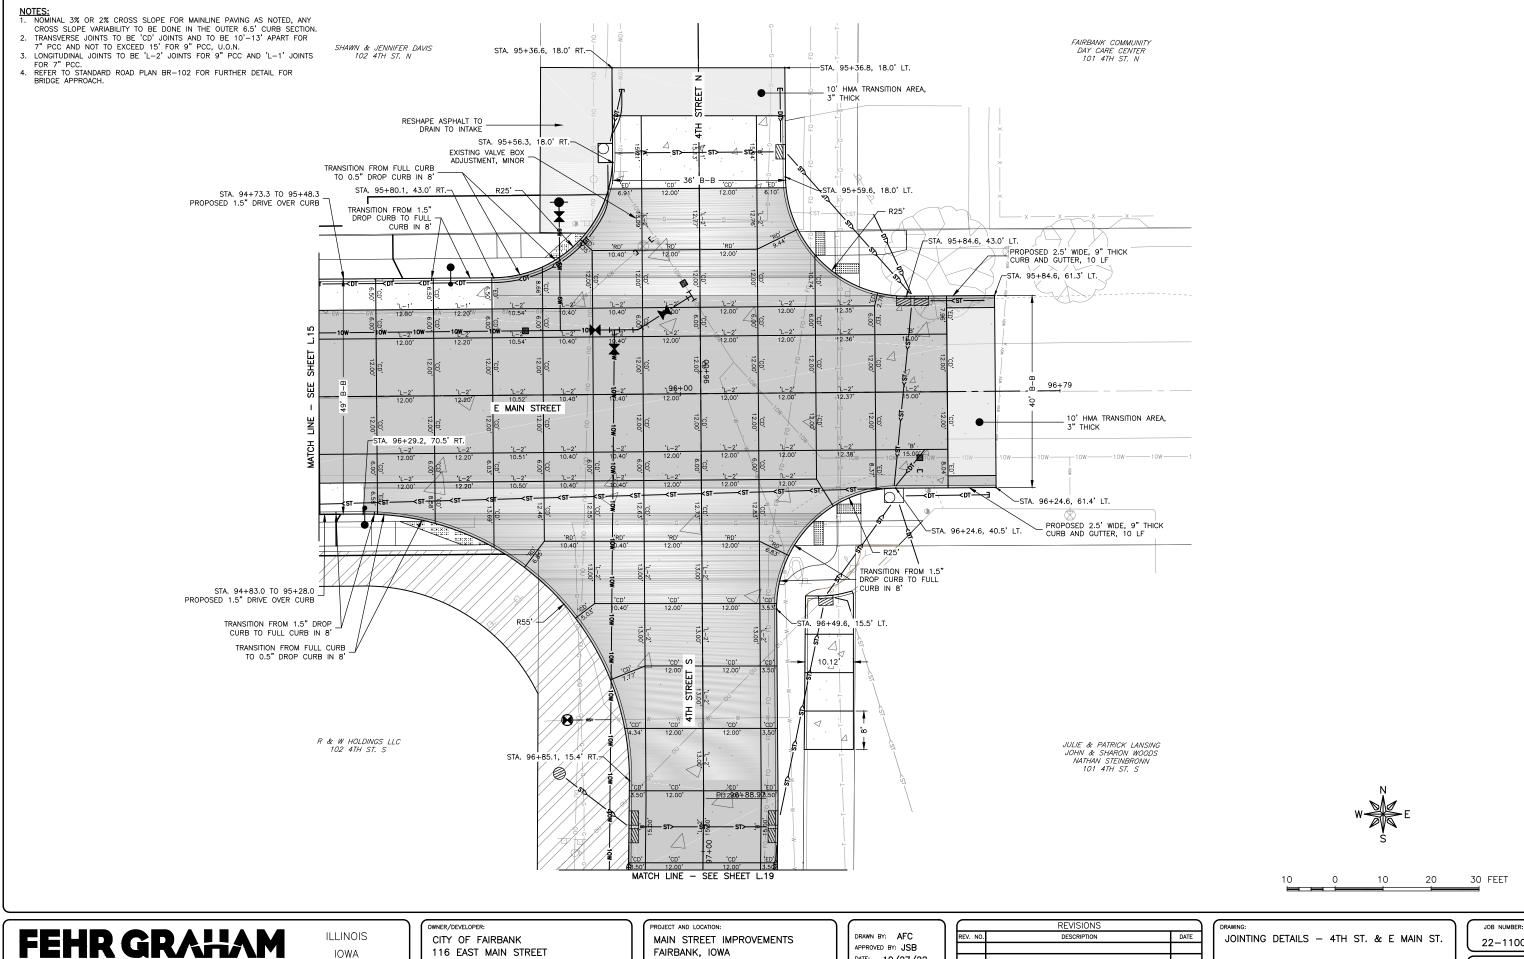

PLOT DATE: 10/31/22 © 2022 FEHR GRAHAM

ENGINEERING & ENVIRONMENTAL

116 EAST MAIN STREET FAIRBANK, IA 50629

WISCONSIN


FAIRBANK, IOWA BUCHANAN COUNTY STPN-281-2(10)--2J-10

APPROVED BY: JSB DATE: 10/27/22 SCALE: AS NOTED

	REVISIONS]
REV. NO.	DESCRIPTION	DATE

SET TYPE: BID LETTING

22-1100 SHEET NUMBER:

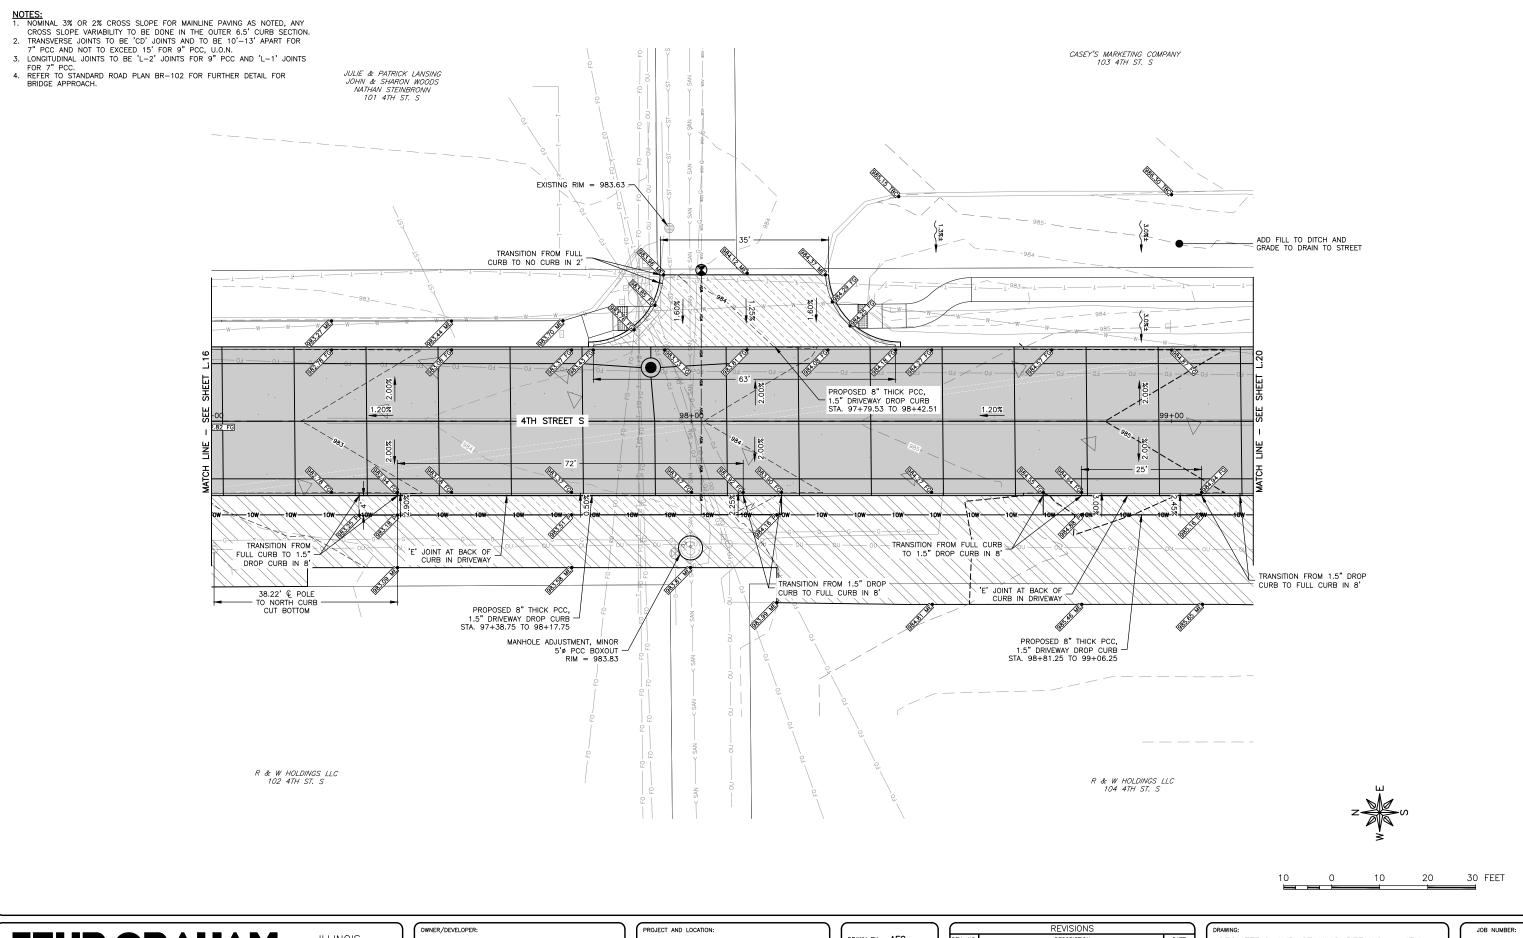

ILLINOIS IOWA WISCONSIN CITY OF FAIRBANK 116 EAST MAIN STREET FAIRBANK, IA 50629 MAIN STREET IMPROVEMENTS
FAIRBANK, IOWA
BUCHANAN COUNTY
STPN-281-2(10)--2J-10

DRAWN BY: AFC
APPROVED BY: JSB
DATE: 10/27/22
SCALE: AS NOTED

	REVISIONS	
REV. NO.	DESCRIPTION	DATE
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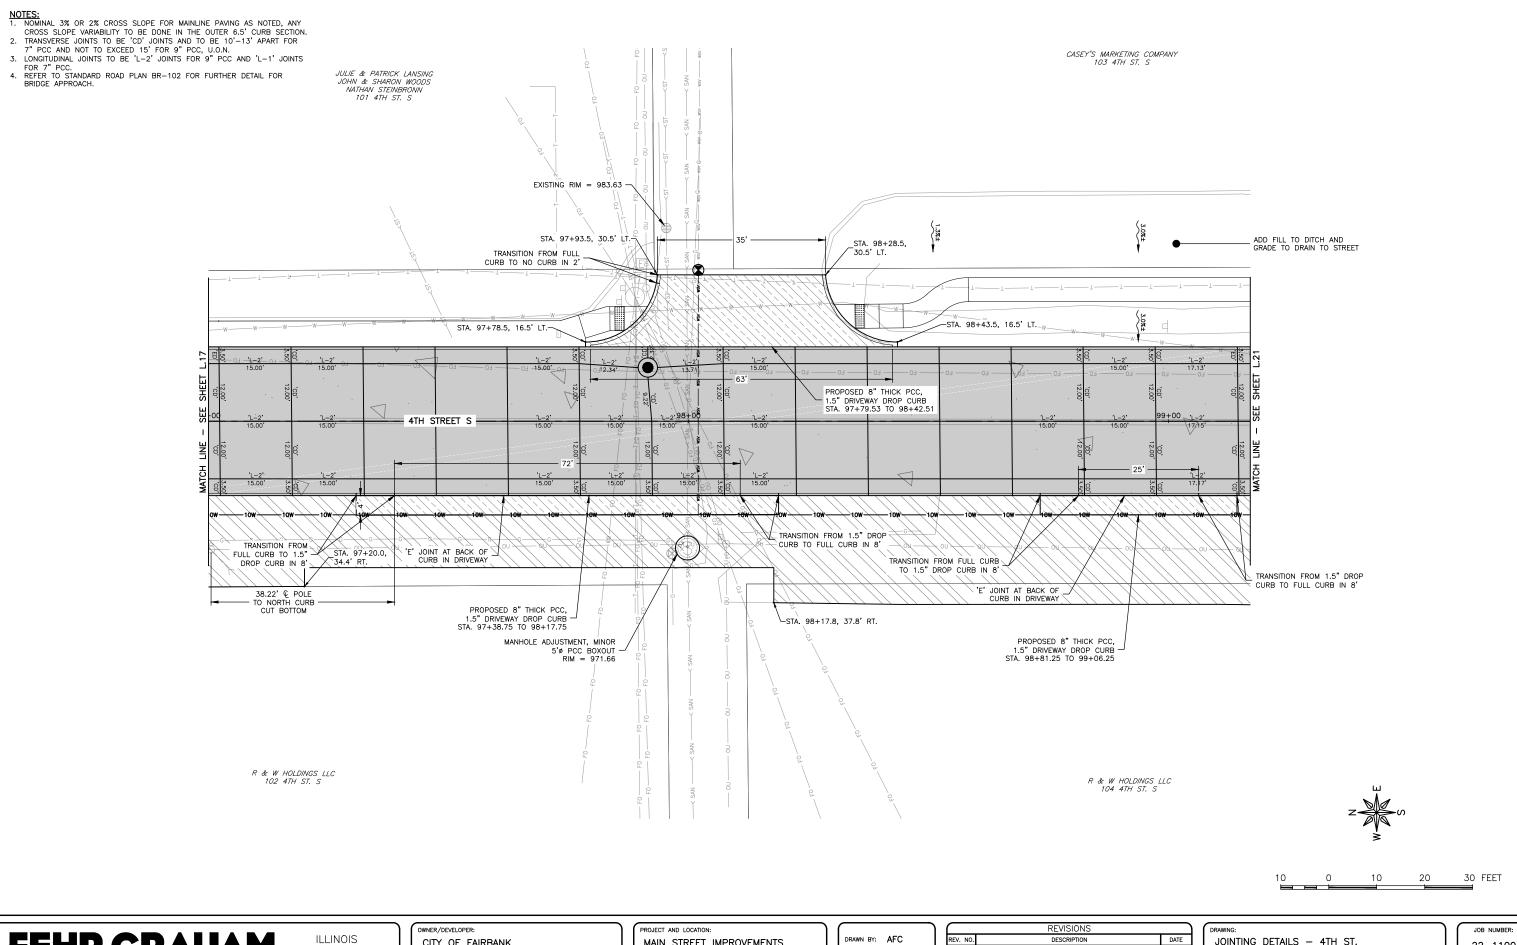
GEOMETRIC AND STAKING DETAILS — 4TH ST.

SET TYPE: BID LETTING
G\C3D\22\22-1100 Fairbank Hwy 281\Plans\22-1100 PLANS.dwa. L18

JOB NUMBER:

22-1100

SHEET NUMBER:





ILLINOIS IOWA

WISCONSIN

CITY OF FAIRBANK 116 EAST MAIN STREET FAIRBANK, IA 50629 MAIN STREET IMPROVEMENTS
FAIRBANK, IOWA
BUCHANAN COUNTY
STPN-281-2(10)--2J-10

DRAWN BY: AFC
APPROVED BY: JSB
DATE: 10/27/22
SCALE: AS NOTED


	REVISIONS	
REV. NO.	DESCRIPTION	DATE

DRAWING:
JOINTING DETAILS — 4TH ST.

SET TYPE: BID LETTING

JOB NUMBER:
22-1100

SHEET NUMBER:

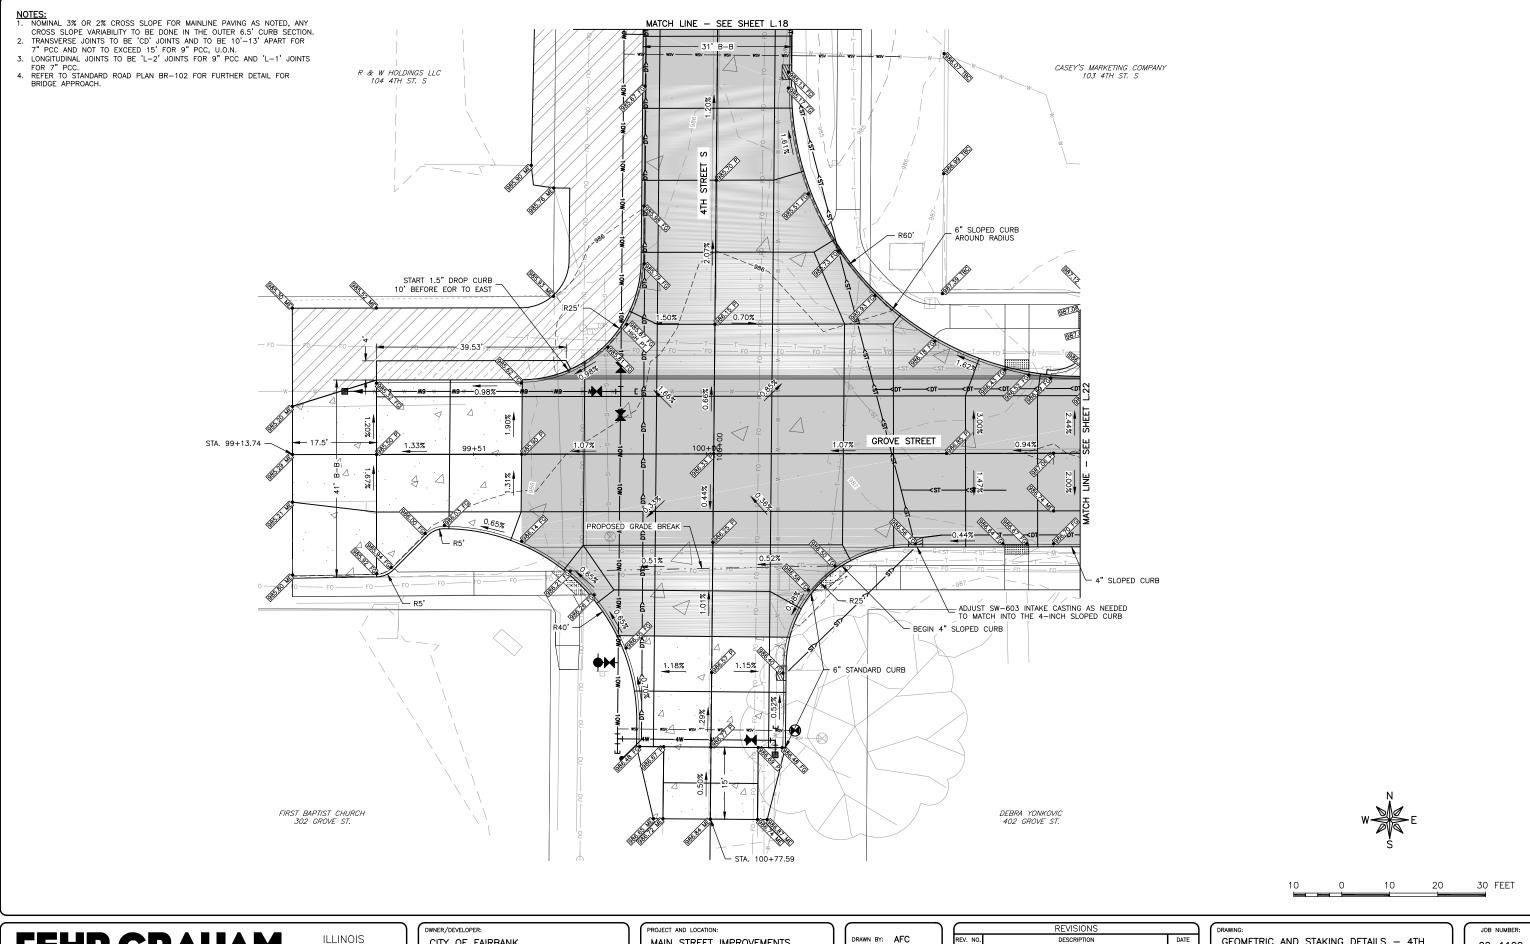

ILLINOIS IOWA

WISCONSIN

CITY OF FAIRBANK 116 EAST MAIN STREET FAIRBANK, IA 50629 MAIN STREET IMPROVEMENTS
FAIRBANK, IOWA
BUCHANAN COUNTY
STPN-281-2(10)--2J-10


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DATE: 10/27/22
SCALE: AS NOTED


REVISIONS		
EV. NO.	DESCRIPTION	DATE

GEOMETRIC AND STAKING DETAILS — 4TH ST. & GROVE ST.

SET TYPE: BID LETTING

22-1100 SHEET NUMBER: L.20

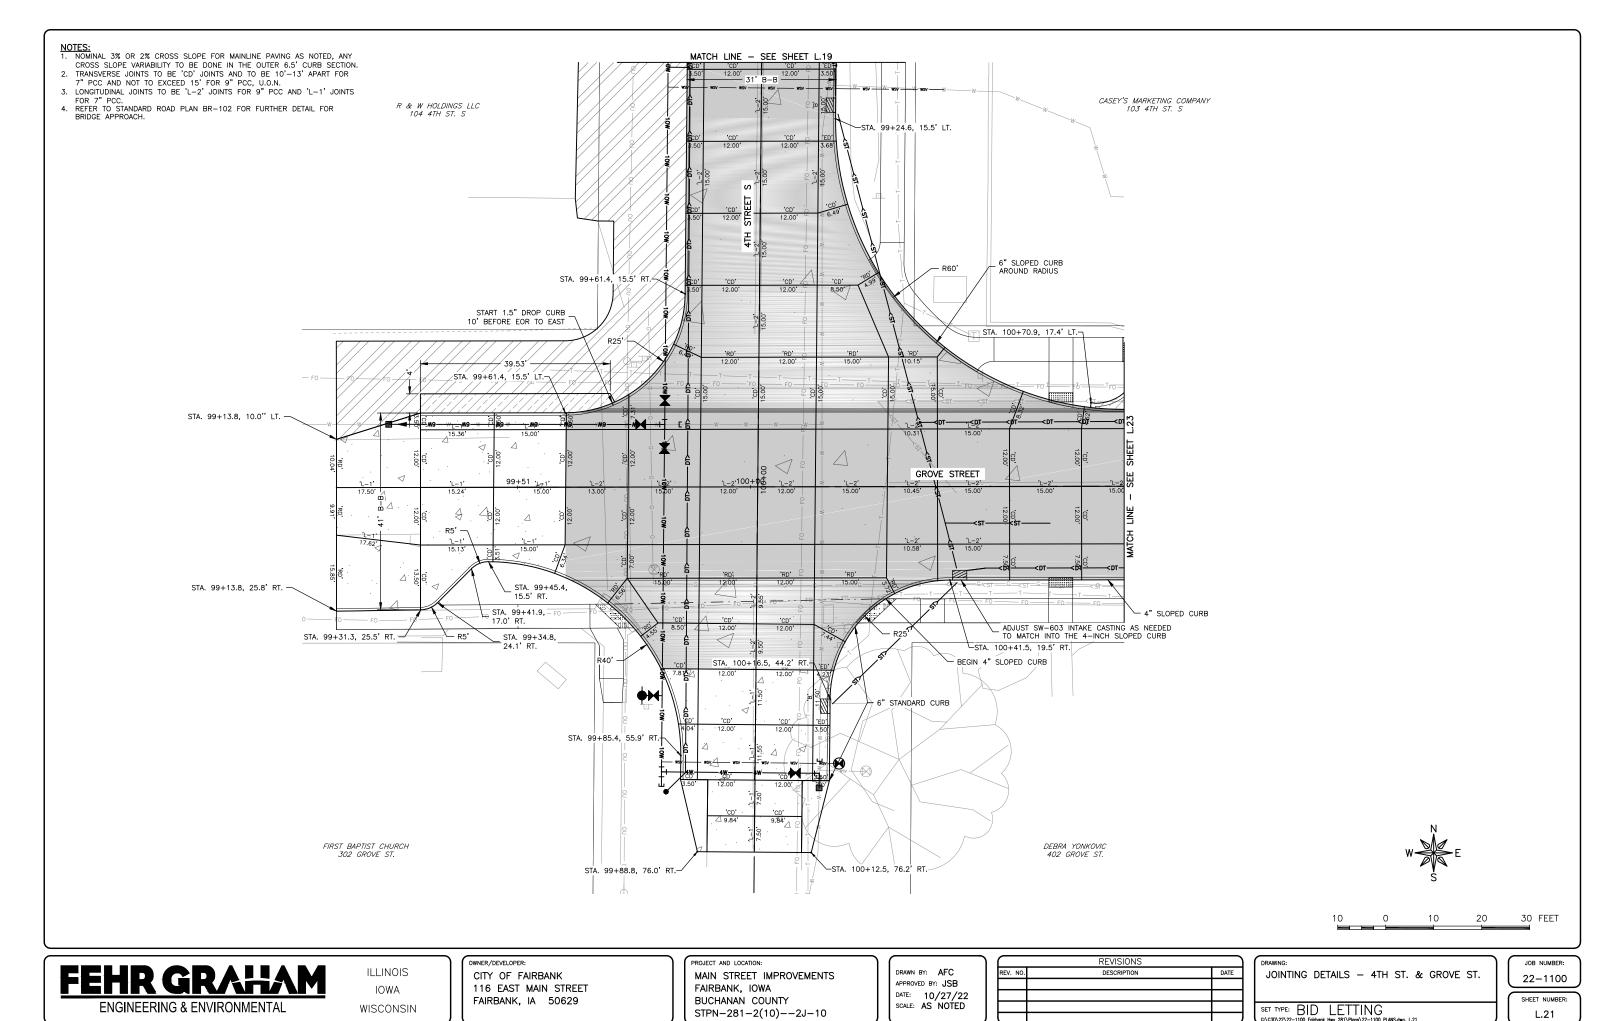

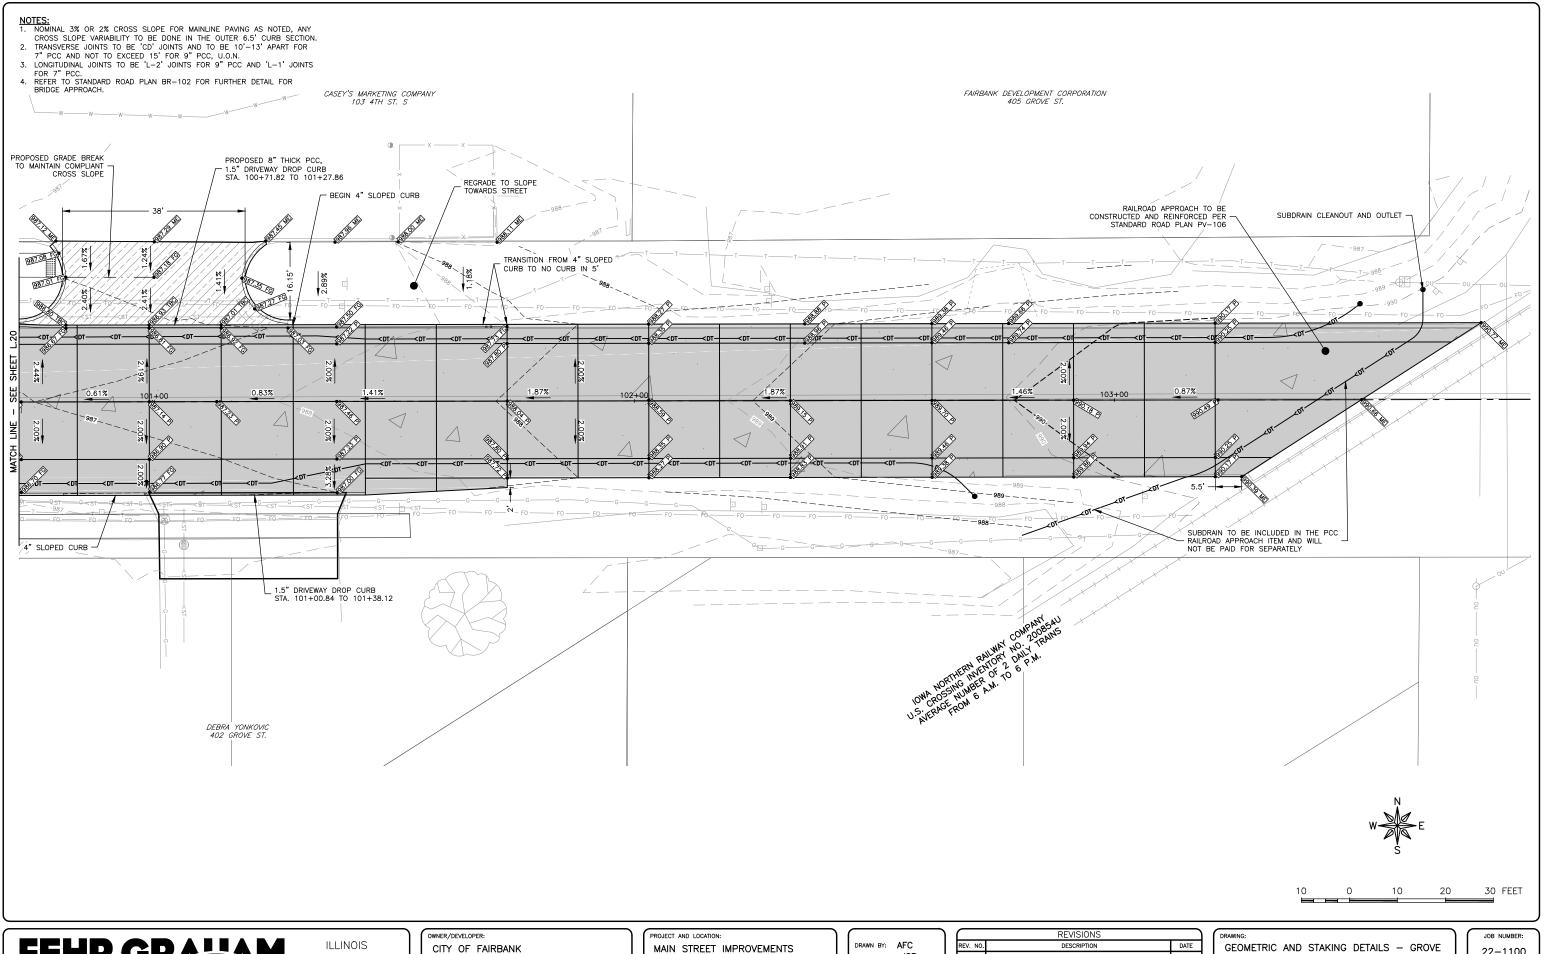



IOWA WISCONSIN

CITY OF FAIRBANK 116 EAST MAIN STREET FAIRBANK, IA 50629

FAIRBANK, IOWA BUCHANAN COUNTY STPN-281-2(10)--2J-10


DRAWN BY: AFC APPROVED BY: JSB DATE: 10/27/22 SCALE: AS NOTED

	REVISIONS		
REV. NO.	DESCRIPTION	DATE	
)

GEOMETRIC AND STAKING DETAILS — GROVE ST.

SET TYPE: BID LETTING

22-1100 SHEET NUMBER:

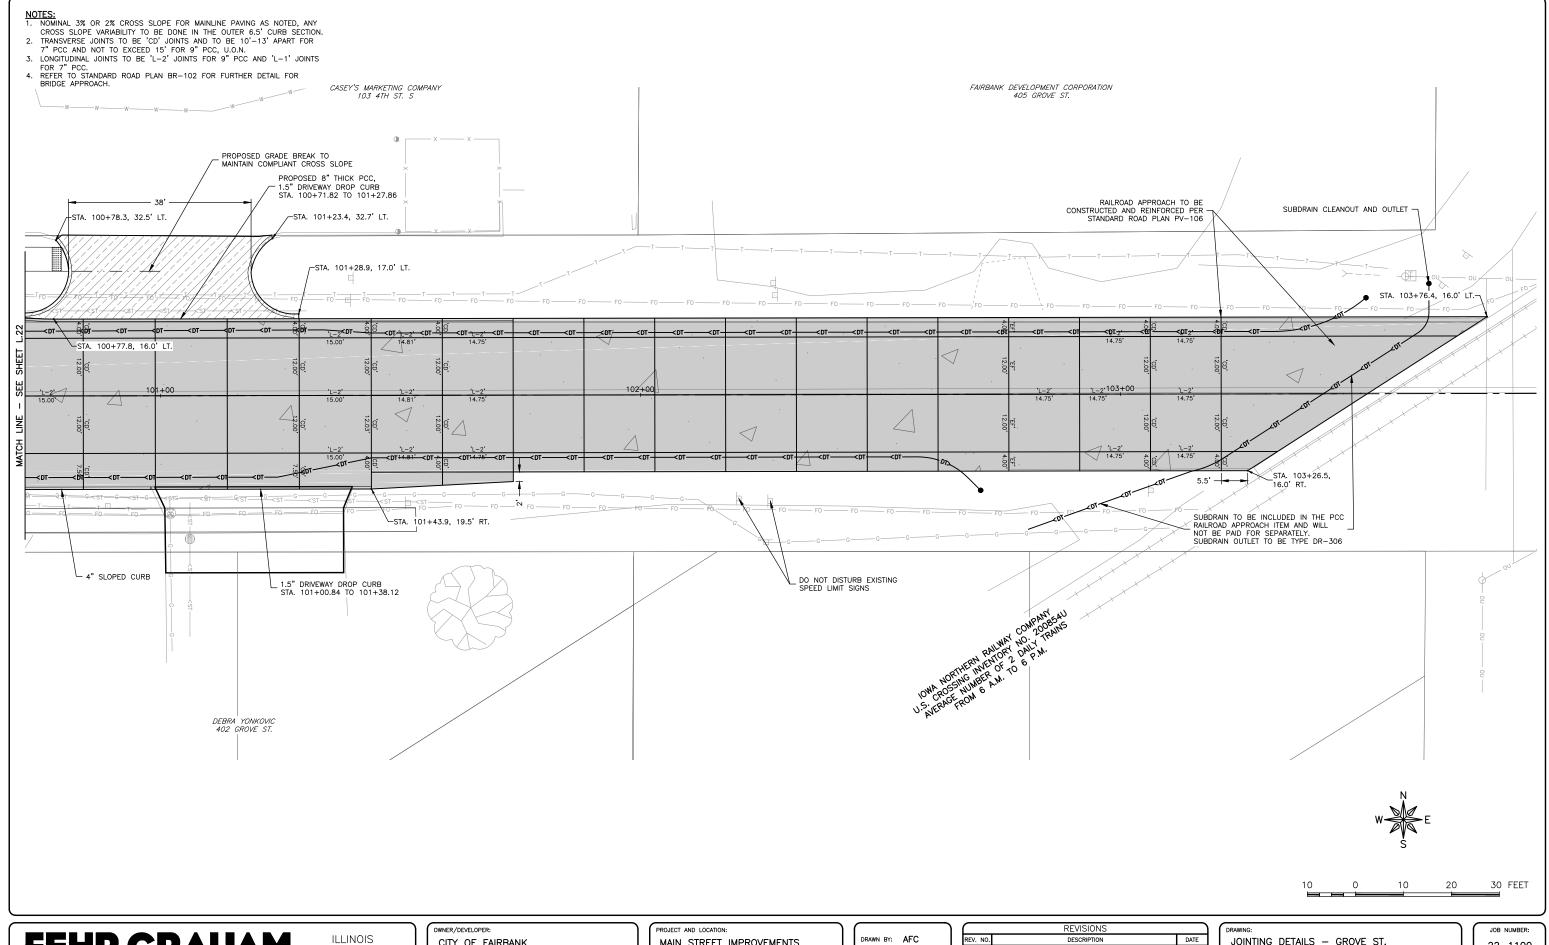

ILLINOIS IOWA WISCONSIN CITY OF FAIRBANK 116 EAST MAIN STREET FAIRBANK, IA 50629 MAIN STREET IMPROVEMENTS
FAIRBANK, IOWA
BUCHANAN COUNTY
STPN-281-2(10)--2J-10


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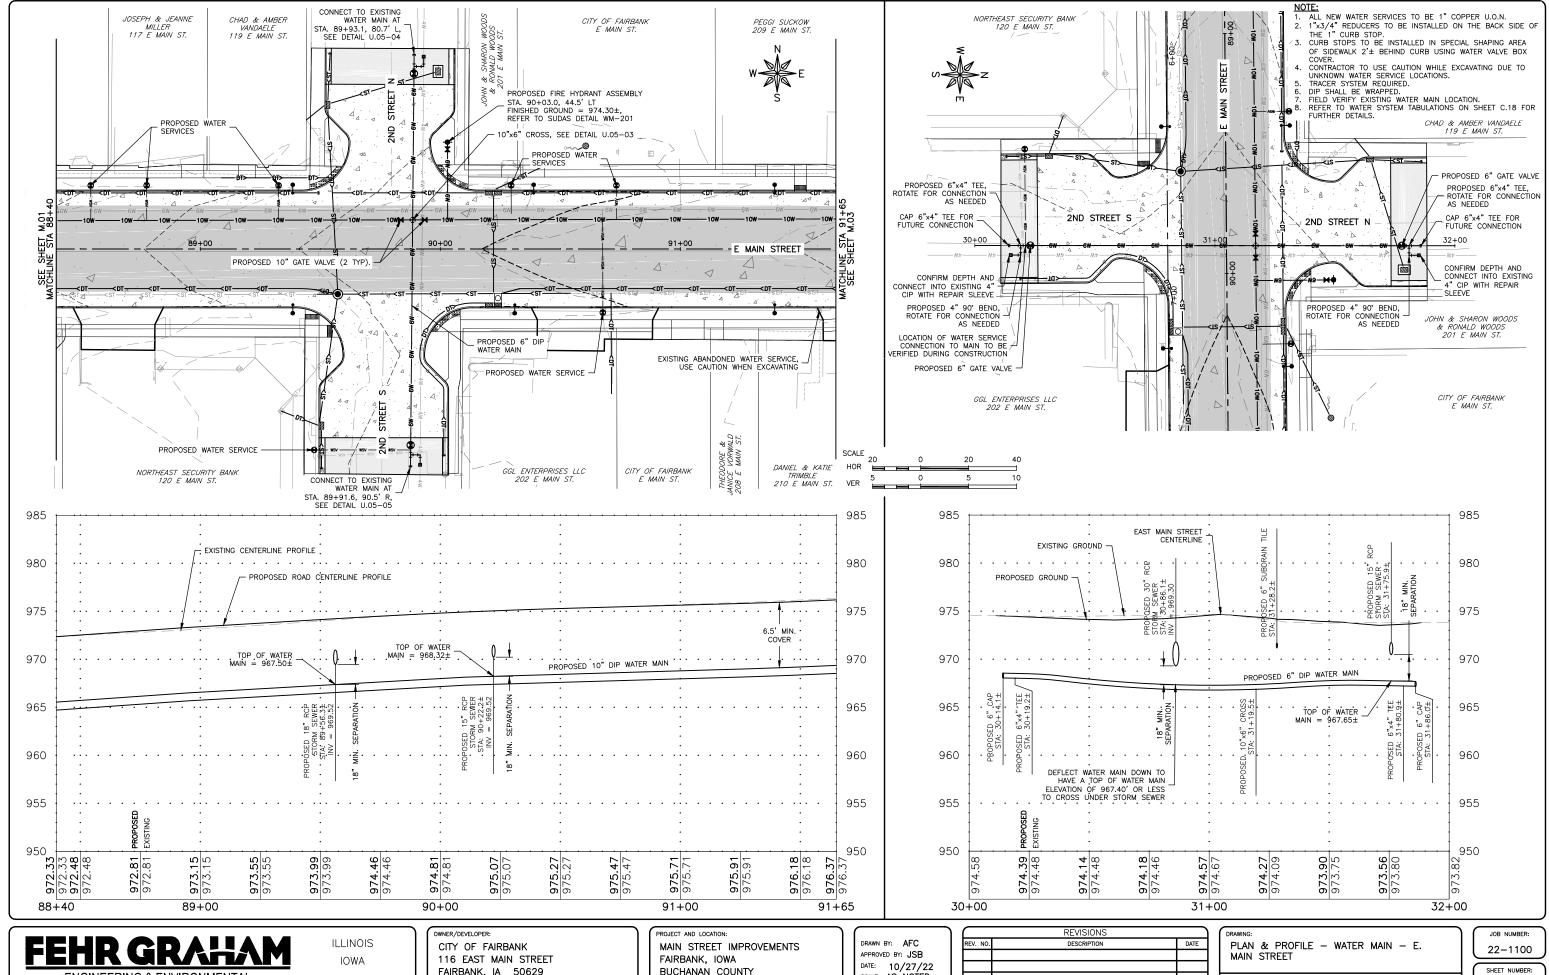
REVISIONS		
REV. NO.	DESCRIPTION	DATE

DRAWING:
JOINTING DETAILS — GROVE ST.

SET TYPE: BID LETTING

JOB NUMBER:
22-1100
SHEET NUMBER:



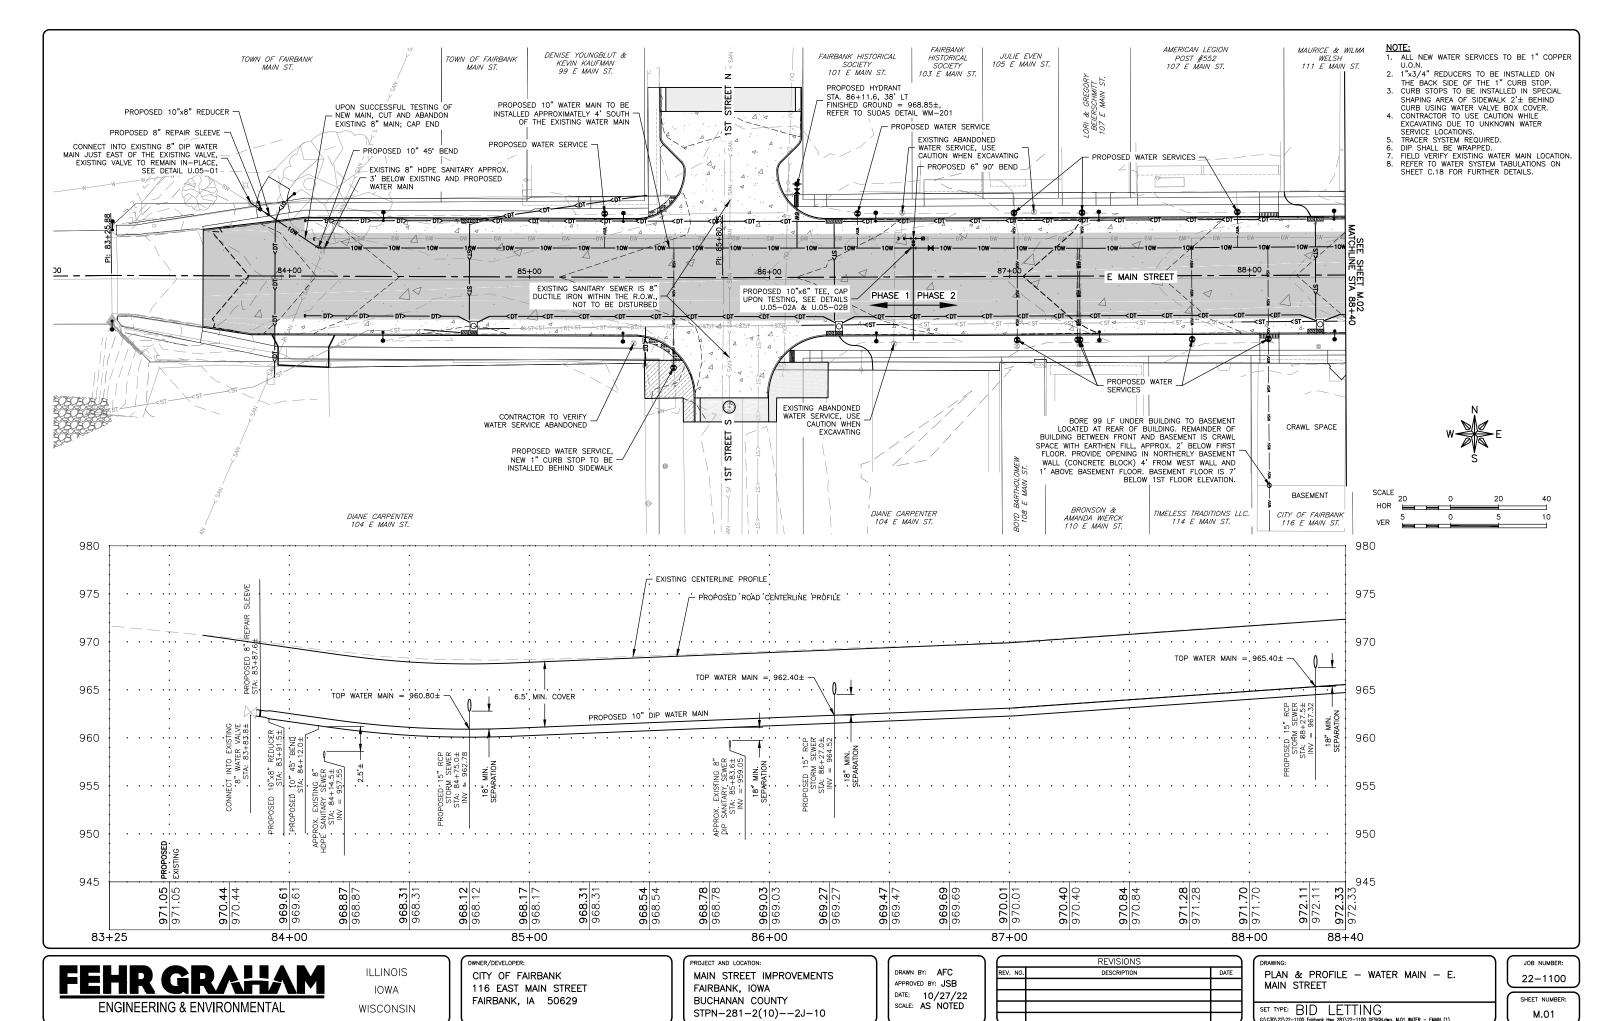

WISCONSIN


FAIRBANK, IA 50629

BUCHANAN COUNTY STPN-281-2(10)--2J-10 DATE: 10/27/22 SCALE: AS NOTED

REVISIONS		
REV. NO.	DESCRIPTION	DATE

M.02

SET TYPE: BID LETTING

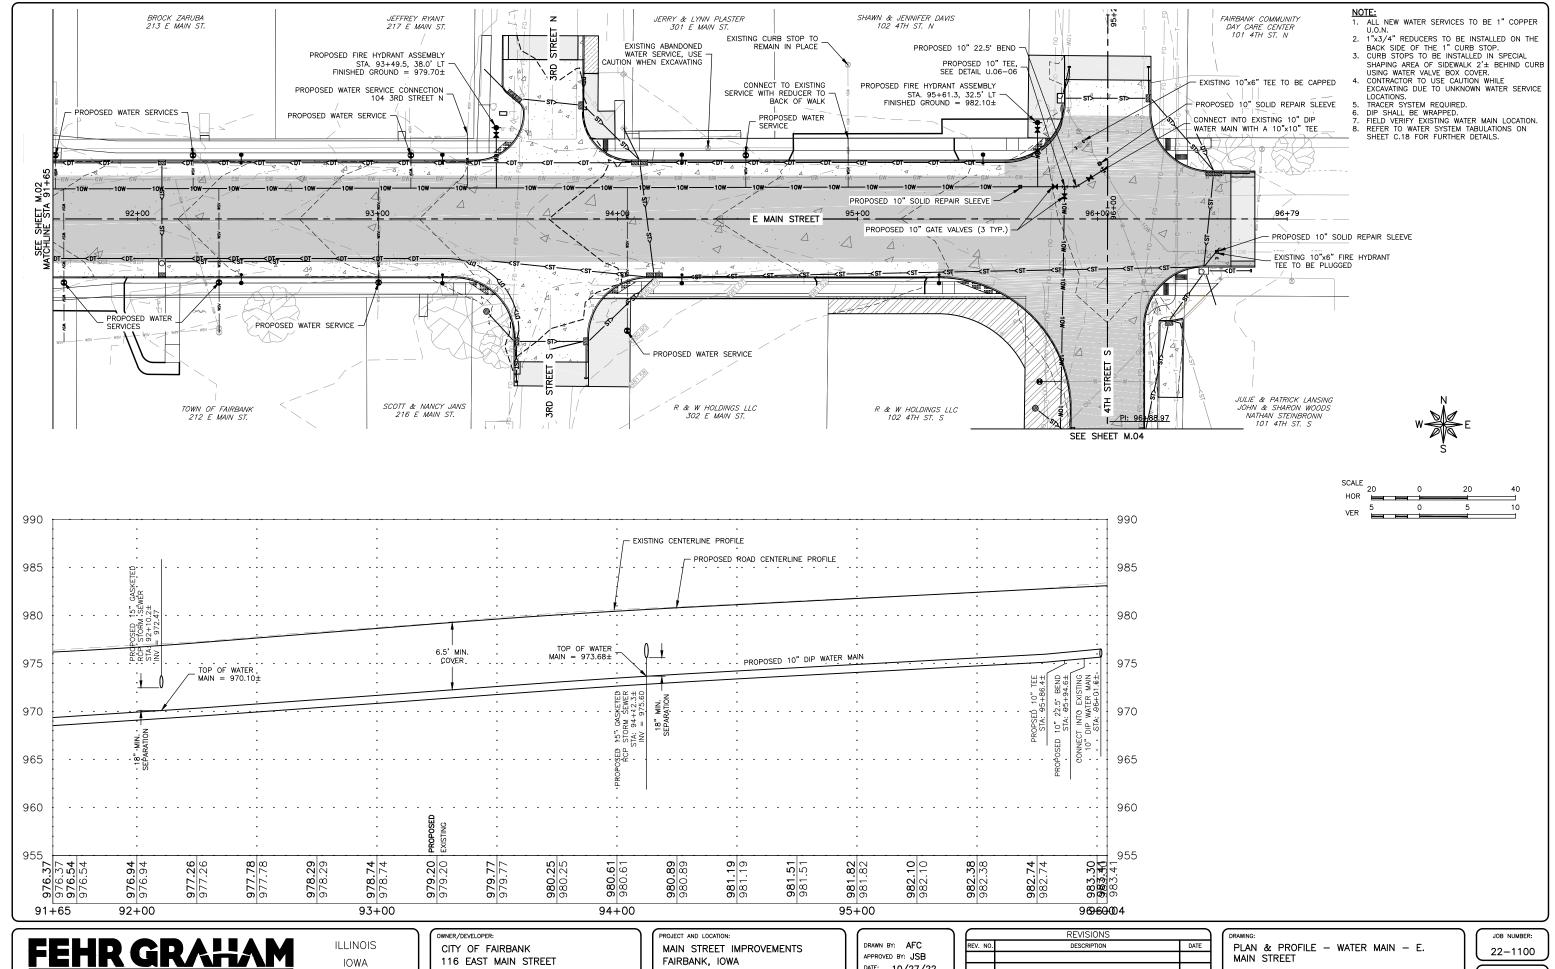

PLOT DATE: 10/31/22 © 2022 FEHR GRAHAM

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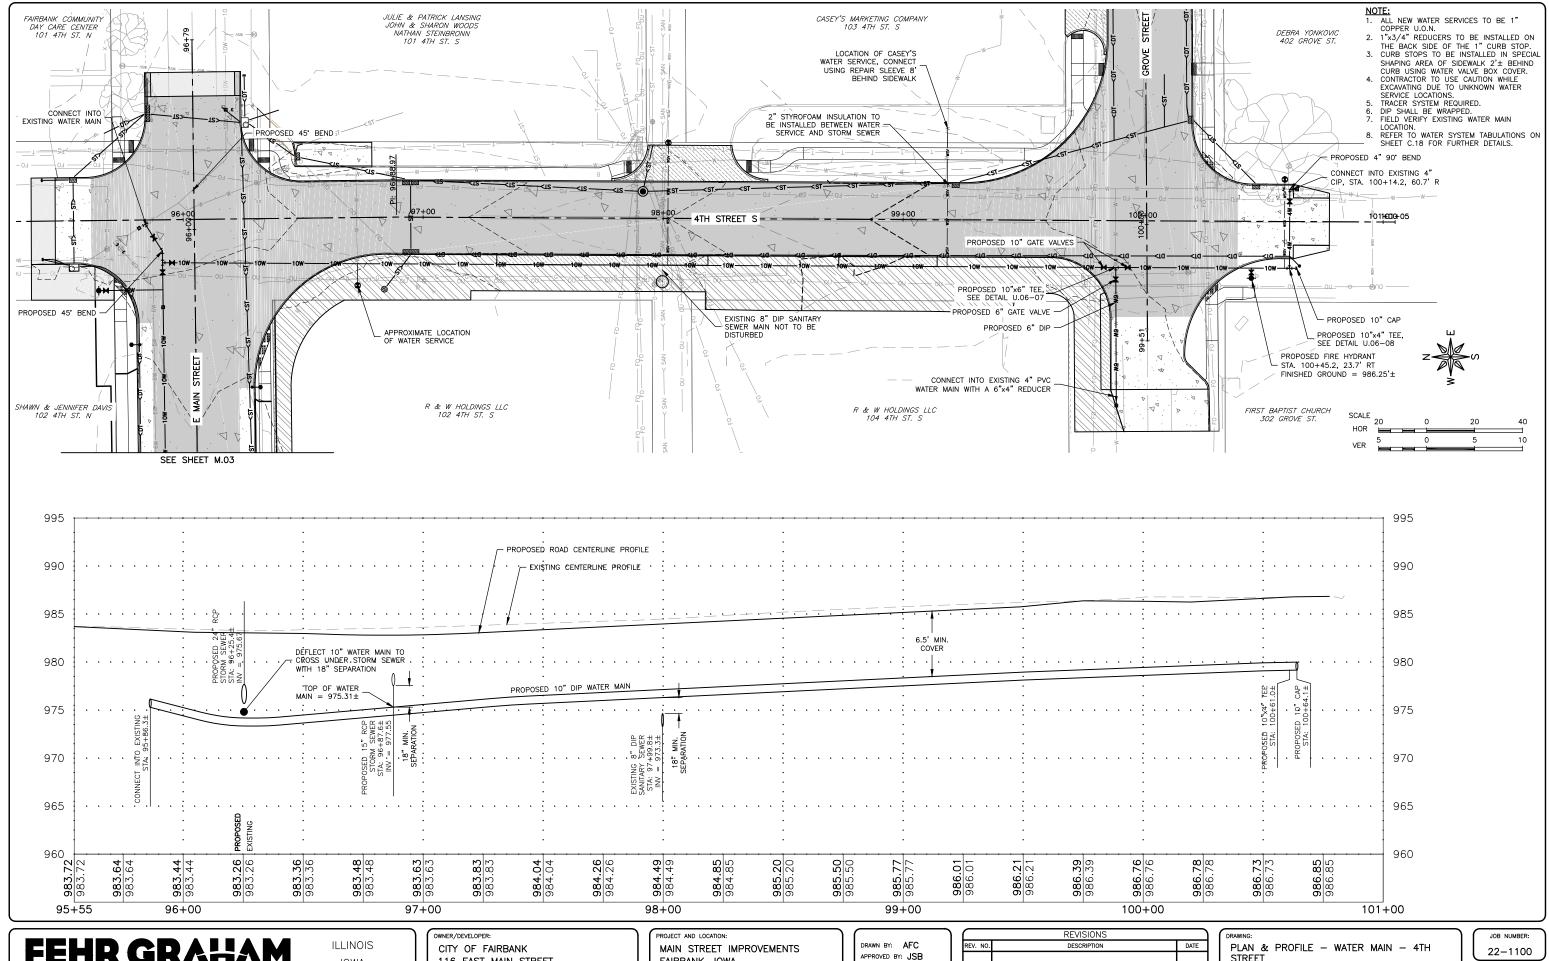
FAIRBANK, IA 50629

WISCONSIN

BUCHANAN COUNTY STPN-281-2(10)--2J-10 DATE: 10/27/22 SCALE: AS NOTED

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EV. NO.	DESCRIPTION	DATE

SET TYPE: BID LETTING



IOWA WISCONSIN 116 EAST MAIN STREET FAIRBANK, IA 50629

FAIRBANK, IOWA BUCHANAN COUNTY STPN-281-2(10)--2J-10

APPROVED BY: JSB DATE: 10/27/22 SCALE: AS NOTED


	REVISIONS	
REV. NO.	DESCRIPTION	DATE

STREET

SET TYPE: BID LETTING

SHEET NUMBER:

M.04

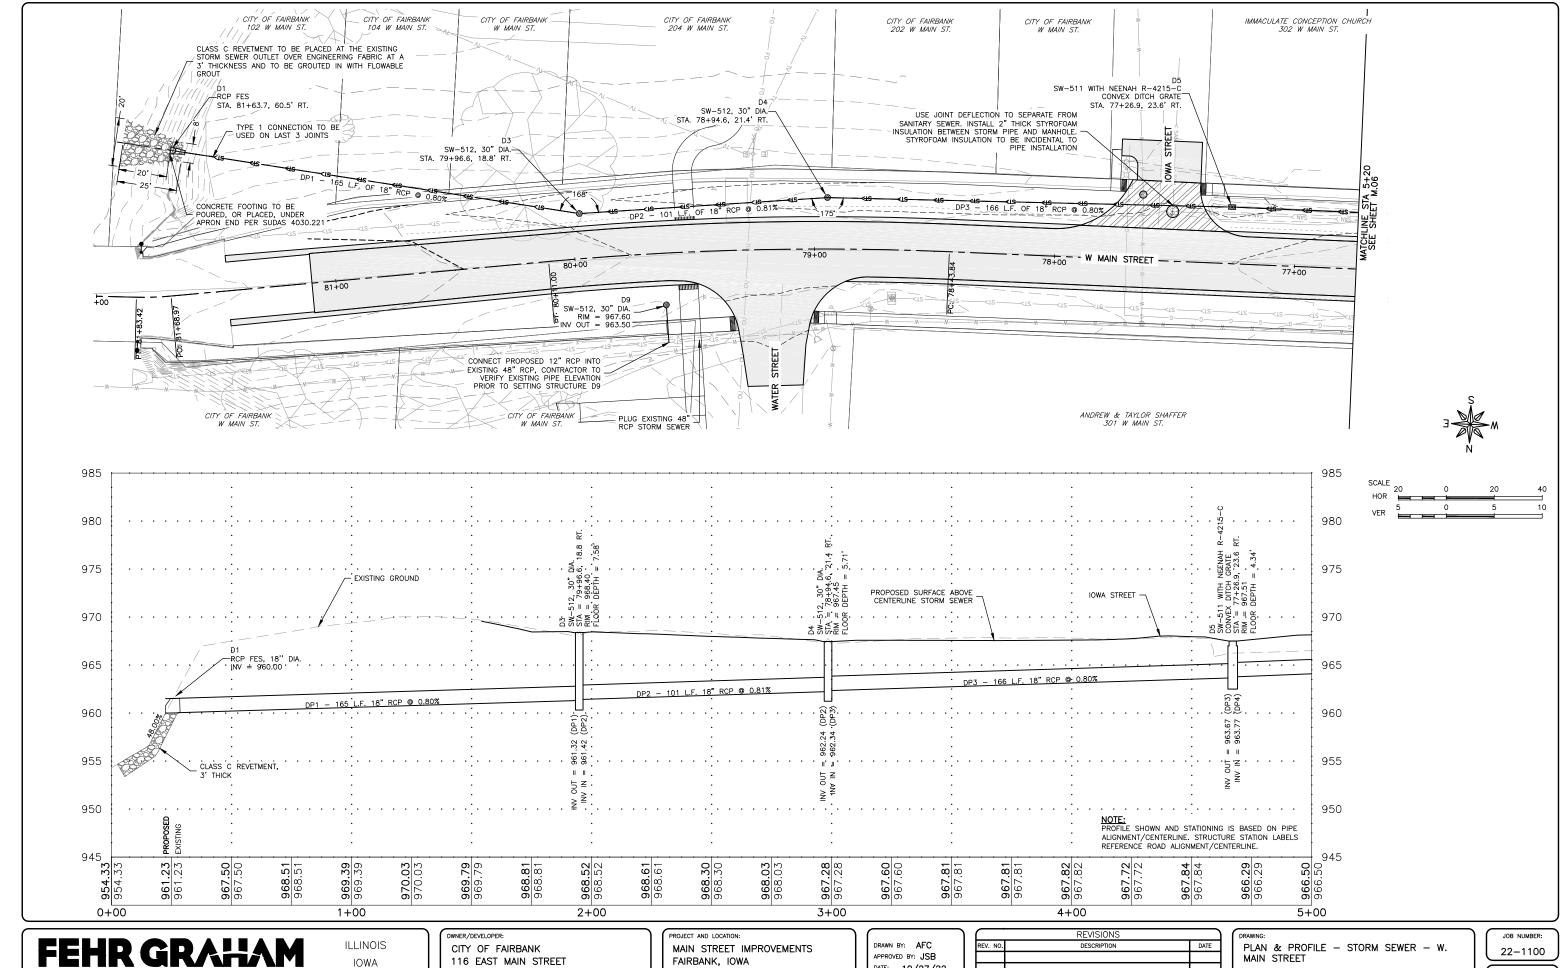


IOWA WISCONSIN 116 EAST MAIN STREET FAIRBANK, IA 50629

FAIRBANK, IOWA BUCHANAN COUNTY STPN-281-2(10)--2J-10 DATE: 10/27/22 SCALE: AS NOTED

	REVISIONS	
REV. NO.	DESCRIPTION	DATE
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SET TYPE: BID LETTING

SHEET NUMBER M.05

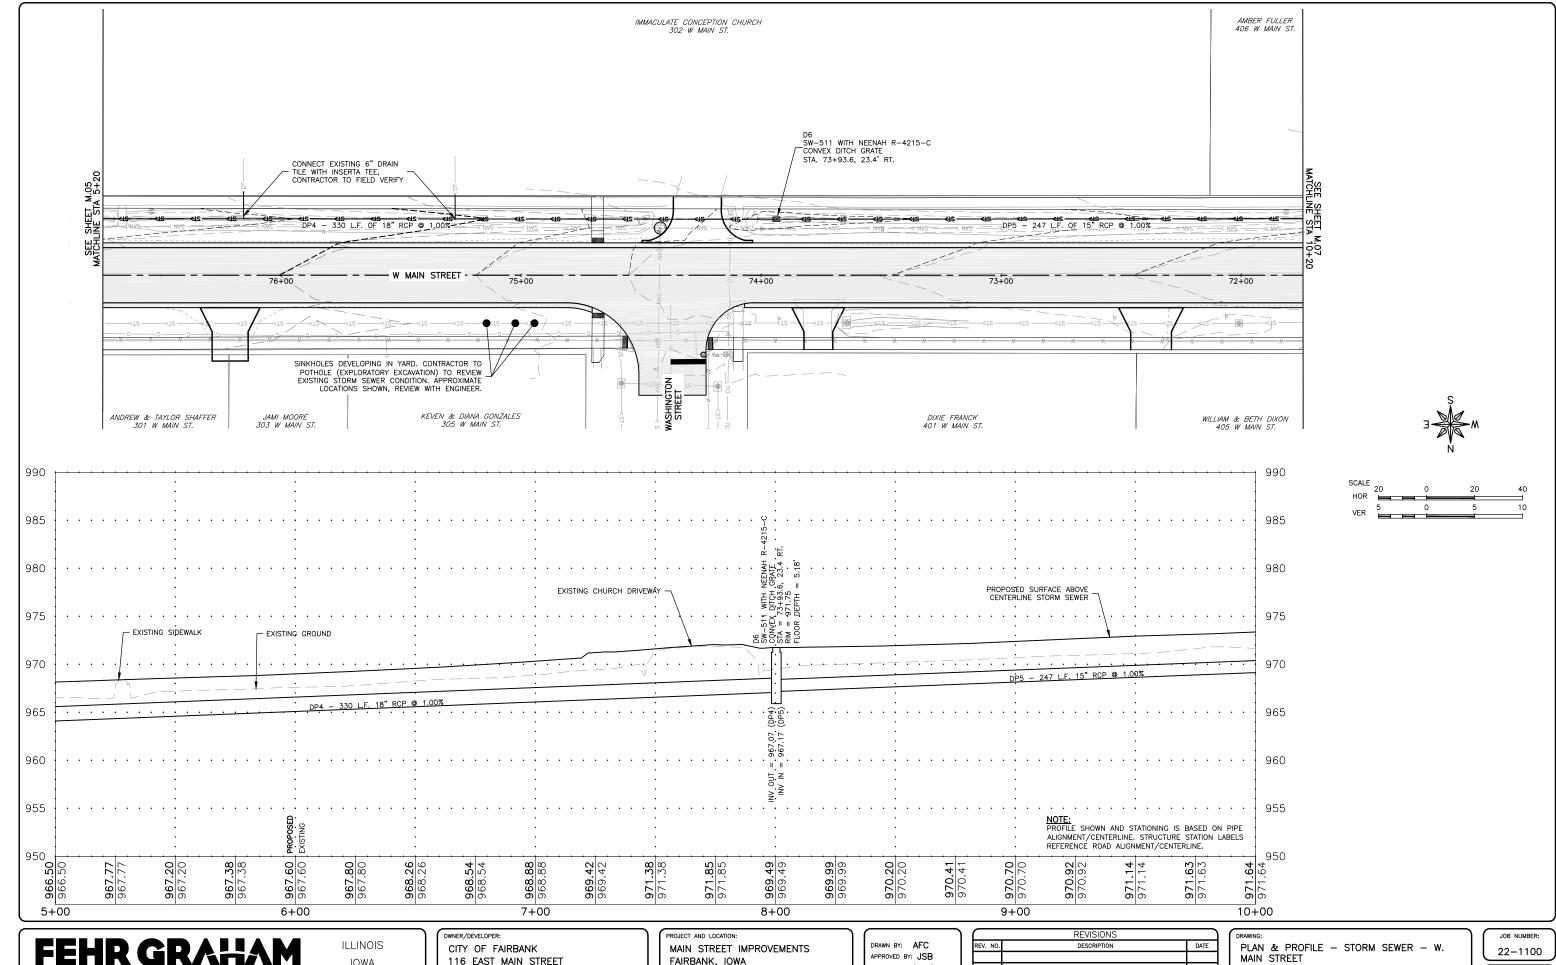



IOWA WISCONSIN 116 EAST MAIN STREET FAIRBANK, IA 50629

FAIRBANK, IOWA BUCHANAN COUNTY STPN-281-2(10)--2J-10 DATE: 10/27/22 SCALE: AS NOTED


REVISIONS		
REV. NO.	DESCRIPTION	DATE

SET TYPE: BID LETTING M.06

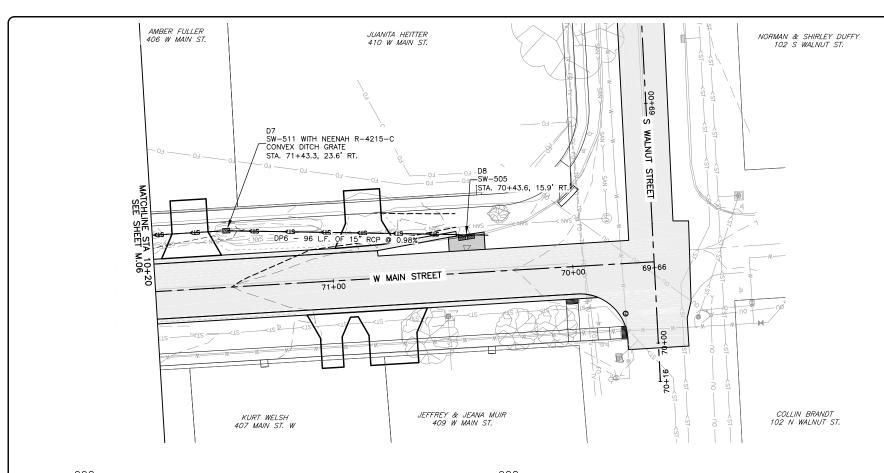

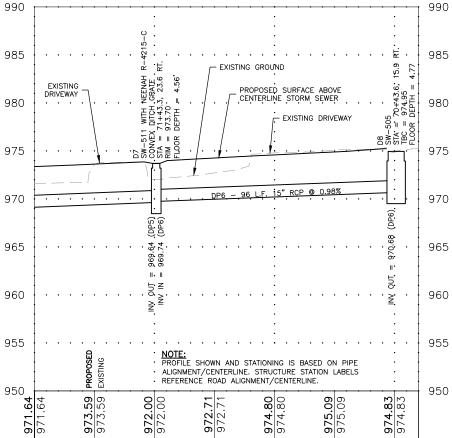



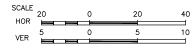

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ILLINOIS IOWA WISCONSIN

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11+00

CITY OF FAIRBANK 116 EAST MAIN STREET FAIRBANK, IA 50629

11+60

PROJECT AND LOCATION: MAIN STREET IMPROVEMENTS FAIRBANK, IOWA BUCHANAN COUNTY STPN-281-2(10)--2J-10

DRAWN BY: AFC APPROVED BY: JSB DATE: 10/27/22 SCALE: AS NOTED

	REVISIONS	
REV. NO.	DESCRIPTION	DATE


PLAN & PROFILE - STORM SEWER - W. MAIN STREET

SET TYPE: BID LETTING

JOB NUMBER: 22-1100 SHEET NUMBER:

M.07

10+00

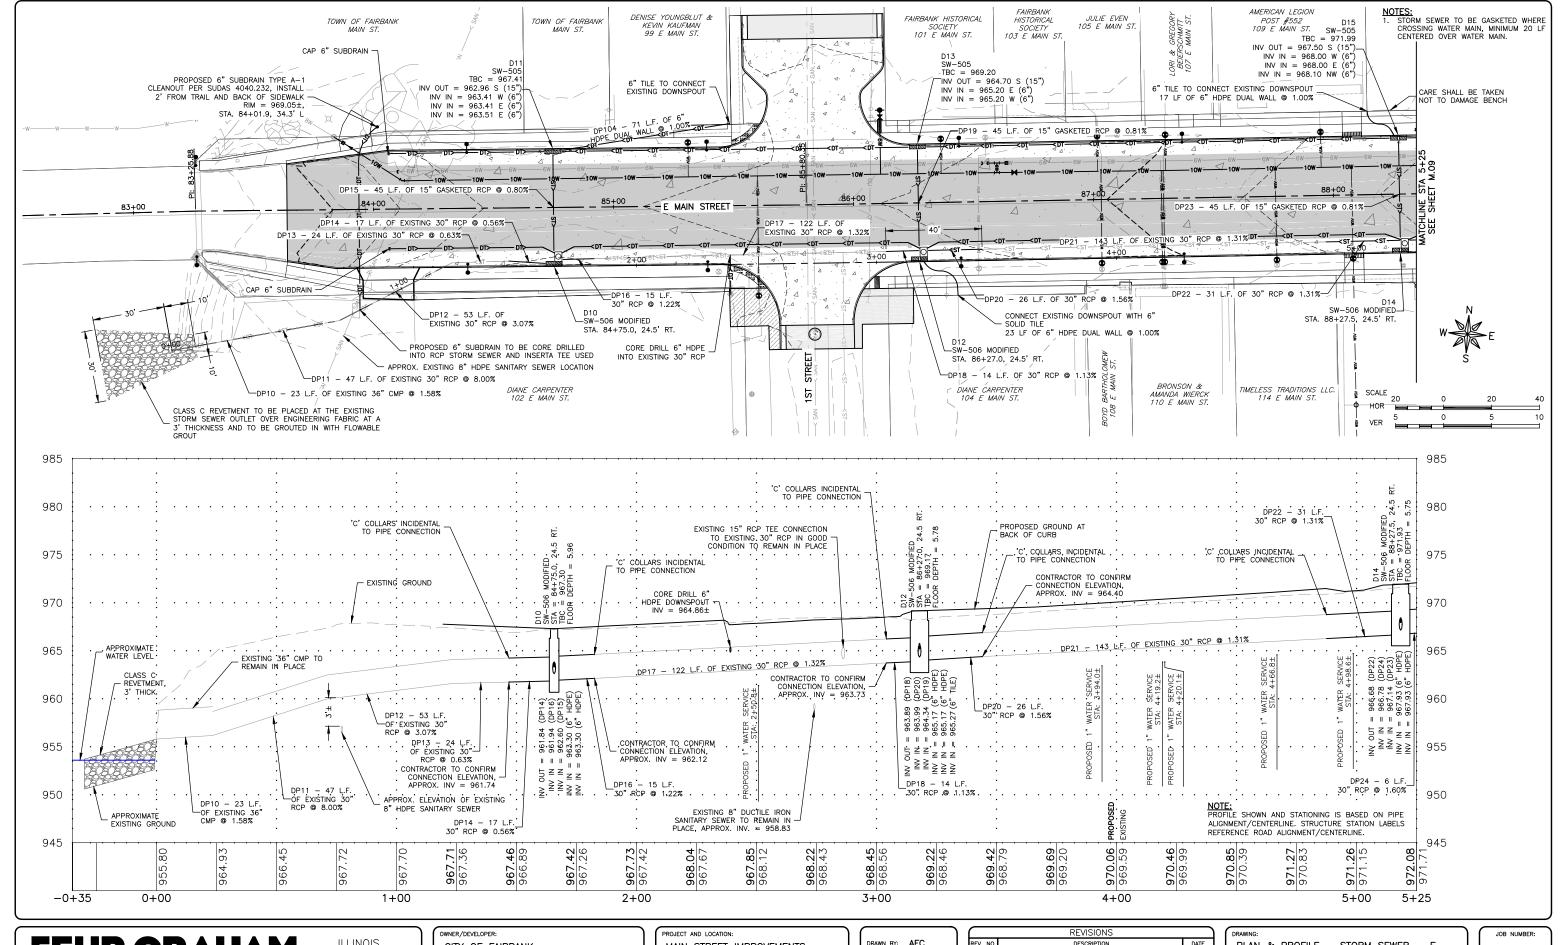

ILLINOIS IOWA WISCONSIN owner/developer:
CITY OF FAIRBANK
116 EAST MAIN STREET
FAIRBANK, IA 50629

MAIN STREET IMPROVEMENTS
FAIRBANK, IOWA
BUCHANAN COUNTY
STPN-281-2(10)--2J-10

DRAWN BY: AFC
APPROVED BY: JSB
DATE: 10/27/22
SCALE: AS NOTED

	REVISIONS	
REV. NO.	DESCRIPTION	DATE

DRAWING: PLAN & PROFILE — STORM SEWER — E. MAIN STREET


SET TYPE: BID LETTING

JOB NUMBER: 22-1100

SHEET NUMBER:

80.M

PLOT DATE: 10/31/22 © 2022 FEHR GRAHAM

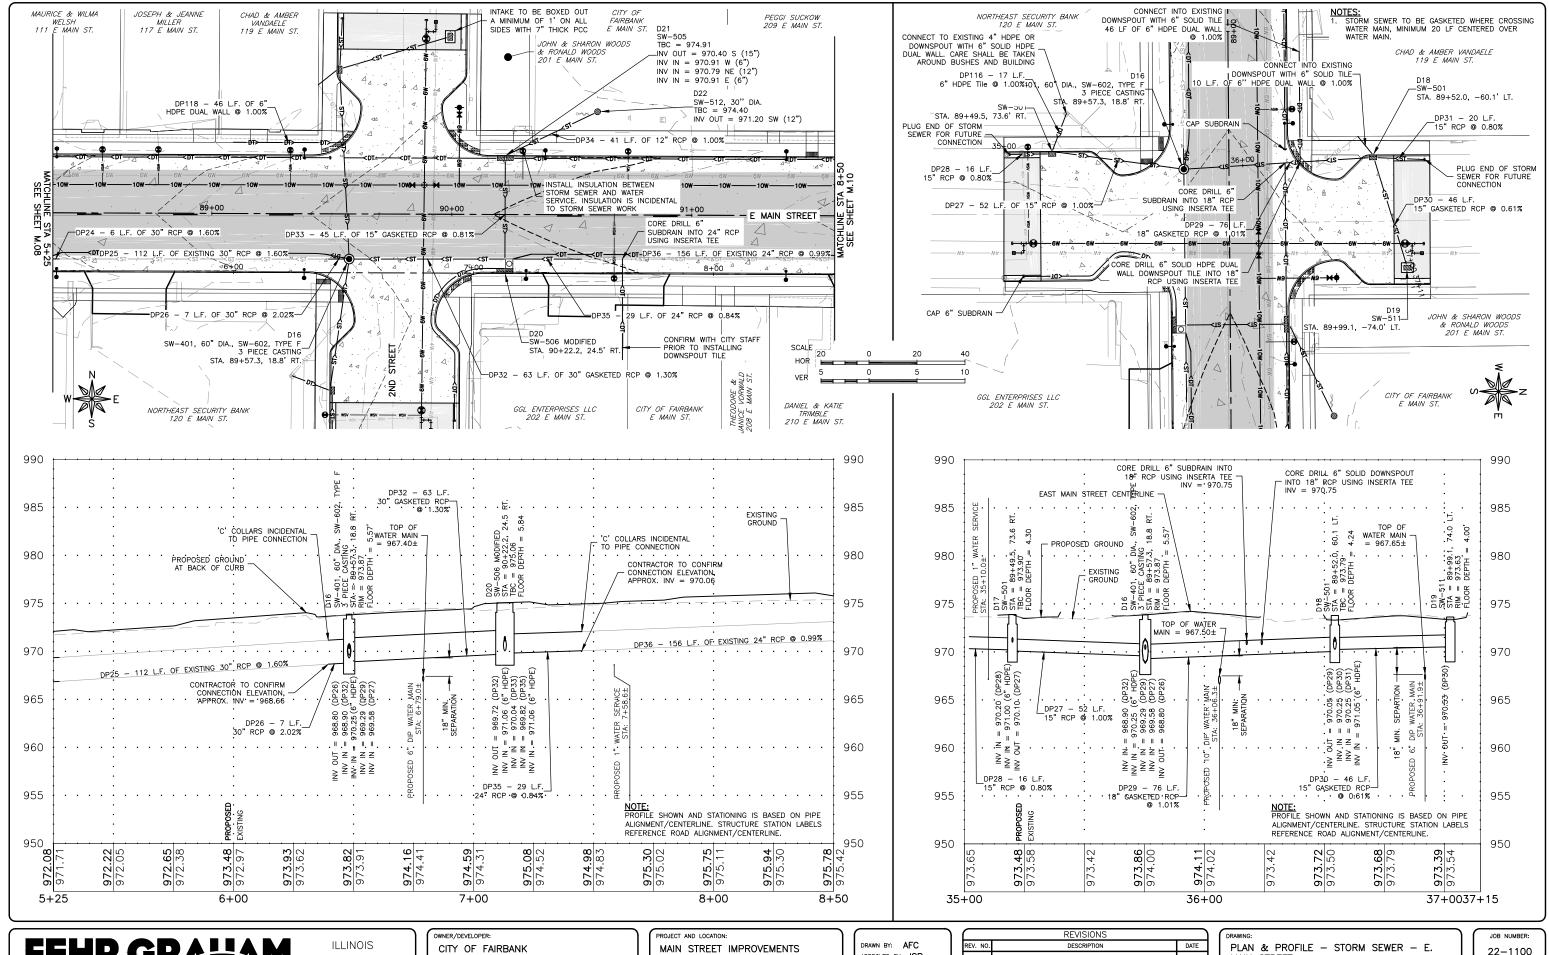

ILLINOIS IOWA WISCONSIN CITY OF FAIRBANK 116 EAST MAIN STREET FAIRBANK, IA 50629 MAIN STREET IMPROVEMENTS
FAIRBANK, IOWA
BUCHANAN COUNTY
STPN-281-2(10)--2J-10

DRAWN BY: AFC
APPROVED BY: JSB
DATE: 10/27/22
SCALE: AS NOTED

	REVISIONS	
REV. NO.	DESCRIPTION	DATE


DRAWING:
PLAN & PROFILE - STORM SEWER - E.
MAIN STREET

SET TYPE: BID LETTING

JOB NUMBER:
22-1100

SHEET NUMBER:

M.09

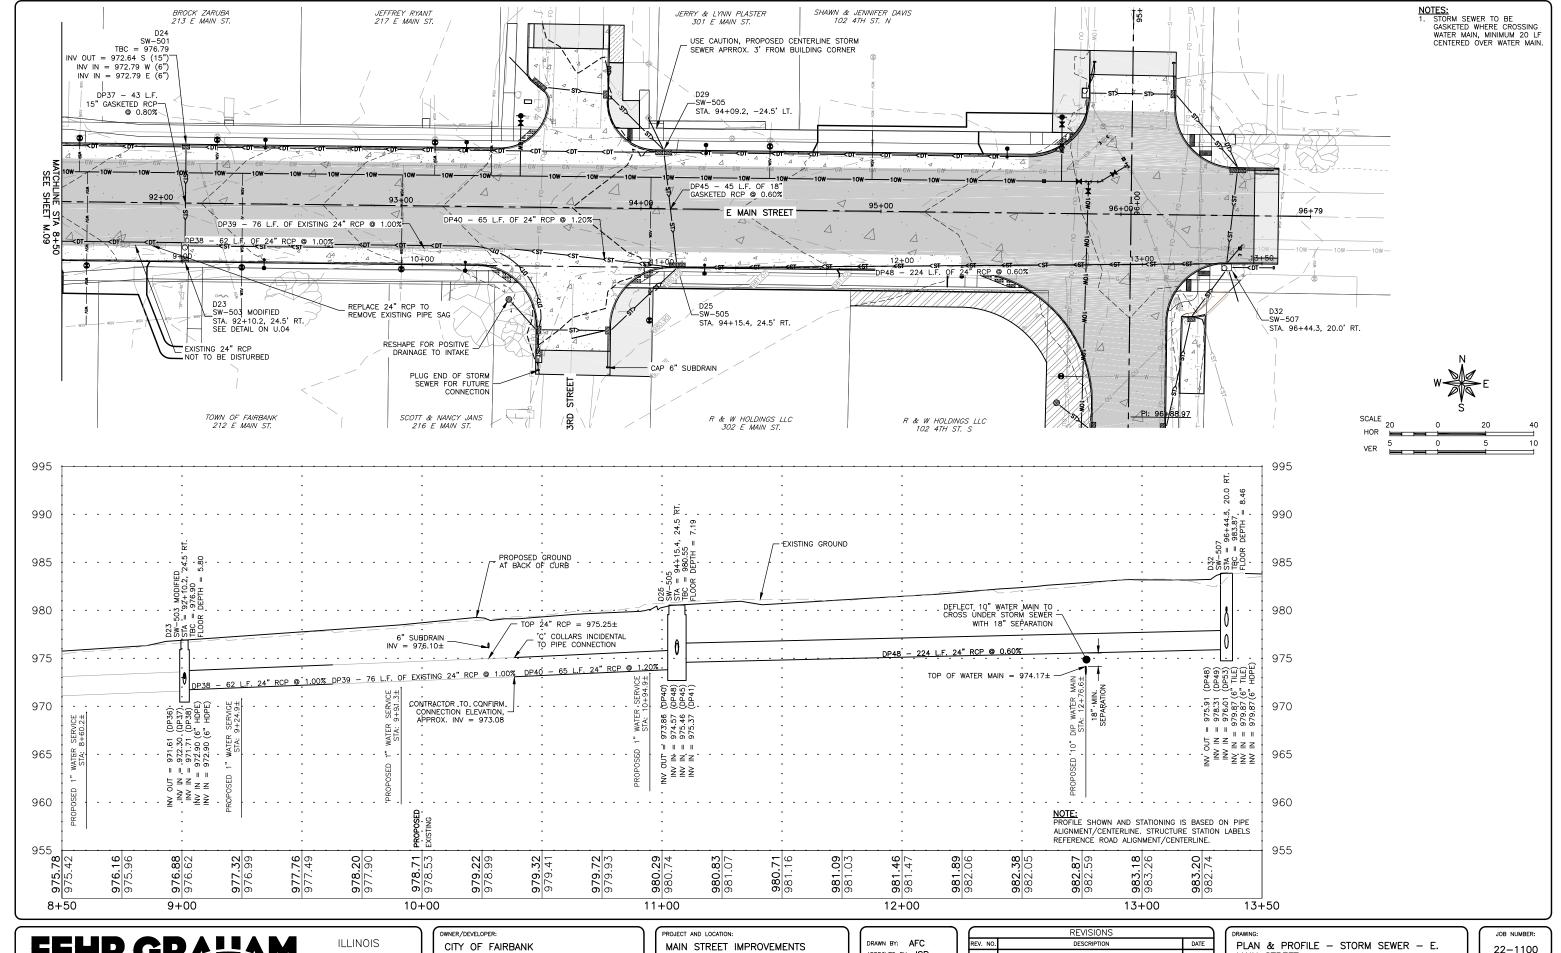

IOWA WISCONSIN 116 EAST MAIN STREET FAIRBANK, IA 50629

FAIRBANK, IOWA BUCHANAN COUNTY STPN-281-2(10)--2J-10

APPROVED BY: JSB DATE: 10/27/22 SCALE: AS NOTED


	REVISIONS	
REV. NO.	DESCRIPTION	DATE

MAIN STREET

SET TYPE: BID LETTING

22-1100 SHEET NUMBER:

M.10

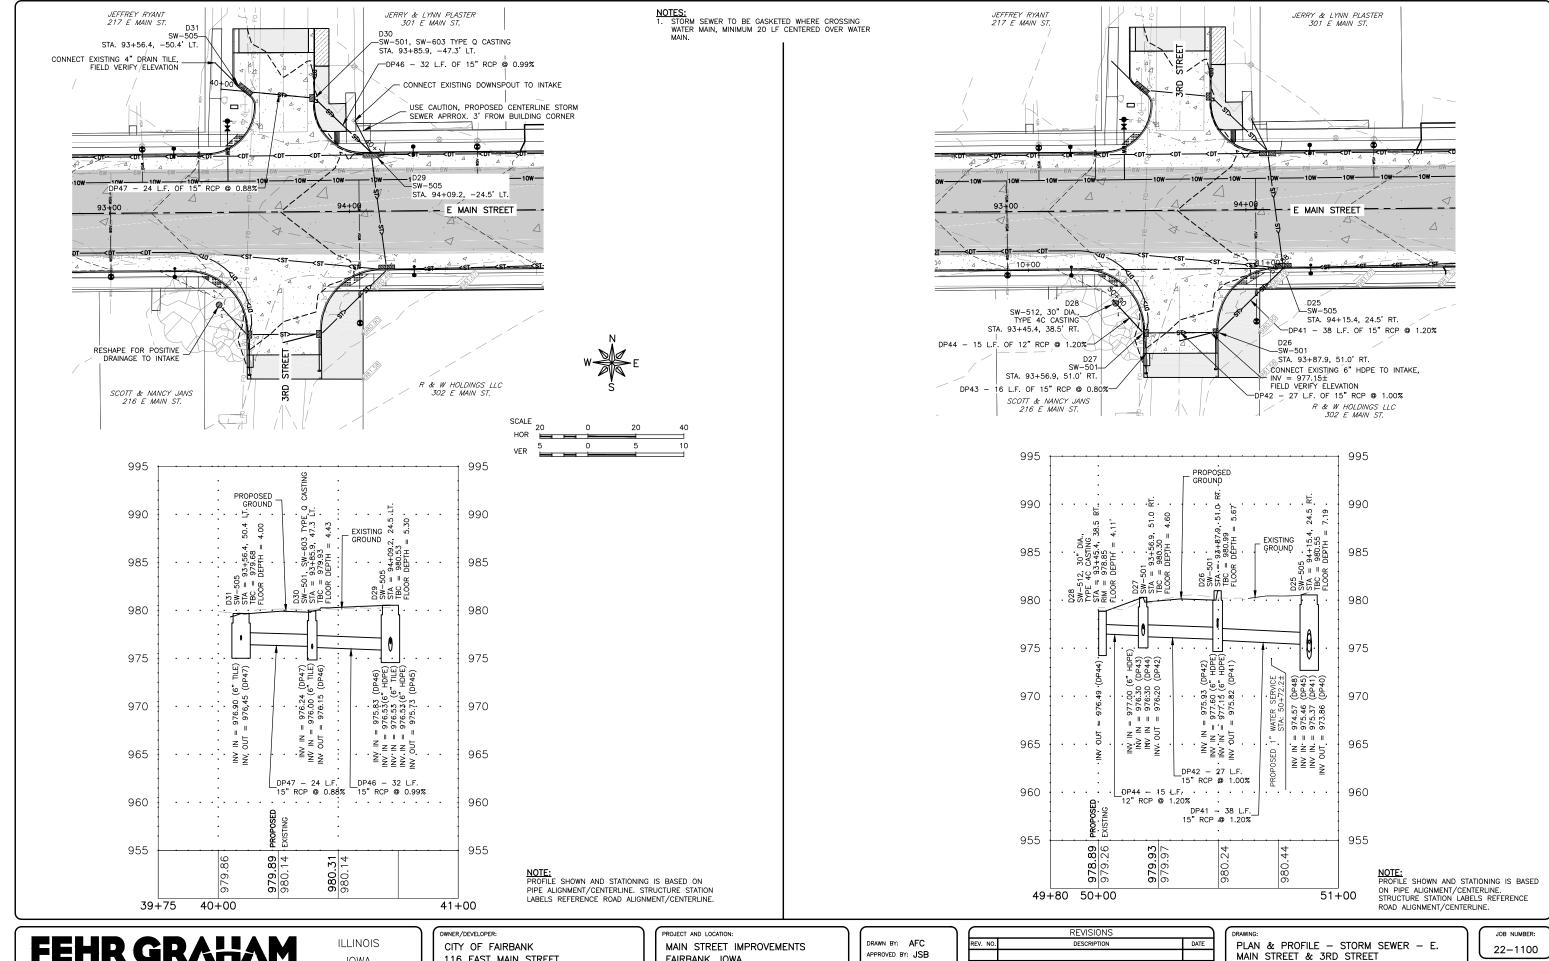

IOWA WISCONSIN

116 EAST MAIN STREET FAIRBANK, IA 50629

FAIRBANK, IOWA BUCHANAN COUNTY


STPN-281-2(10)--2J-10

DATE: 10/27/22 SCALE: AS NOTED

	REVISIONS	
REV. NO.	DESCRIPTION	DATE

SET TYPE: BID LETTING

SHEET NUMBER:

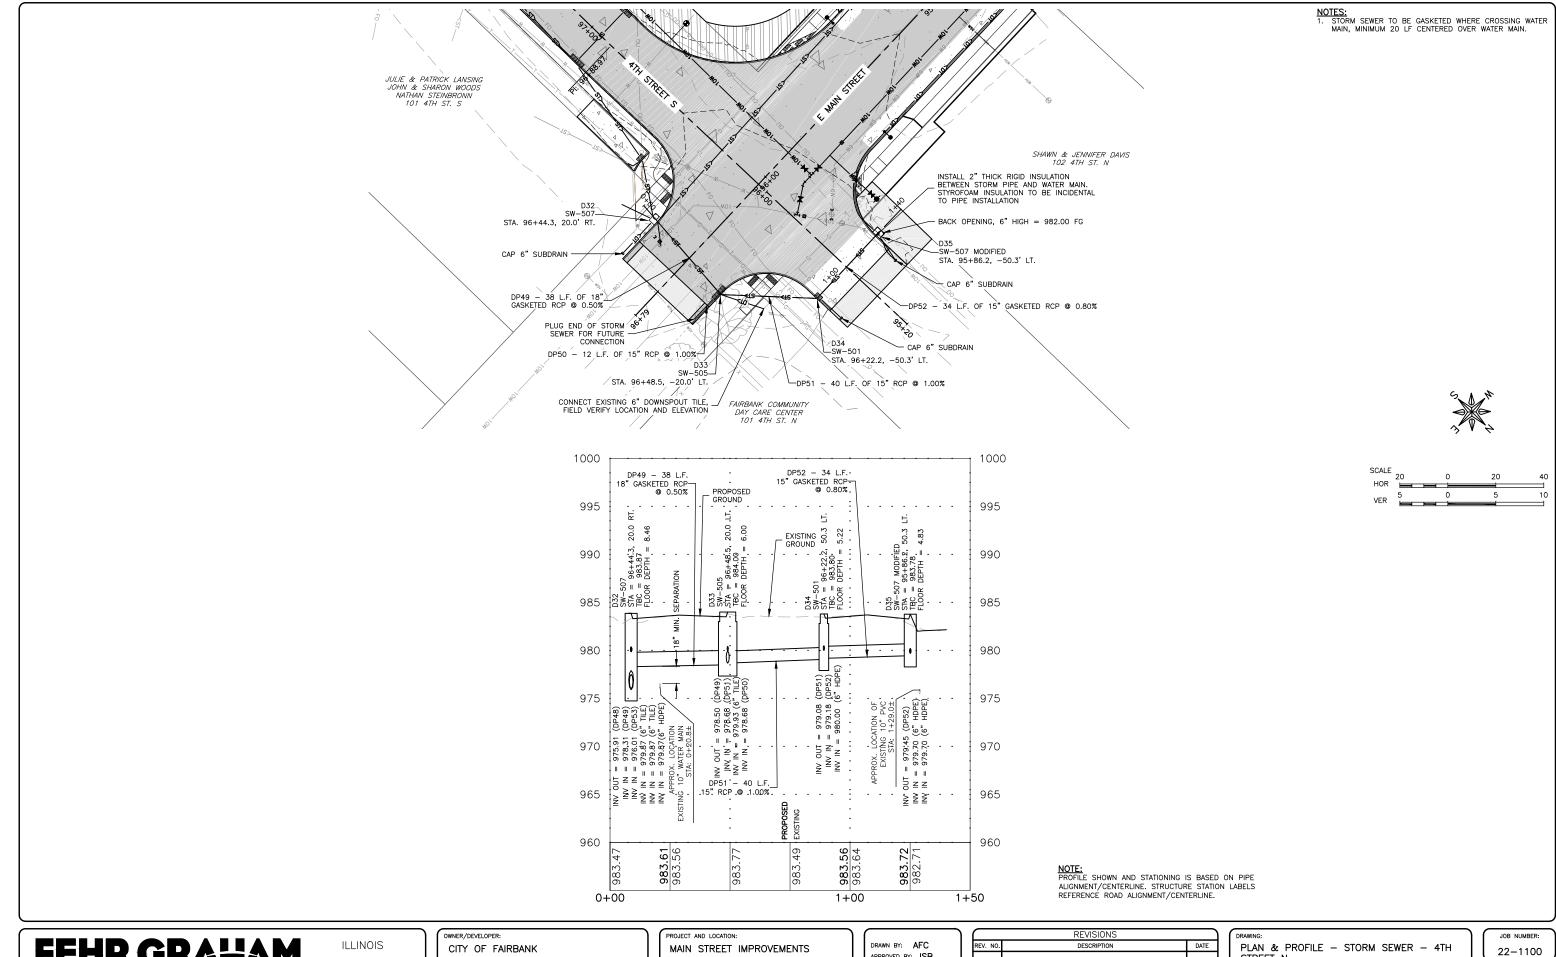

PLOT DATE: 10/31/22 © 2022 FEHR GRAHAM

ENGINEERING & ENVIRONMENTAL

IOWA WISCONSIN 116 EAST MAIN STREET FAIRBANK, IA 50629

FAIRBANK, IOWA BUCHANAN COUNTY STPN-281-2(10)--2J-10

APPROVED BY: JSB DATE: 10/27/22 SCALE: AS NOTED


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REV. NO.	DESCRIPTION	DATE
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STREET N

SET TYPE: BID LETTING

SHEET NUMBER:

M.12

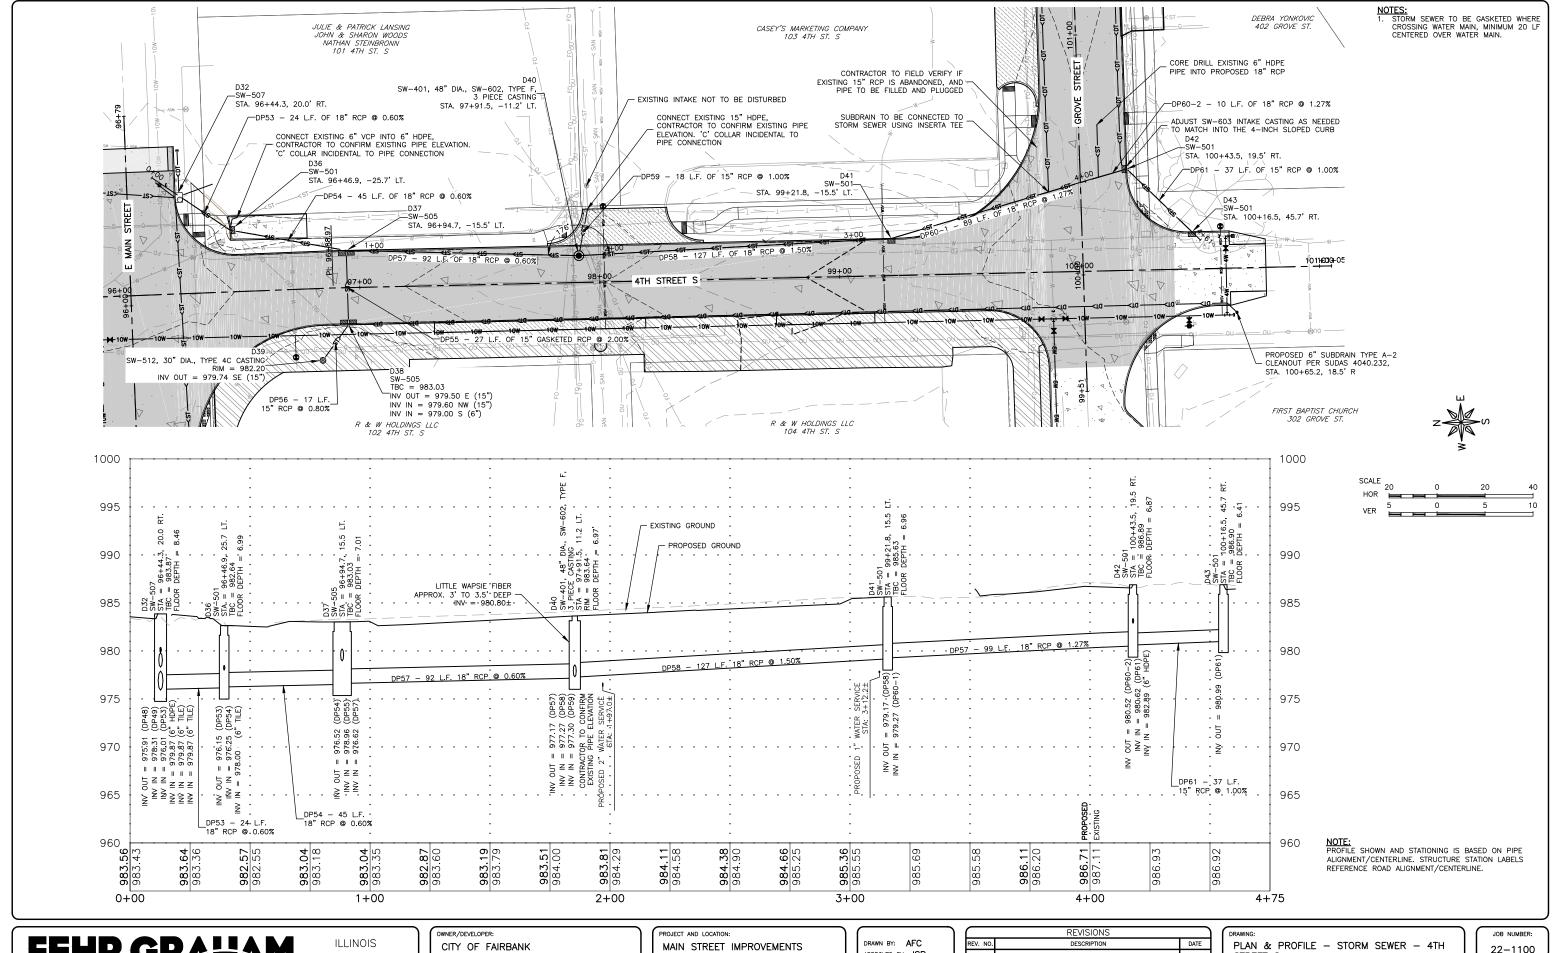

IOWA

WISCONSIN

116 EAST MAIN STREET FAIRBANK, IA 50629

FAIRBANK, IOWA BUCHANAN COUNTY STPN-281-2(10)--2J-10

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REV. NO.	DESCRIPTION	DATE

STREET S

SET TYPE: BID LETTING

22-1100 SHEET NUMBER

M.13

CODE NOTES - ELECTRICAL

- A. PROVIDE ELECTRICAL INSTALLATION IN ACCORDANCE WITH ALL LOCAL, STATE, AND NATIONAL CODES.
- B. THE CURRENT ADOPTED EDITION OF THE ELECTRICAL CODE SHALL BE THE STANDARD FOR THE ELECTRICAL INSTALLATION. VERIFY WITH LOCAL OFFICIALS WHEN PERMITS ARE OBTAINED. NOTIFY DESIGN TEAM OF ANY DESCREPANCIES BETWEEN THE PROJECT MANUAL OR DRAWINGS AND THE GOVERNING CODE.
- C. INSTALLATION SHALL FOLLOW REQUIREMENTS OF THE ADAAG AMERICANS WITH DISABILITIES ACT.
- D. REFER TO PROJECT MANUAL AND PROJECT CODE REVIEW SHEET FOR LIST OF APPLICABLE CODES.
- E. PROJECT SHALL COMPLY WITH BUILD AMERICA, BUY AMERICA (BABA) REQUIREMENTS AS NOTED UNDER ADOPTED INFRASTRUCTURE INVESTMENT AND JOBS ACT (IIJA). THIS WILL INCLUDE ALL PROJECT ASPECTS THAT FALL UNDER ONE OF FOLLOWING CATEGORIES:
 - a. PRODUCTS OF IRON AND STEEL
 - b. MANUFACTURED PRODUCTS
 - c. CONSTRUCTION MATERIALS

SITE NOTES - ELECTRICAL

- A. UTILITIES SHOWN ON ELECTRICAL SITE PLAN ARE SCHEMATIC ONLY. VERIFY ALL SITE CONDITIONS AND DIMENSIONS ON SITE PRIOR TO COMPLETING BID AND ORDERING OF EQUIPMENT.
- REPAIR ALL AFFECTED SURFACES AND RESTORE TO EXISTING CONDITIONS AT COMPLETION OF PROJECT.
- C. WARNING CALL 48 HOURS BEFORE YOU DIG: IOWA LAW REQUIRES ANYONE DOING ANY EXCAVATION, FENCING, PLANTING OR DRILLING TO CALL 48 HOURS IN ADVANCE. HAND DIG WITHIN 18 INCHES OF ANY LOCATE MARK OR FLAG. IOWA ONE-CALL 1-800-292-8989.

INSTALLATION NOTES - ELECTRICAL

- A. RACEWAYS AND BOXES ARE SHOWN DIAGRAMMATICALLY ONLY AND INDICATE GENERAL AND APPROXIMATE LOCATIONS. LAYOUTS DO NOT ALWAYS SHOW THE TOTAL NUMBER OF RACEWAYS OR BOXES FOR THE CIRCUITS REQUIRED, NOR ARE THE LOCATIONS OF INDICATED RUNS INTENDED TO SHOW THE ACTUAL ROUTING OF THE RACEWAYS.
- B. LIGHT FIXTURES, SWITCHES, DEVICES, ETC. ARE SHOWN IN PREFERRED LOCATION. E.C. IS RESPONSIBLE FOR MODIFYING CONDUIT, HANGERS, CIRCUITING, ETC. TO PROVIDE A COMPLETE AND OPERATIONAL SYSTEM.
- C. PROVIDE A DEDICATED GREEN INSULATED GROUND CONDUCTOR TO ALL DEVICES. DO NOT UTILIZE CONDUIT SYSTEM AS THE ONLY EQUIPMENT GROUNDING METHOD.
- D. BALANCE PANEL LOADS DURING INSTALLATION. CIRCUIT NUMBERING SHOWN ON PLANS MAY BE ADJUSTED TO ACCOMODATE.
- E. PROVIDE TYPED PANEL DIRECTORY AT PROJECT COMPLETION FOR NEW PANELS AND EXISTING PANELS WITH CIRCUITS MODIFIED AS A RESULT OF THIS PROJECT. UTLIZE OWNER'S CURRENT ROOM NUMBERS AND EQUIPMENT NAMES AND RECEIVE APPROVAL PRIOR TO FINAL PLACEMENT.

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GENERAL NOTE:

UNDERGROUND FACILITIES, STRUCTURES, AND UTILITIES HAVE BEEN SHOWN BASED UPON INFORMATION OBTAINED FROM FIELD LOCATIONS BY UTILITY COMPANIES, AVAILABLE SURVEYS AND RECORDS. THEIR LOCATIONS MUST BE CONSIDERED APPROXIMATE ONLY. IT IS ALSO POSSIBLE THAT THERE MAY BE OTHER UNDERGROUND FACILITIES, STRUCTURES, AND UTILITIES IN EXISTENCE THAT ARE NOT SHOWN. IT IS THE RESPONSIBILITY OF EACH INDIVIDUAL PARTY REFERENCING THIS PLAN TO DETERMINE THE EXACT LOCATION AND TYPE OF UNDERGROUND FACILITIES ON THE SITE. HAND EXCAVATE AT CRITICAL POINTS AS NECESSARY TO VERIFY LOCATIONS, SIZES, ELEVATIONS, FLOW LINES, ETC. IF A PROBLEM OR INTERFERENCE EXISTS, NOTIFY ARCHITECT/ENGINEER BEFORE PROCEEDING.

GENERAL NOTES - ELECTRICAL

- A. ALL CONDUIT AND CONDUCTOR SIZES HAVE BEEN SIZED WITH THWN COPPER WIRING. COORDINATE ALL SIZES AND CHANGES WITH ENGINEER BEFORE PROCEEDING.
- B. ALL CONDUITS TO BE INSTALLED 30"+ BELOW GRADE TO MEET DOT STANDARDS.
- C. CUT SHEET/PICTURES HAVE BEEN INCLUDED IN THESE DOCUMENTS FOR REFERENCE ONLY. SHOP DRAWINGS AND OWNERS MANUALS WILL BE REQUIRED AT SUBSTANTIAL COMPLETION.
- LOCATIONS OF POLES/FIXTURES ON DRAWINGS ARE SHOWN FOR THE BEST LIGHTING COVERAGE. REVIEW SITE PLANS, SURVEYS, UTILITY LOCATIONS, EASEMENT, AND ALL OTHER UNGEROUND FACILITIES BEFORE PROCEEDING WITH DIGGING AND INSTALLATION OF FIXTURES. MOUNT POLES 2'-3" BACK FROM NEW CURB.

LIGHTING SYMBOLS EXTERIOR POLE MOUNTED LIGHT FIXTURE, REFER TO LIGHT FIXTURE SCHEDULE LIGHTING CONTACTOR PC PHOTOCELL W DUPLEX GFCI WEATHER RESISTANT RECEPTACLE WITH WEATHER-PROOF IN-USE COVER, TAMPER-RESISTANT, WALL MOUNT +24", OR AS NOTED PANELBOARD - SURFACE MOUNTED



ILLINOIS IOWA

WISC ONSIN

owner/developer:
CITY OF FAIRBANK
116 EAST MAIN
STREET
FAIRBANK, IA 50629

PROJECT AND LOCATION:

MAIN STREET
IMPROVEMENTS
FAIRBANK, IOWA

DRAWN BY:KCL
APPROVED BY:KCL
DATE: 10/27/2022
SCALE: AS NOTED

REV. DESCRIPTION DATE

ELECTRICAL NOTES & SYMBOLS

SET TYPE: BID LETTING

JOB NUMBER: 22-1100


LIGHTING FIXTURE SCHEDULE

NOTES:

- 1. ALL FIXTURES SHALL BE U.L. OR SIMILARLY LISTED.
- 2. CONTRACTOR IS RESPONSIBLE FOR ALL MISCELLANEOUS HARDWARE NECESSARY TO INSTALL AND SUPPORT THE LUMINAIRES.
- 3. REFER TO CIVIL ENGINEERING DOCUMENTS FOR EXACT MOUNTING LOCATIONS, DETAILS, AND CONFIGURATIONS OF ALL LUMINAIRES.
- 4. CONTRACTOR IS RESPONSIBLE FOR OBTAINING AND FILLING OUT ALL UTILITY REBATE FORMS FOR OWNER.
- 5. MATERIALS SHALL COMPLY WITH BUILD AMERICA, BUY AMERICA (BABA) REQUIREMENTS AS NOTED UNDER ADOPTED INFRASTRUCTURE INVESTMENT AND JOBS ACT (IIJA).
- 6. PROVIDE (1) COMPLETE ADDITIONAL P1 PACKAGE ASSEMBLY FOR OWNER SPARE PARTS USE. PROVIDE SPARE PARTS, FIXTURE, POLE, ACCESSORIES ETC.

DESIGNED BY: JTL

<u>TYPE</u>	<u>MANUFACTURER</u>	<u>MODEL</u>	<u>DESCRIPTION</u>	VOLTAGE	LOAD-VA	LAMP TYPE
P1	HOLOPHANE	(1) MPL3-P20S-40K-MVOLT-TG2-QSM-BK-AO (FIXTURE) (1) BHC-48IN-1A-TN-SL5-BK-QSM (ARM) (1) SLA-22-SL5-SB-CO5-BK-ABG-RP240A & AB-27-4 WITH TMP40017 (POLE) (2) BA-24IN-1A-BO-SL5-HB-100P-BK (BANNER) (1) PBA-24IN-1A-BO-SL5-HB-100P-BK (FLOWER BASKET) (1) FGB (POLE BASE RECEPT) (1) FGIUS-BK-NON GFCI (POLE MOUNTED RECEPT) (1) FPH-2F-BO-SL5-100P-BK (DUAL FLAG HOLDER) (6) STANDARD TRACK BOLTS FOR SLA POLE (2) 45-DEGREE TRACK BOLTS FOR SLA POLE	POST TOP TENON MOUNTED TEAR DROP LED LIGHT WITH 48" FIXTURE ARM WITH QUICK CONNECT. MINIMUM 11,000 LUMENS AT TYPE 2 DISTRIBUTION. MOUNT TO 22'-0" TALL 5" SQUARE EXTRUDED ALUMINUM POLE USING 3"X5" TENON. PROVIDE POLE ACCESSORIES AS NOTED AND FIELD VERIFY LOCATIONS / HEIGHTS WITH OWNER. ALL MATERIALS BLACK FINISH.	120 V	73 VA	LED 4,000K CCT
P2	HOLOPHANE	SIMILAR TO P1 WITH SAME ACCESSORIES.	SIMILAR TO P1 BUT FOR BRIDGE. MOUNT TO EXISTING FOUNDATIONS AND REUSE ANCHOR BOLTS. NOTIFY ENGINEER IF ANCHOR BOLTS ARE UNUSABLE.	120 V	73 VA	LED 4,000K CCT

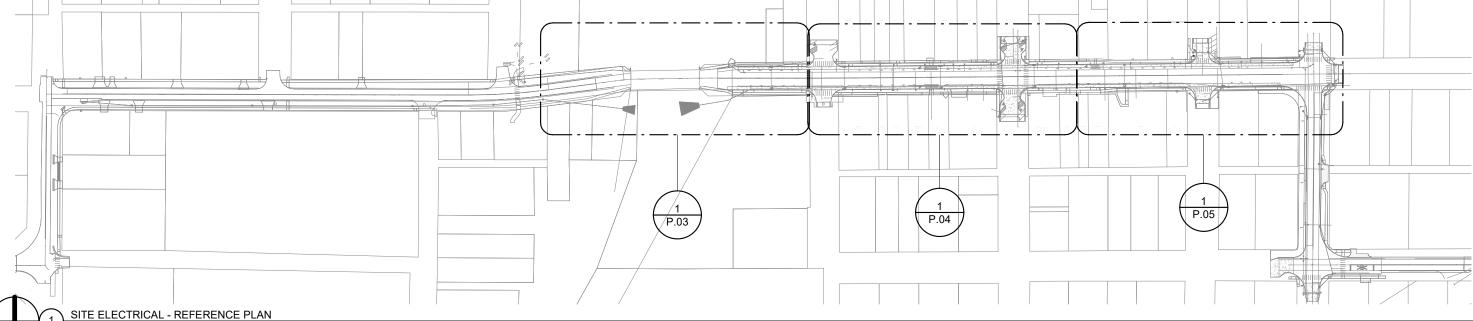

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ILLINOIS IOWA WISCONSIN OWNER/DEVELOPER:

CITY OF FAIRBANK
116 EAST MAIN
STREET
FAIRBANK, IA 50629

PROJECT AND LOCATION:

MAIN STREET
IMPROVEMENTS
FAIRBANK, IOWA

DRAWN BY: KCL
APPROVED BY: KCL
DATE: 10/27/2022
SCALE: AS NOTED

	REVISIONS	
REV. NO.	DESCRIPTION	DATE

SITE REFERENCE AND FIXTURE
SCHEDULE
SET TYPE: BID LETTING

JOB NUMBER: 22-1100


SHEET NUMBER: P.02

KEYNOTES

- #
- 1 (2) 120V CIRCUITS IN SAME TRENCH TO EACH POLE. (1) ROADWAY LIGHTING BRANCH CIRCUIT USING MINIMUM #3 COPPER CONDUCTORS IN 1" PVC SCH. 80 CONDUIT. (1) WEATHERPROOF GFCI PROTECTED RECEPTACLE CIRCUIT USING MINIMUM #3 COPPER CONDUCTORS IN 1" PVC SCH. 80 CONDUIT.
- 2 CONTINUE ROADWAY LIGHTING CIRCUIT TO BRIDGE MOUNTED POLES VIA EXISTING CONDUIT PATHWAY EMBEDDED IN BRIDGE PIERS. IF PATHWAY IS NOT ACCESSIBLE, SURFACE MOUNT CONDUIT BACKSIDE OF BRIDGE PIER AND CORE DRILL INTO EXISTING POLE BASE HAND HOLE. FIELD COORDINATE INSTALLATION PRIOR TO ROUGH-IN.

GENERAL SITE ELECTRICAL NOTES

- A. UTILITIES SHOWN ON ELECTRICAL SITE PLAN ARE SCHEMATIC ONLY. VERIFY SITE CONDITIONS AND DIMENSIONS PRIOR TO COMPLETING BID AND ORDERING OF EQUIPMENT.
- B. WARNING -CALL 48 HOURS BEFORE YOU DIG: -IOWA LAW REQUIRES ANYONE DOING ANY EXCAVATION, FENCING, PLANTING OR DRILLING TO CALL 48 HOURS IN ADVANCE. HAND DIG WITHIN 18 INCHES OF ANY LOCATE MARK OR FLAG. IOWA ONE-CALL 1-800-292-8989.
- C. LOCATE POLES 2'-3" BEHIND CURB AND VERIFY FINAL STAKING AND LOCATION WITH CIVIL DURING CONSTRUCTION PRIOR TO ROUGH-IN.
- D. ALL UNDERGROUND ELECTRICAL ROUTES SHALL BE INSTALLED AT 30" BELOW GRADE.

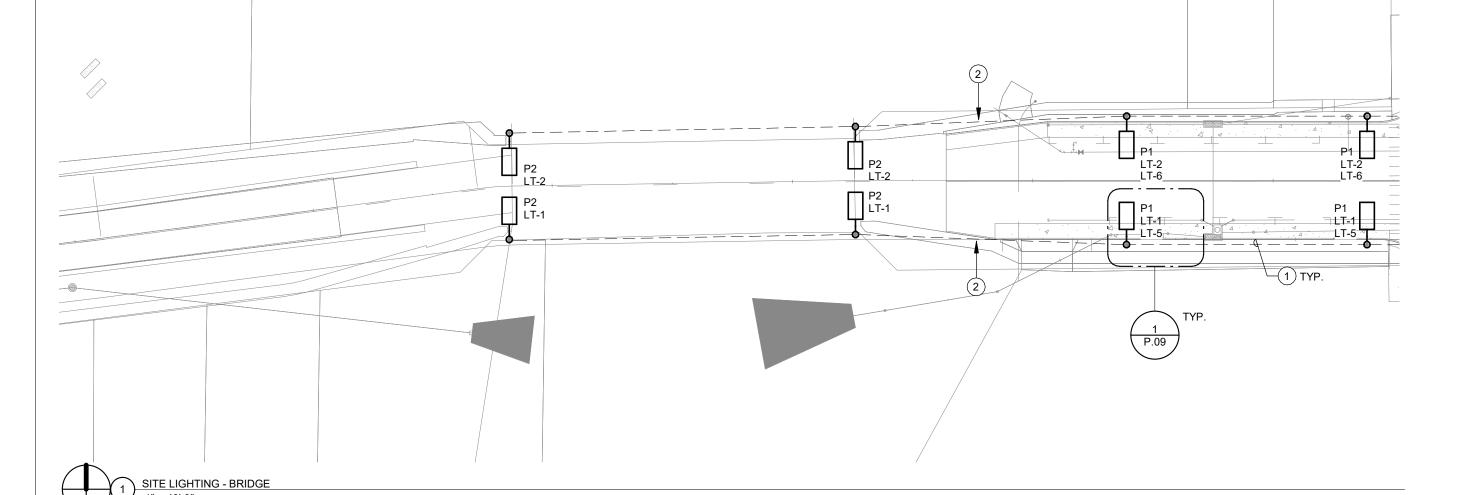

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ILLINOIS IOWA WISCONSIN OWNER/DEVELOPER:

CITY OF FAIRBANK
116 EAST MAIN
STREET
FAIRBANK, IA 50629

PROJECT AND LOCATION:

MAIN STREET
IMPROVEMENTS
FAIRBANK, IOWA

DRAWN BY: KCL
APPROVED BY: KCL
DATE: 10/27/2022
SCALE: AS NOTED

	REVISIONS	
REV. NO.	DESCRIPTION	DATE

SITE LIGHTING - BRIDGE

SET TYPE: BID LETTING

JOB NUMBER:
22-1100

SHEET NUMBER:


KEYNOTES

#

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ILLINOIS IOWA WISCONSIN OWNER/DEVELOPER:

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116 EAST MAIN
STREET
FAIRBANK, IA 50629

PROJECT AND LOCATION:

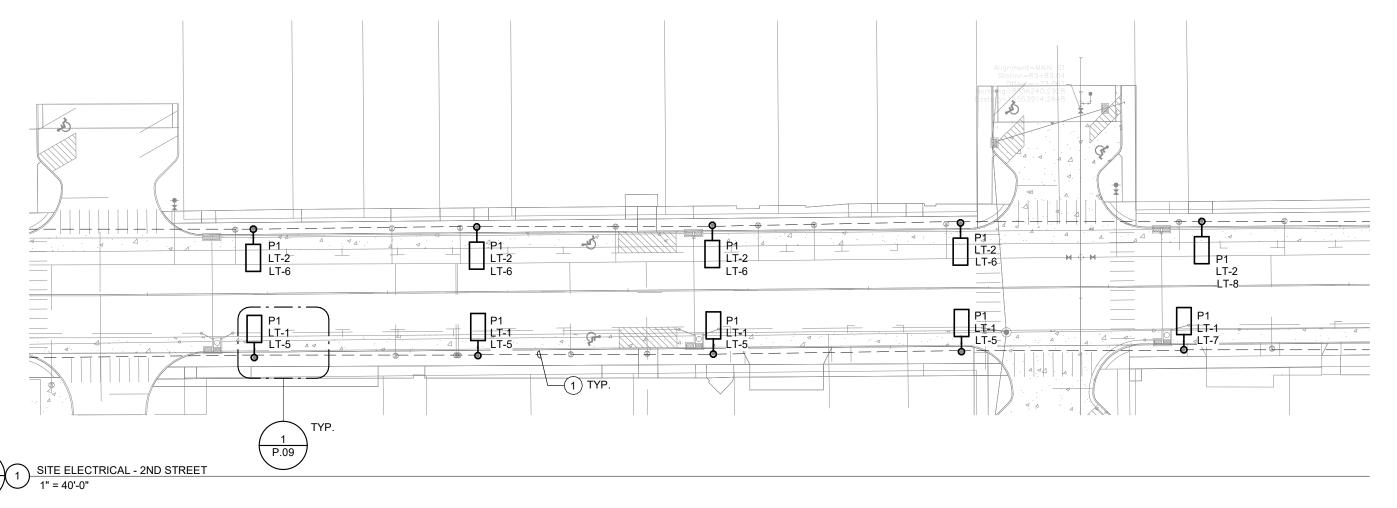MAIN STREET
IMPROVEMENTS
FAIRBANK, IOWA

DRAWN BY: KCL
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DATE: 10/27/2022
SCALE: AS NOTED

REV. NO.	DESCRIPTION	DATE

SITE LIGHTING - 2ND STREET

SET TYPE: BID LETTING

JOB NUMBER:
22-1100

SHEET NUMBER:


KEYNOTES



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- C. LOCATE POLES 2'-3" BEHIND CURB AND VERIFY FINAL STAKING AND LOCATION WITH CIVIL DURING CONSTRUCTION PRIOR TO ROUGH-IN.
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ILLINOIS IOWA WISCONSIN OWNER/DEVELOPER:

CITY OF FAIRBANK
116 EAST MAIN
STREET
FAIRBANK, IA 50629

PROJECT AND LOCATION:

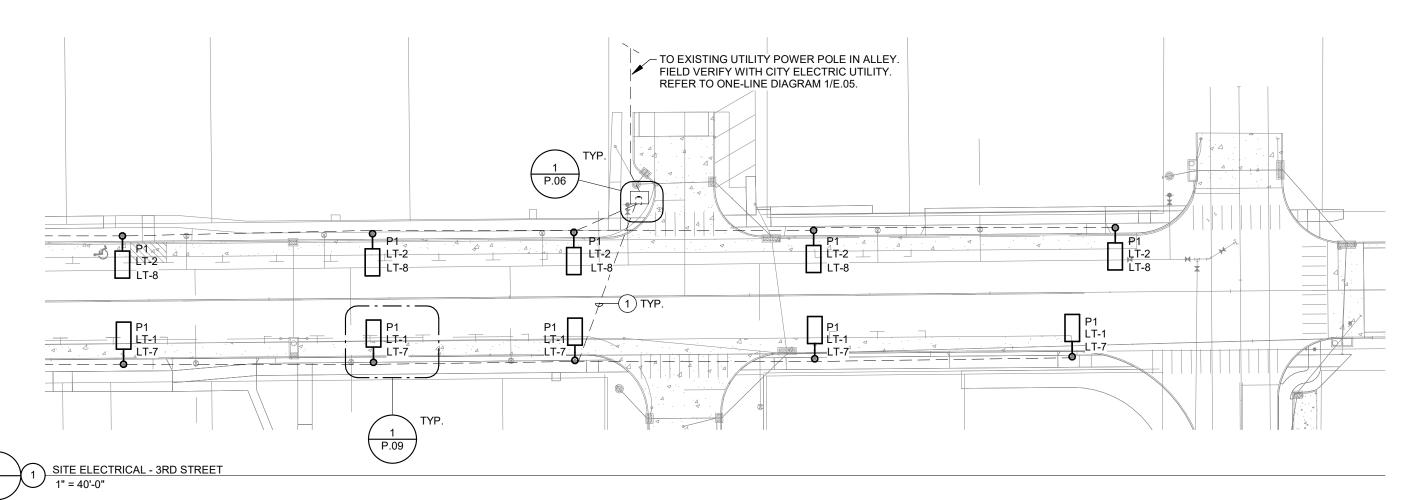MAIN STREET

IMPROVEMENTS

FAIRBANK, IOWA

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DATE: 10/27/2022
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REV. NO.	DESC RIPTION	DATE

SITE LIGHTING - 3RD STREET

SET TYPE: BID LETTING

JOB NUMBER:
22-1100

SHEET NUMBER:

RISER DIAGRAM GENERAL NOTES

- DIAGRAM INDICATES OVERALL LAYOUT OF ELECTRICAL DISTRIBUTION SYSTEM. REFER TO FLOOR PLANS FOR **EQUIPMENT LOCATIONS.**
- USE COPPER CONDUCTORS UNLESS OTHERWISE INDICATED. B.
- C. MATCH NEUTRAL CONDUCTOR SIZE TO THE PHASE CONDUCTORS UNLESS OTHERWISE NOTED.
- D. ALL WIRING SHALL BE IN RACEWAY AS NOTED. REFER TO SPECIFICATIONS FOR CONDUIT APPLICATION REQUIREMENTS.
- INSTALL UTILITY TRANSFORMER PAD, METERING EQUIPMENT, AND SERVICE ENTRANCE FEEDERS IN ACCORDANCE WITH UTILITY COMPANY REQUIREMENTS.



ENCLOSURE EXAMPLE OF NEW EQUIPMENT AT 3RD AND MAIN STREET

> ONE-LINE DIAGRAM NOT TO SCALE

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ILLINOIS IOWA

CITY OF FAIRBANK 116 EAST MAIN STREET WISC ONSIN FAIRBANK, IA 50629

OWNER/DEVELOPER:

PROJECT AND LOCATION MAIN STREET **IMPROVEMENTS** FAIRBANK, IOWA

DRAWN BY: KCI APPROVED BY:KCL DATE: 10/27/2022 SCALE: AS NOTED


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ELECTRICAL ONE-LINE DIAGRAM

JOB NUMBER: 22-1100

P.06

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SHEET NUMBER:

BRANCH PANEL: LT

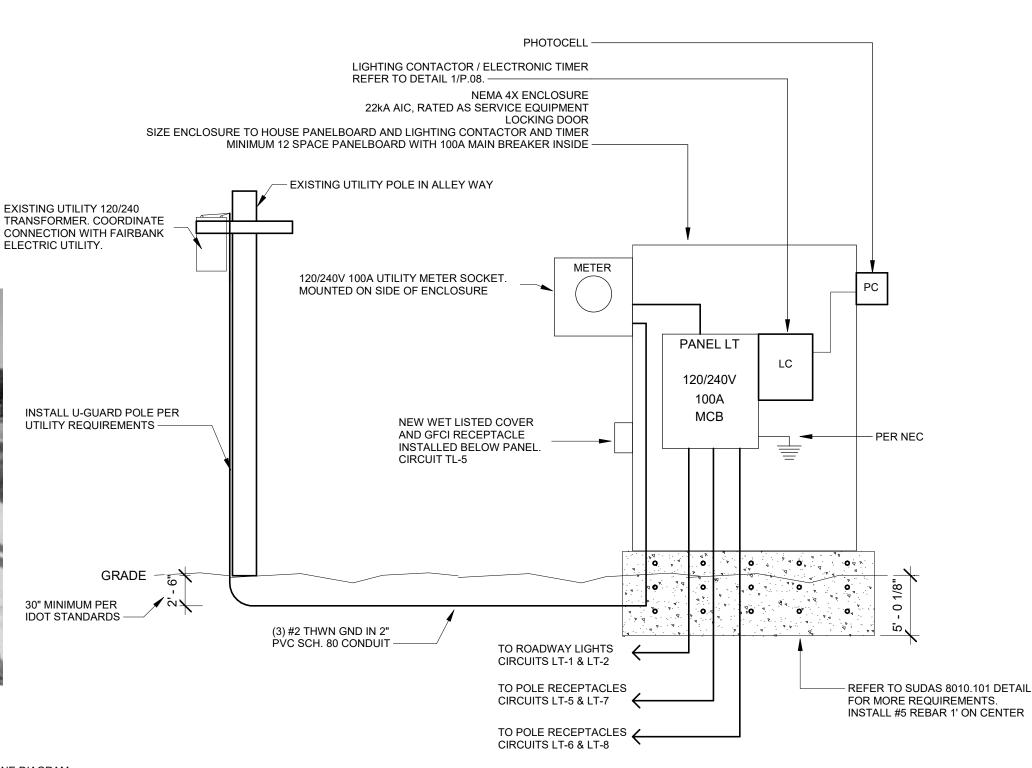LOCATION: 3RD & MAIN ST.

VOLTAGE: 120/240 SINGLE

SCCR RATING: 22,000 A

SUPPLY FROM: UTILITY

PHASES: 1
WIRES: 3

MAINS TYPE: MCB

MOUNTING: SURFACE

MAINS RATING: 100 A

ENCLOSURE: TYPE 1

MCB RATING: 100 A

NOTES:

MOUNTED INSIDE OF NEMA 4X ENCLOSURE AS SHOWN ON P.06. SUPPLY WITH INTEGRAL SPD.

CIRCUIT DESCRIPTION	Р	AMP	CKT NO		A		В	CKT NO	AMP	Р	CIRCUIT DESCRIPTION
SOUTH ROADWAY LIGHTING	1	20 A	1	1022	1022			2	20 A	1	NORTH ROADWAY LIGHTING
EXTERIOR RECEPTACLE	1	20 A	3			180	1080	4	20 A	1	NORTH POLE MT. RECEPTACLES (3RD ST.) "G"
SOUTH POLE MT. RECEPTACLES (2ND ST.) "G"	1	20 A	5	1080	1080			6	20 A	1	NORTH POLE MT. RECEPTACLES (2ND ST.) "G"
SOUTH POLE MT. RECEPTACLES (3RD ST.) "G"	1	20 A	7			1080	0	8	20.4	2	INTEGRAL SPD
SPARE	1	20 A	9	0	0			10	20 A 2		INTEGRAL SPD
SPARE	1	20 A	11			0	0	12	20 A	1	SPARE
	•		'	420	04 VA	234	0 VA			_	

35 A

20 A

LEGEND:

"G" INDICATES GFCI TYPE BREAKER.

LOAD CLASSIFICATION	CONNECTED LOAD	DEMAND FACTOR	ESTIMATED	PANEL TOTALS
LIGHTING	2044 VA	125.00%	2555 VA	
Spare	4500 VA	100.00%	4500 VA	TOTAL CONN. LOAD: 6544 VA
				TOTAL EST. DEMAND: 7055 VA
				TOTAL CONN.: 27 A
				TOTAL EST. DEMAND: 29 A

NOTES:

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ILLINOIS IOWA WISCONSIN OWNER/DEVELOPER:

CITY OF FAIRBANK
116 EAST MAIN
STREET
FAIRBANK, IA 50629

PROJECT AND LOCATION:
MAIN STREET
IMPROVEMENTS
FAIRBANK, IOWA

DRAWN BY: KCL
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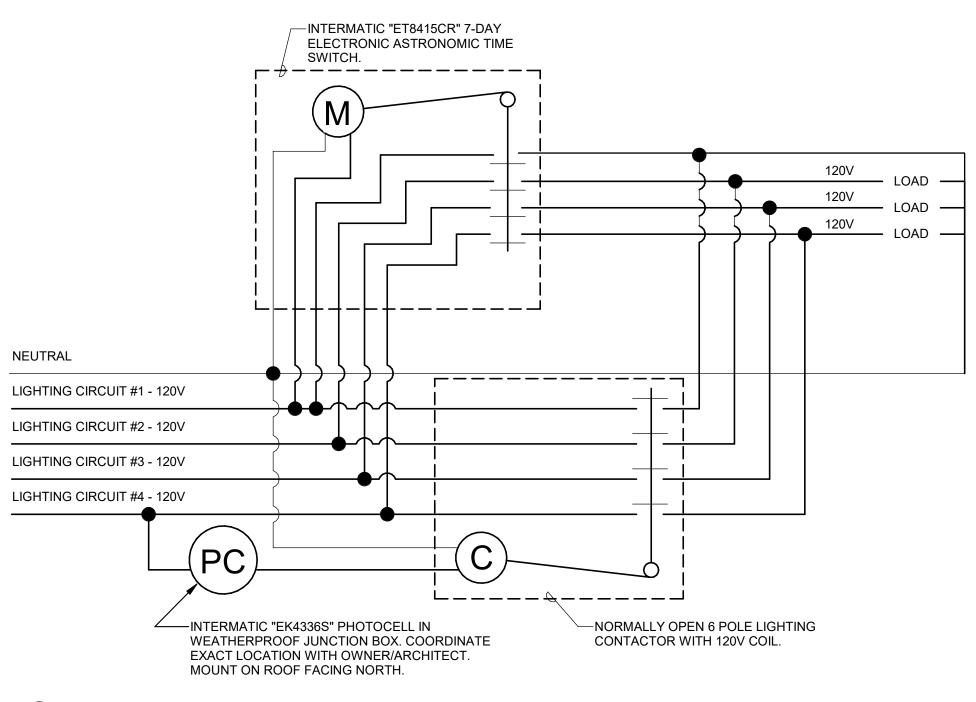
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REV. NO.	DESC RIPTION	DATE		
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DRAWING: ELECTRICAL SCHEDULES

SET TYPE: BID LETTING

JOB NUMBER:
22-1100

SHEET NUMBER:



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SITE LIGHTING TIME SWITCH NOT TO SCALE

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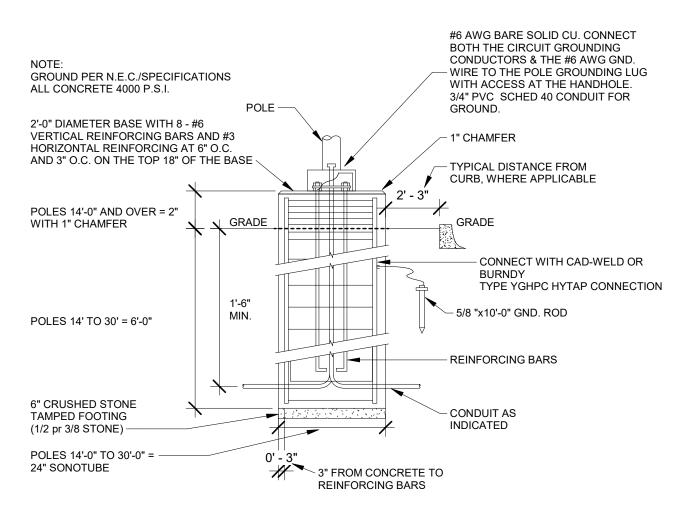
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REV. NO.	DESC RIPTION	DATE
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ELECTRICAL DETAILS

SET TYPE: BID LETTING

JOB NUMBER: 22-1100

SHEET NUMBER: P.08



RECEPTACLE -BACKSIDE OF POLE **BANNER ARMS** FLAG HOLDERS FLOWER BASKET ARM **RECEPTACLE - BACKSIDE** OF POLE BASE

1 LIGHTING POLE BASE - POURED IN PLACE NOT TO SCALE

ENGINEERING

300 4th St West Des Moines, IA 50265 515-724-7938

ILLINOIS

IOWA

WISCONSIN

OWNER/DEVELOPER: CITY OF FAIRBANK 116 EAST MAIN STREET FAIRBANK, IA 50629 PROJECT AND LOCATION: MAIN STREET IMPROVEMENTS FAIRBANK, IOWA DRAWN BY: KCL APPROVED BY:KCL DATE: 10/27/2022 SCALE: AS NOTED

P1 POLE SECTIONS NOT TO SCALE

> REVISIONS DESC RIPTION DATE

ELECTRICAL DETAILS

BOSTON HARBOR ARM

JOB NUMBER: 22-1100 SHEET NUMBER:


P.09

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SET TYPE: BID LETTING

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ILLINOIS IOWA WISCONSIN OWNER/DEVELOPER:

CITY OF FAIRBANK
116 EAST MAIN
STREET
FAIRBANK, IA 50629

PROJECT AND LOCATION:
MAIN STREET
IMPROVEMENTS
FAIRBANK, IOWA

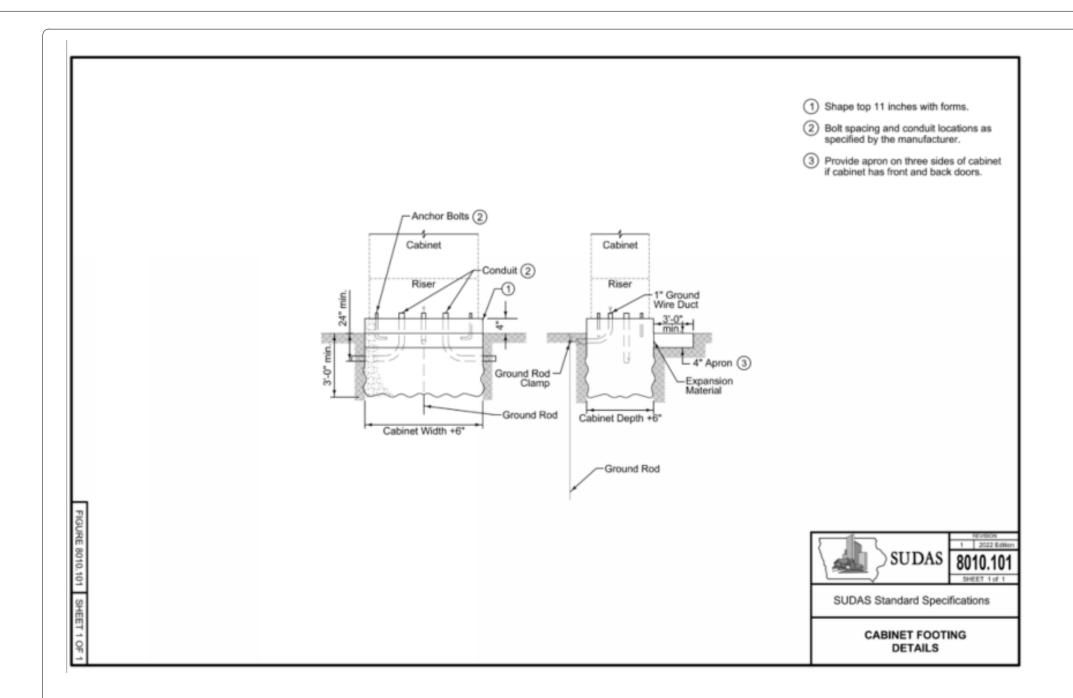DRAWN BY: KCL
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DATE: 10/27/2022
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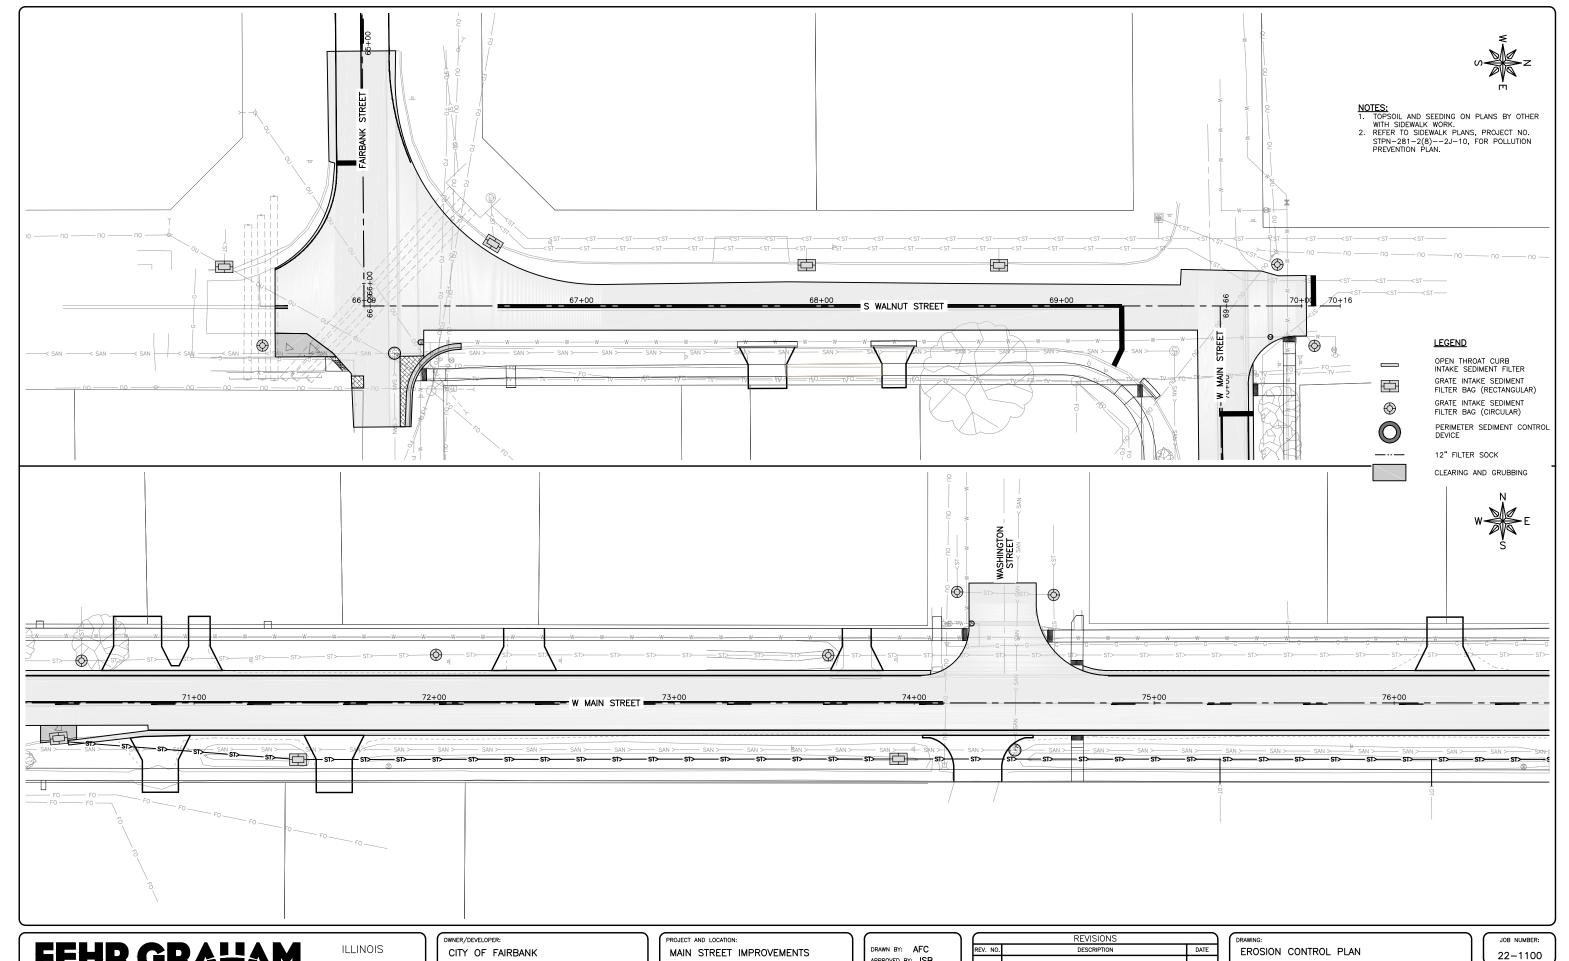
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REV. NO.	DESC RIPTION	DATE	
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ELECTRICAL DETAILS

SET TYPE: BID LETTING

22-1100
SHEET NUMBER:
P.10

JOB NUMBER:



FEHR GRAHA **ENGINEERING & ENVIRONMENTAL**

IOWA WISCONSIN 116 EAST MAIN STREET FAIRBANK, IA 50629


FAIRBANK, IOWA BUCHANAN COUNTY STPN-281-2(10)--2J-10

APPROVED BY: JSB DATE: 10/27/22 SCALE: AS NOTED

	REVISIONS	
REV. NO.	DESCRIPTION	DATE

SET TYPE: BID LETTING

SHEET NUMBER: RC.01

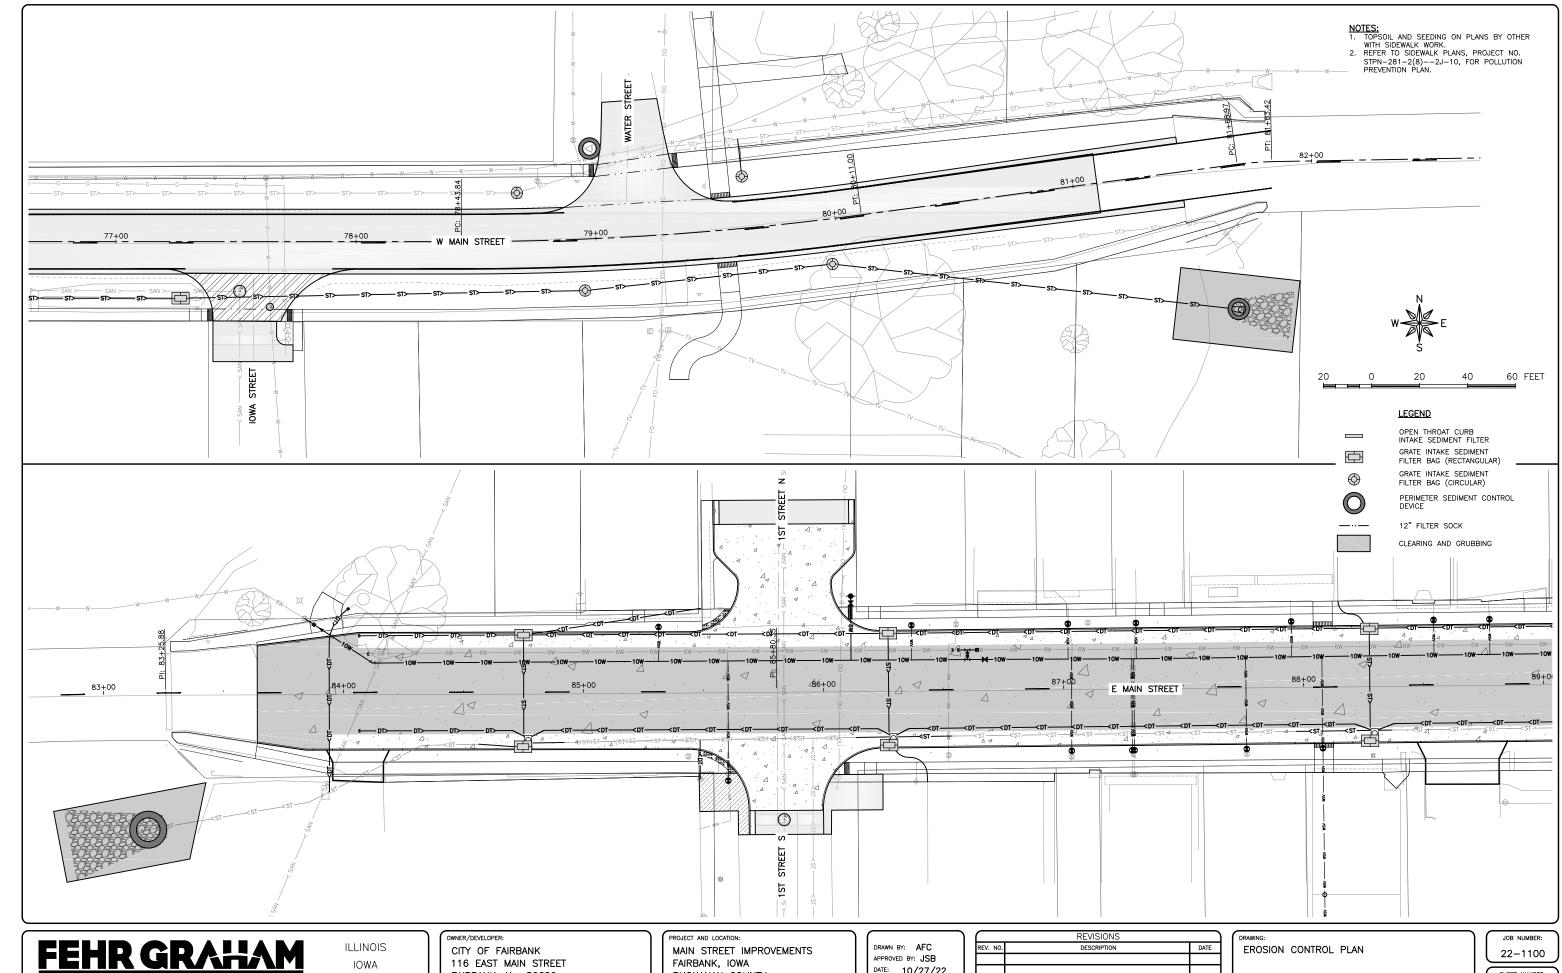

IOWA WISCONSIN 116 EAST MAIN STREET FAIRBANK, IA 50629

FAIRBANK, IOWA BUCHANAN COUNTY STPN-281-2(10)--2J-10


APPROVED BY: JSB DATE: 10/27/22 SCALE: AS NOTED


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REV. NO.		DATE
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SET TYPE: BID LETTING

SHEET NUMBER:

RC.02



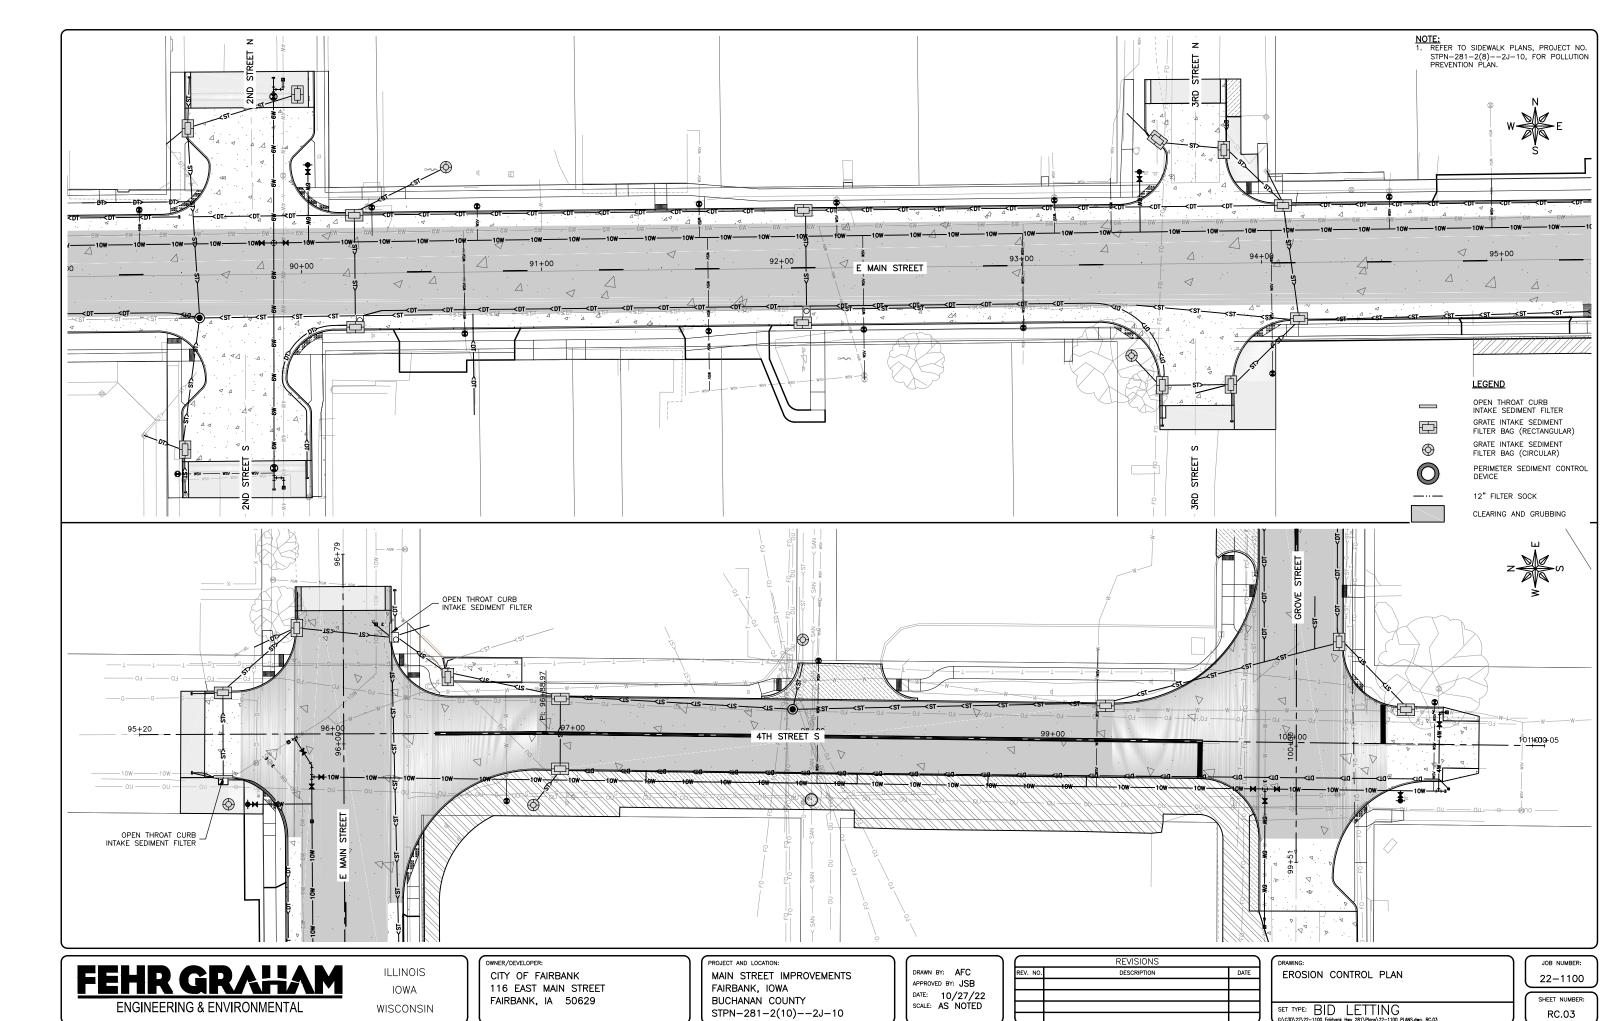

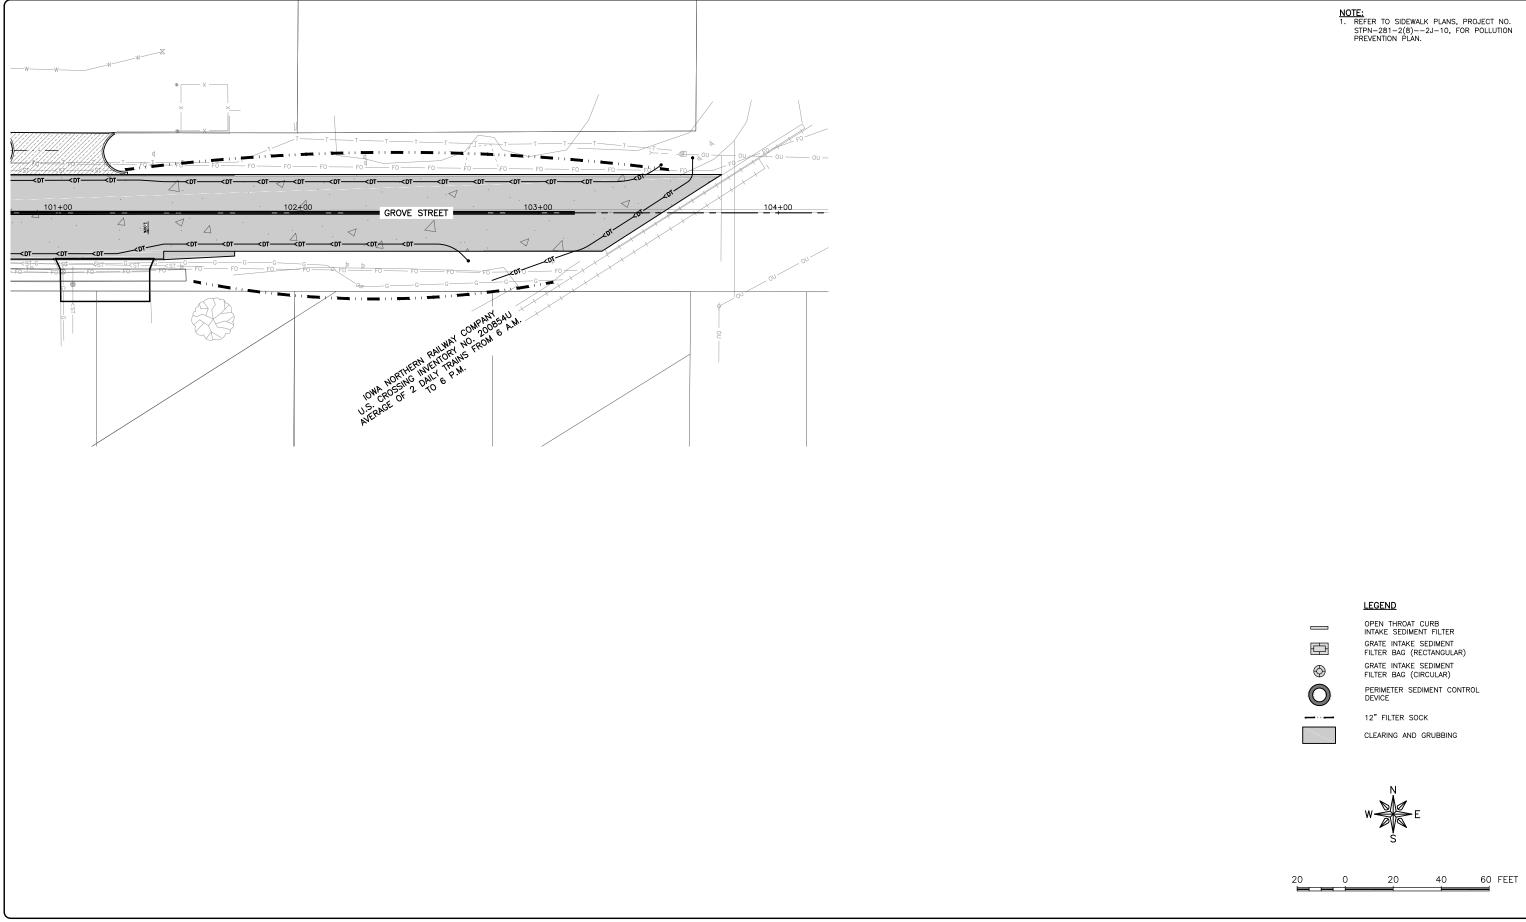ILLINOIS IOWA WISCONSIN owner/developer:
CITY OF FAIRBANK
116 EAST MAIN STREET
FAIRBANK, IA 50629

PROJECT AND LOCATION:

MAIN STREET IMPROVEMENTS
FAIRBANK, IOWA
BUCHANAN COUNTY
STPN-281-2(10)--2J-10

DRAWN BY: AFC
APPROVED BY: JSB
DATE: 10/27/22
SCALE: AS NOTED

	REVISIONS	
REV. NO.	DESCRIPTION	DATE

DRAWING: EROSION CONTROL PLAN


SET TYPE: BID LETTING

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JOB NUMBER:
22-1100

SHEET NUMBER:

RC.04



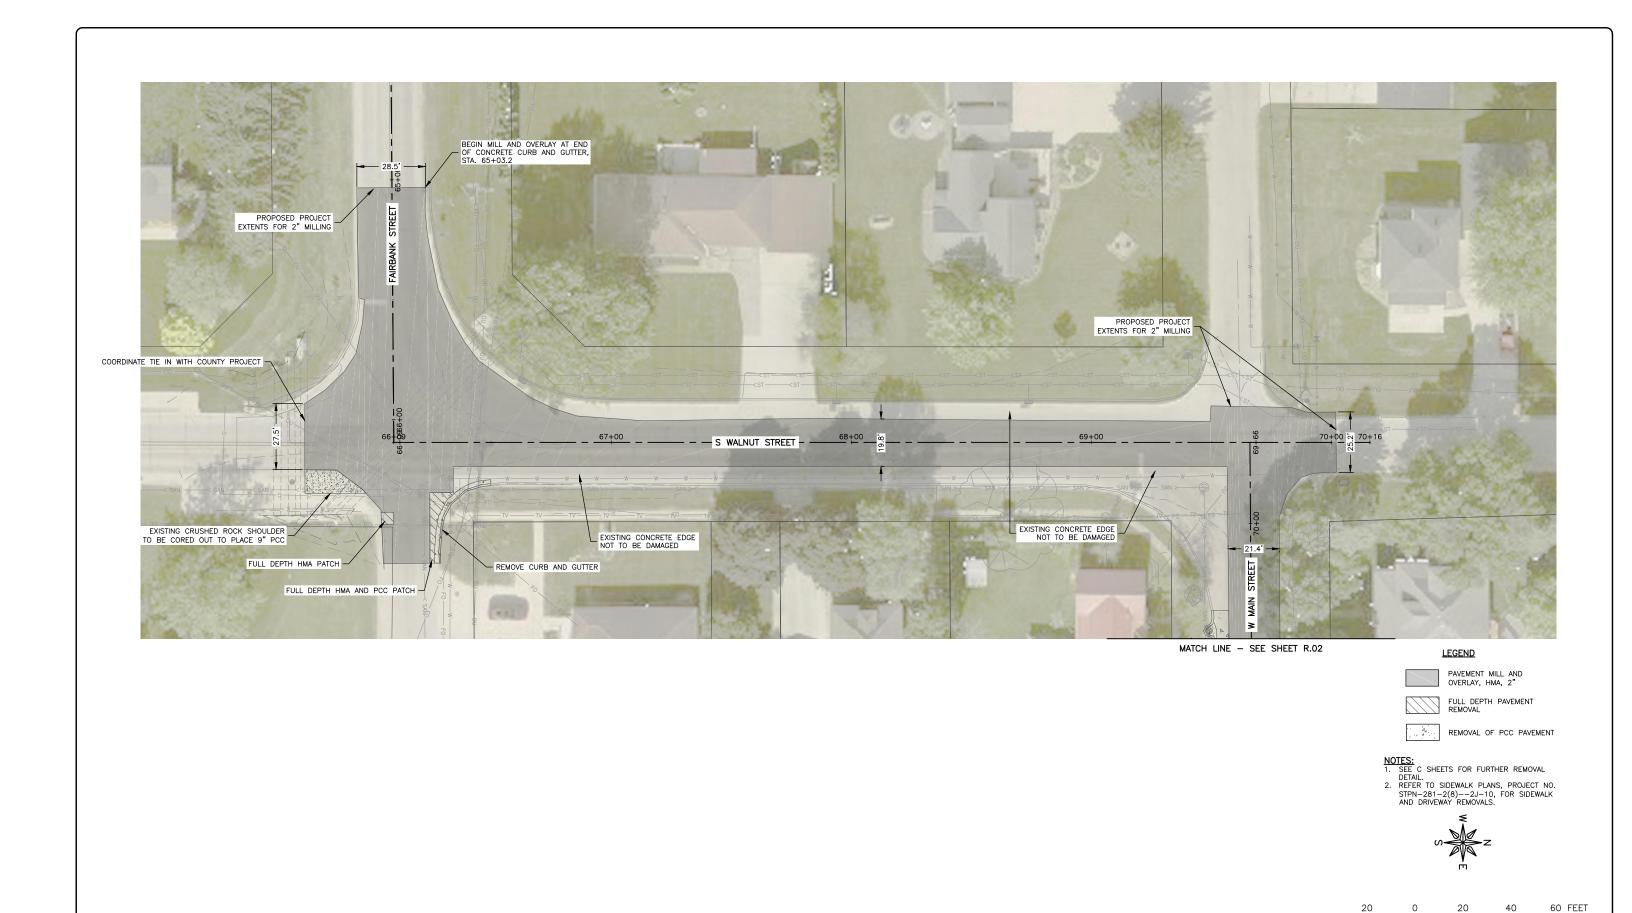

ILLINOIS IOWA WISCONSIN owner/developer: CITY OF FAIRBANK 116 EAST MAIN STREET FAIRBANK, IA 50629 PROJECT AND LOCATION:

MAIN STREET IMPROVEMENTS
FAIRBANK, IOWA
BUCHANAN COUNTY
STPN-281-2(10)--2J-10


DRAWN BY: AFC
APPROVED BY: JSB
DATE: 10/27/22
SCALE: AS NOTED


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REMOVAL PLAN	
SET TYPE: BID LETTING G:\C30\22\22-1100 Fgirbank Hwy 281\Plans\22-1100 PLANS.dwg, REMOVALS (1)	

JOB NUMBER:
22-1100

SHEET NUMBER:
U.01



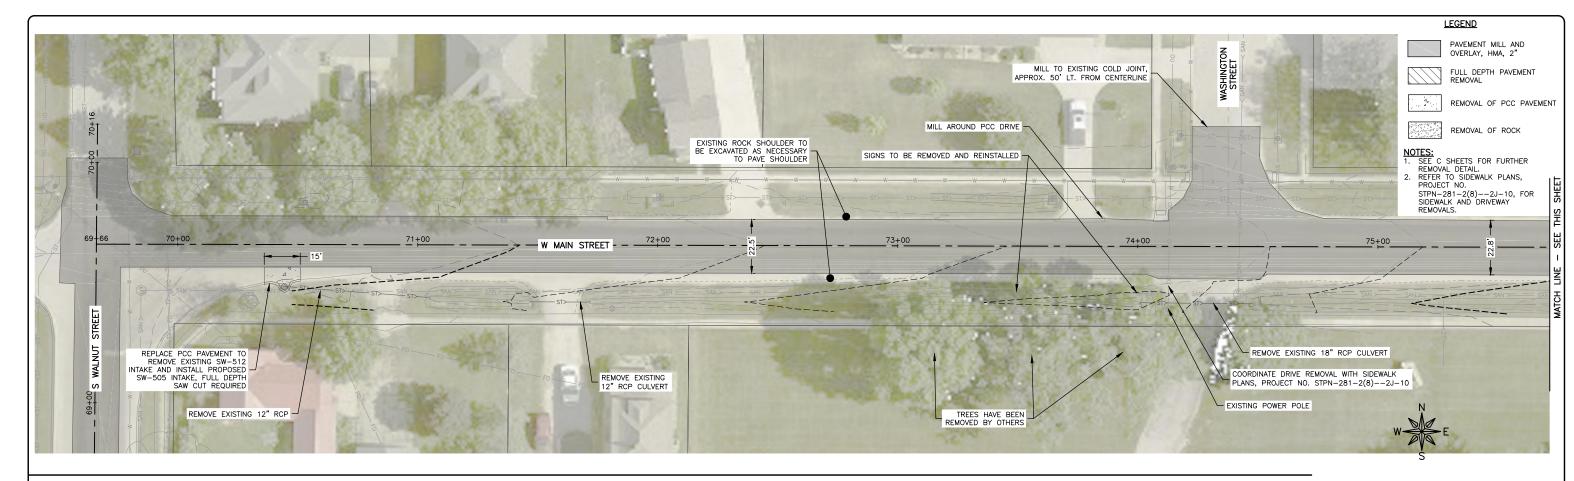
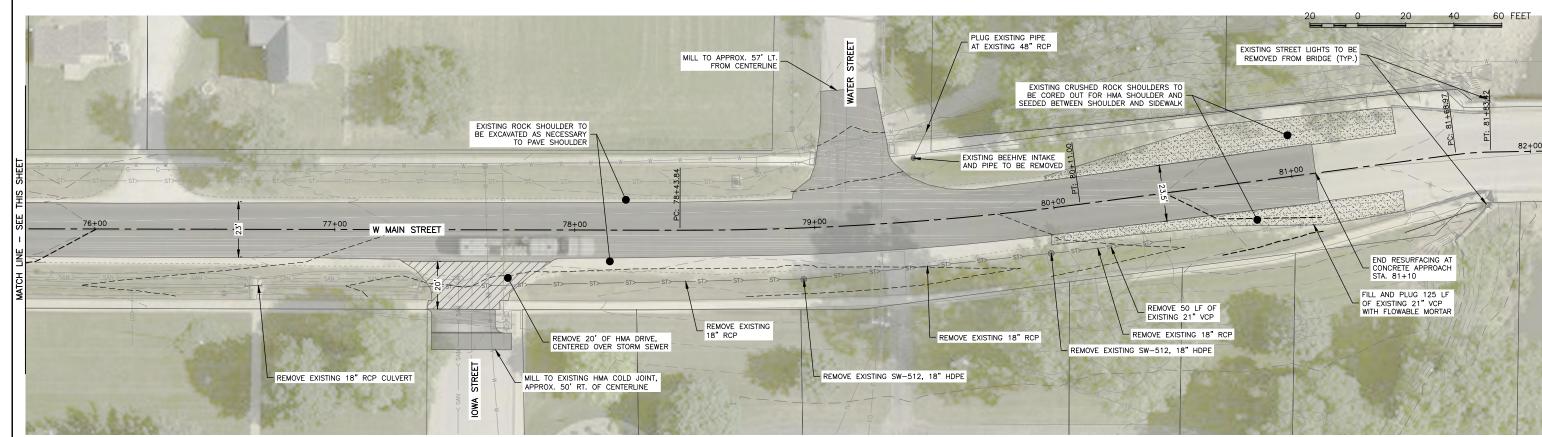
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ENGINEERING & ENVIRONMENTAL

ILLINOIS IOWA WISCONSIN owner/developer:
CITY OF FAIRBANK
116 EAST MAIN STREET
FAIRBANK, IA 50629

PROJECT AND LOCATION:

MAIN STREET IMPROVEMENTS
FAIRBANK, IOWA
BUCHANAN COUNTY
STPN-281-2(10)--2J-10


DRAWN BY: AFC
APPROVED BY: JSB
DATE: 10/27/22
SCALE: AS NOTED


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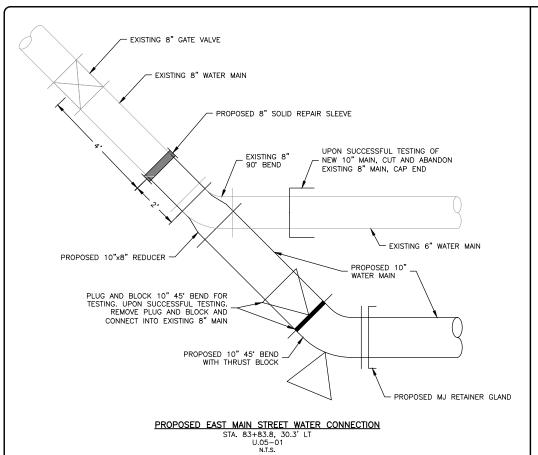
DRAWING:
REMOVAL PLAN
SET TYPE: BID LETTING


JOB NUMBER: 22-1100


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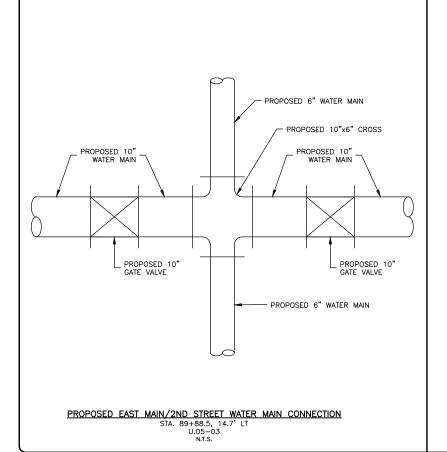





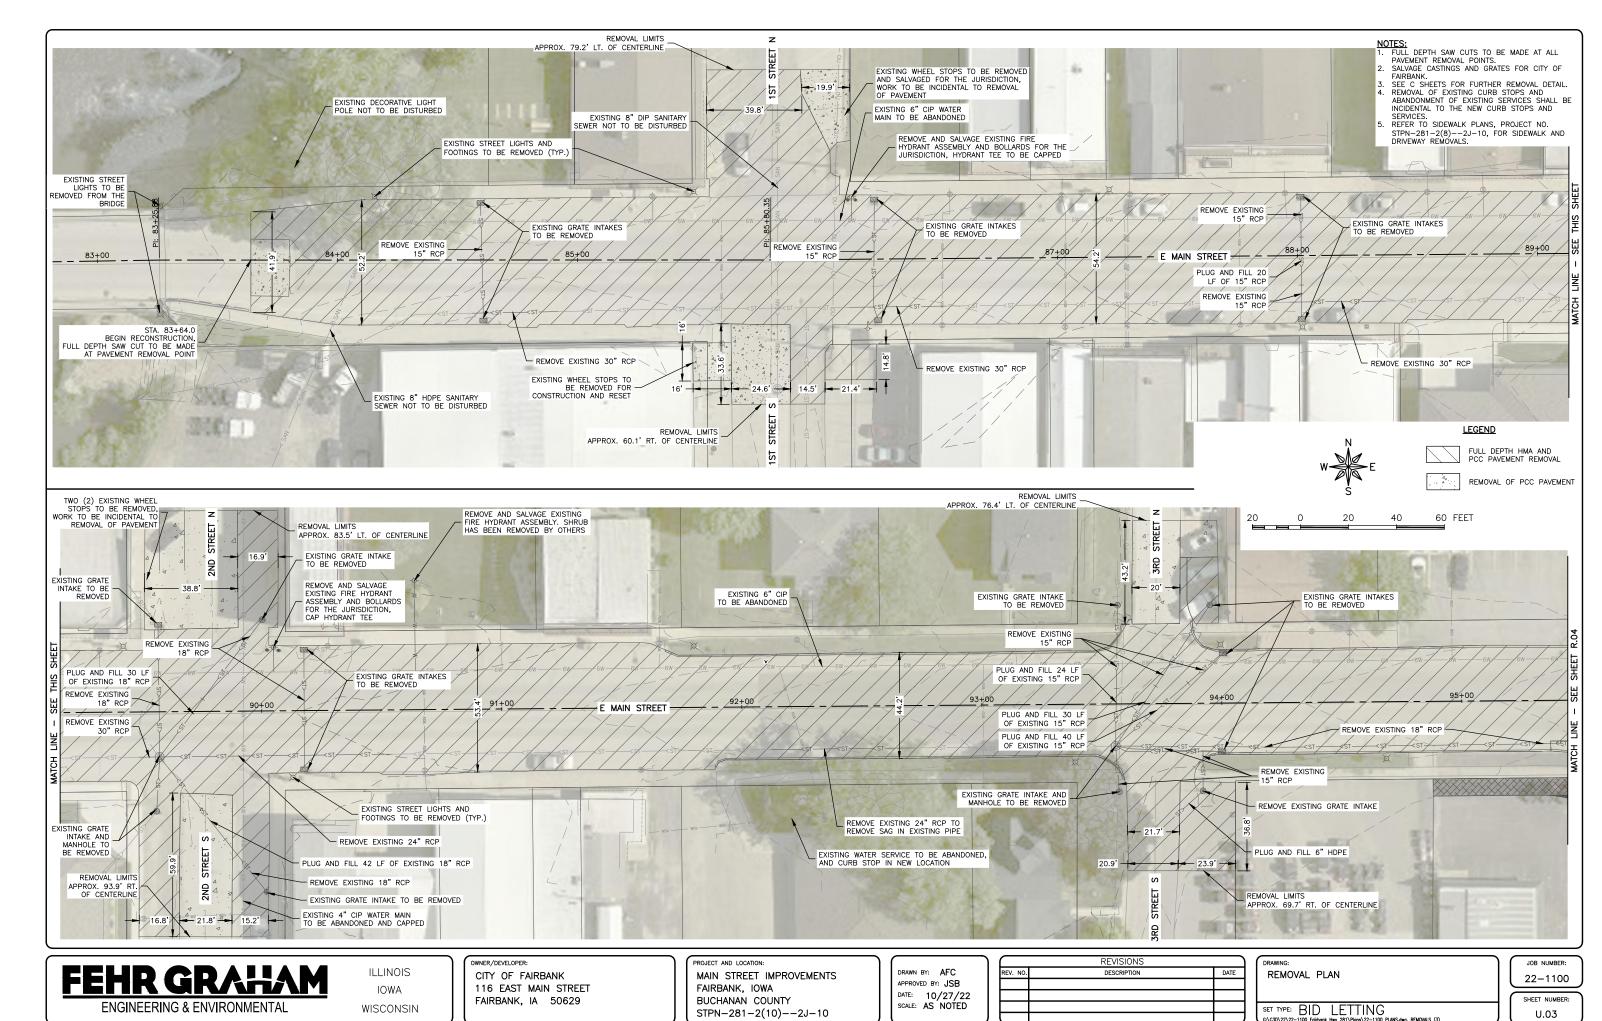


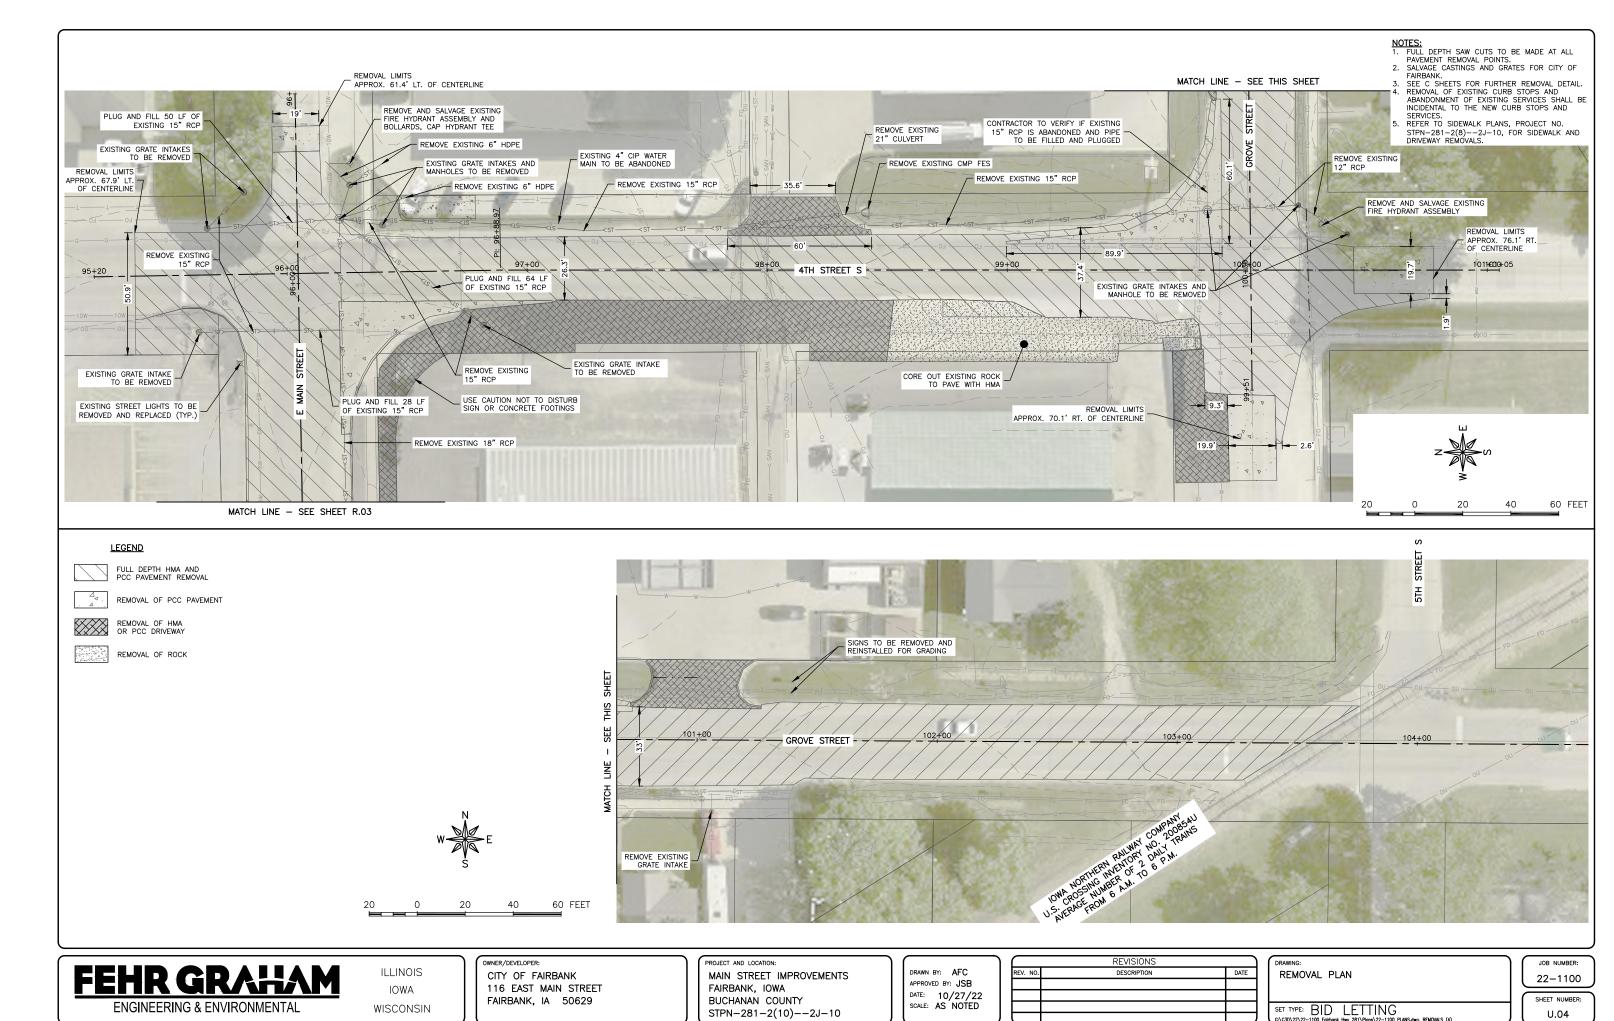

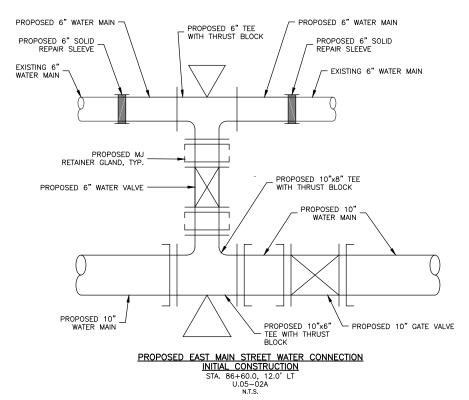

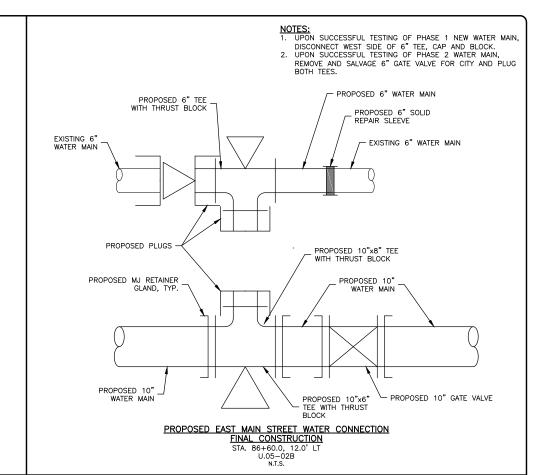

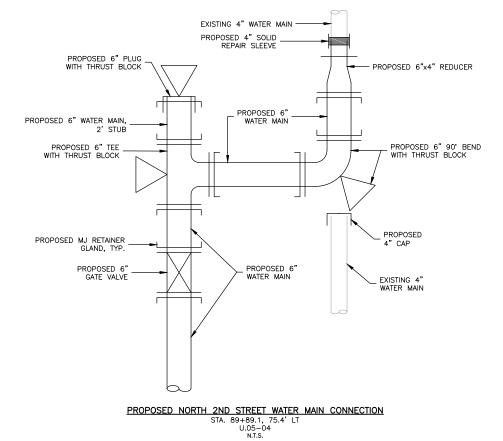

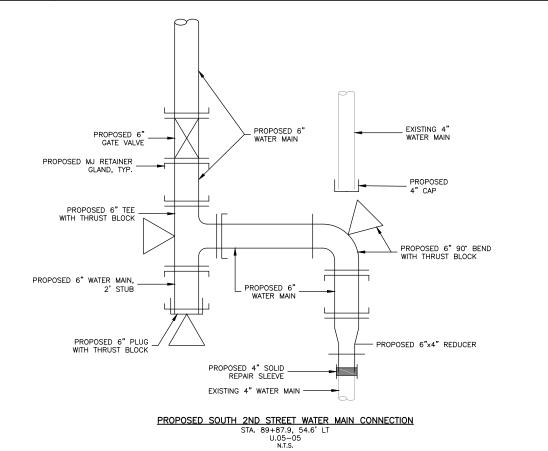



ILLINOIS IOWA WISCONSIN owner/developer:
CITY OF FAIRBANK
116 EAST MAIN STREET
FAIRBANK, IA 50629

PROJECT AND LOCATION:

MAIN STREET IMPROVEMENTS
FAIRBANK, IOWA
BUCHANAN COUNTY
STPN-281-2(10)--2J-10

DRAWN BY: AFC
APPROVED BY: JSB
DATE: 10/27/22
SCALE: AS NOTED

REVISIONS

REV. NO. DESCRIPTION DATE


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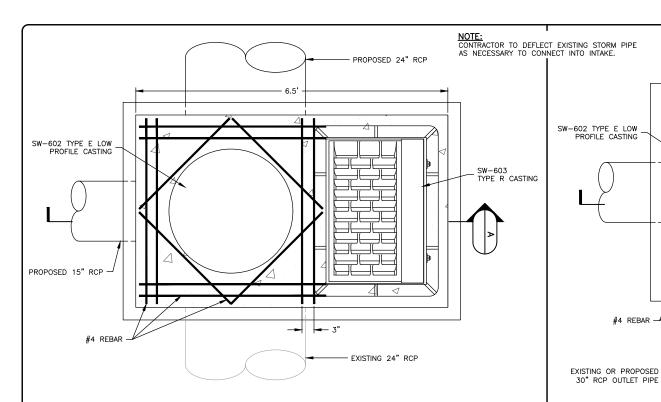
SET TYPE: BID LETTING

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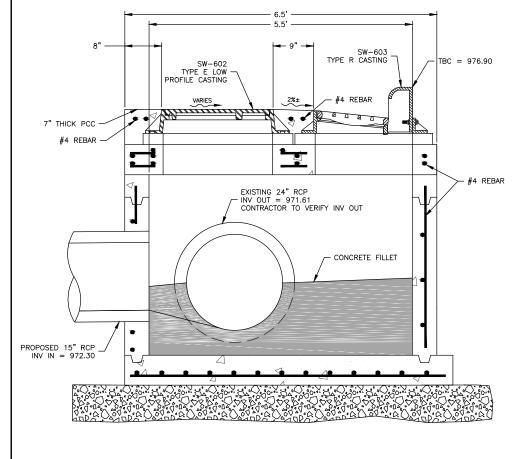
JOB NUMBER:
22-1100
SHEET NUMBER:

U.05



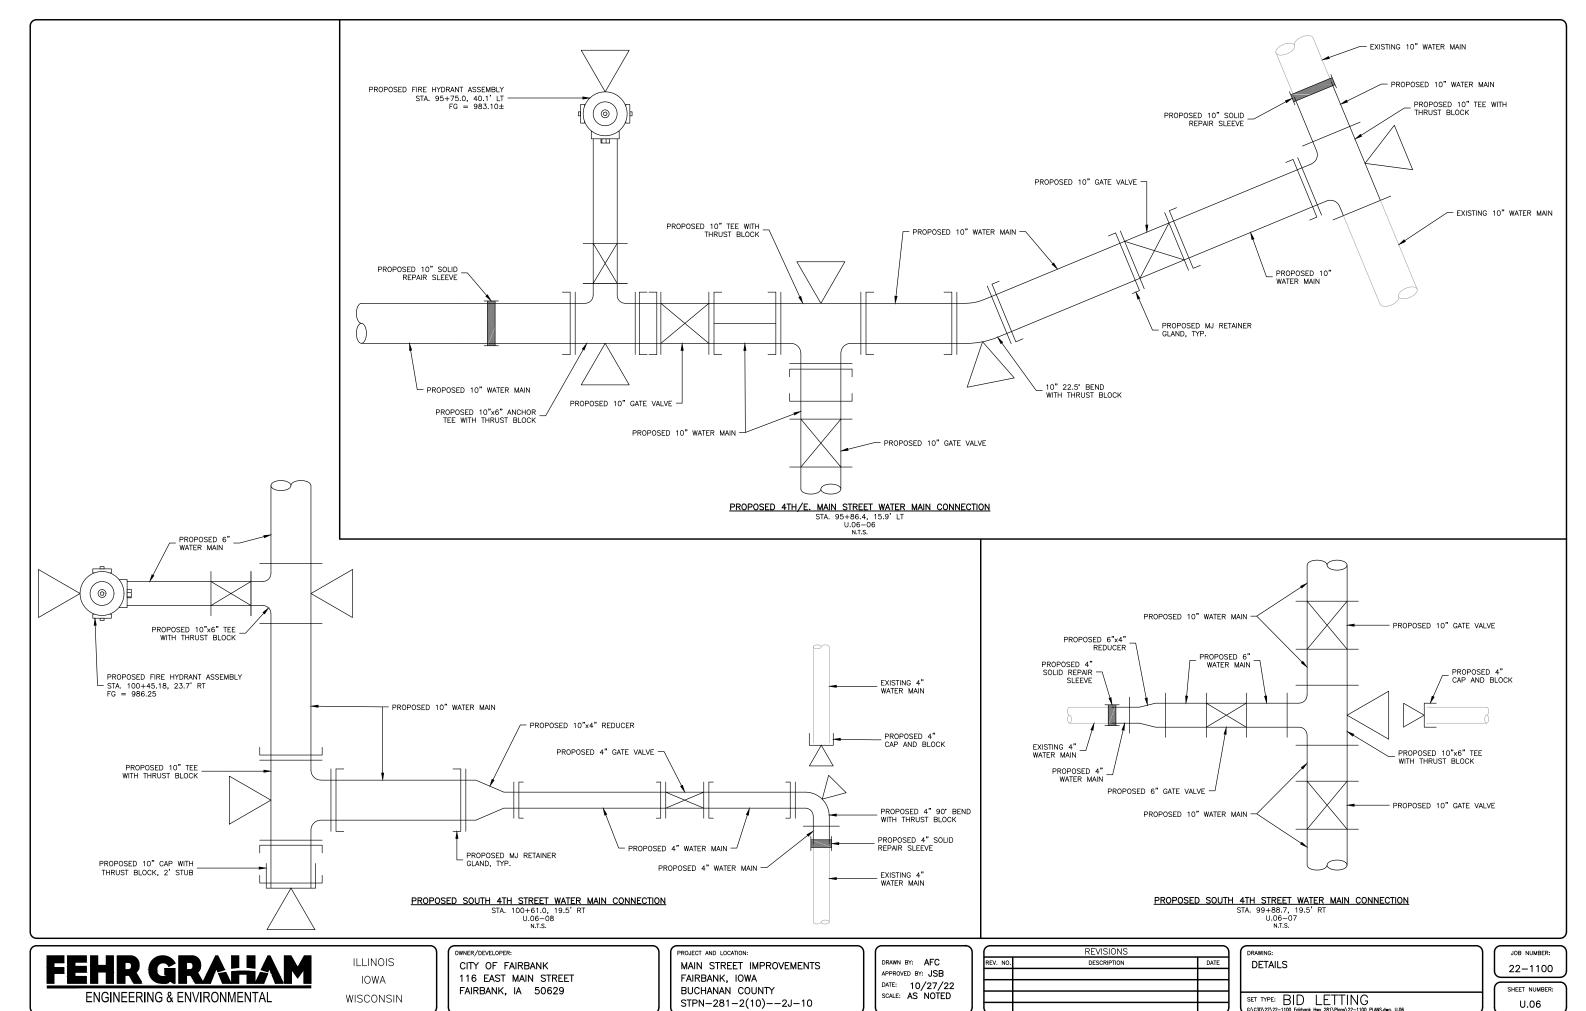

$\underset{\text{N.T.s.}}{\underline{\mathsf{MODIFIED}}} \hspace{0.1cm} \underline{\mathsf{SW-503}} \hspace{0.1cm} \underline{\mathsf{FOR}} \hspace{0.1cm} \underbrace{\mathsf{EXISTING}} \hspace{0.1cm} \underset{\text{N.T.s.}}{\underline{\mathsf{STORM}}} \hspace{0.1cm} \underset{\text{SEWER}}{\underline{\mathsf{SEWER}}} \hspace{0.1cm} \underline{\mathsf{CONNECTIONS}} \hspace{0.1cm} \underline{\mathsf{DETAIL}}$



MODIFIED SW-503 FOR EXISTING STORM SEWER CONNECTIONS CROSS SECTION PROFILE VIEW N.T.S.

WNER/DEVELOPER CITY OF FAIRBANK 116 EAST MAIN STREET FAIRBANK, IA 50629

PROJECT AND LOCATION MAIN STREET IMPROVEMENTS FAIRBANK, IOWA BUCHANAN COUNTY STPN-281-2(10)--2J-10

#4 REBAR

7" THICK PCC #4 REBAR

PROPOSED 15" RCP

DRAWN BY: AFC APPROVED BY: JSB DATE: 10/27/22 SCALE: AS NOTED

REVISIONS DATE


DETAILS SET TYPE: BID LETTING

JOB NUMBER


22-1100

SHEET NUMBER:

U.07

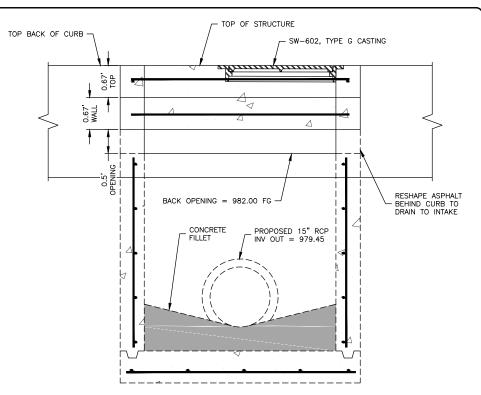

MODIFIED SW-507 FOR EXISTING STORM SEWER CONNECTIONS DETAIL

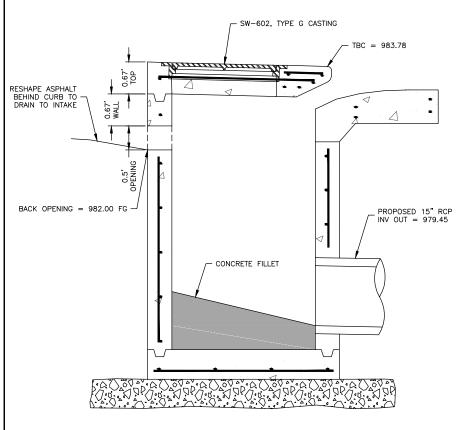

MODIFIED SW-507 FOR EXISTING STORM SEWER CONNECTIONS CROSS SECTION PROFILE VIEW N.T.S.



ILLINOIS IOWA WISCONSIN

EXISTING OR PROPOSED 24" OR 30" RCP,

SW-603 TYPE R CASTING

SW-603 TYPE R CASTING

#4 REBAR

SEE M SHEETS

MODIFIED SW-506 FOR EXISTING STORM SEWER CONNECTIONS DETAIL

PLAN VIEW N.T.S.


SW-602 TYPE E LOW PROFILE CASTING


MODIFIED SW-506 FOR EXISTING STORM SEWER CONNECTIONS CROSS SECTION PROFILE VIEW N.T.S.


EXISTING OR PROPOSED 30" RCP

CONCRETE FILLET

Miniman hint

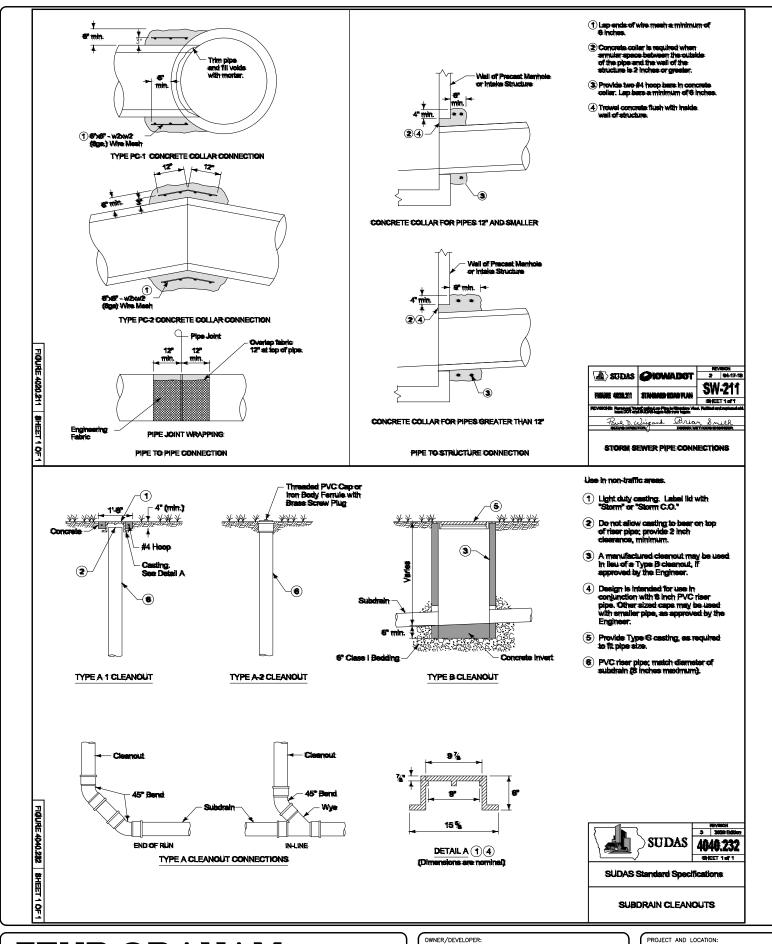

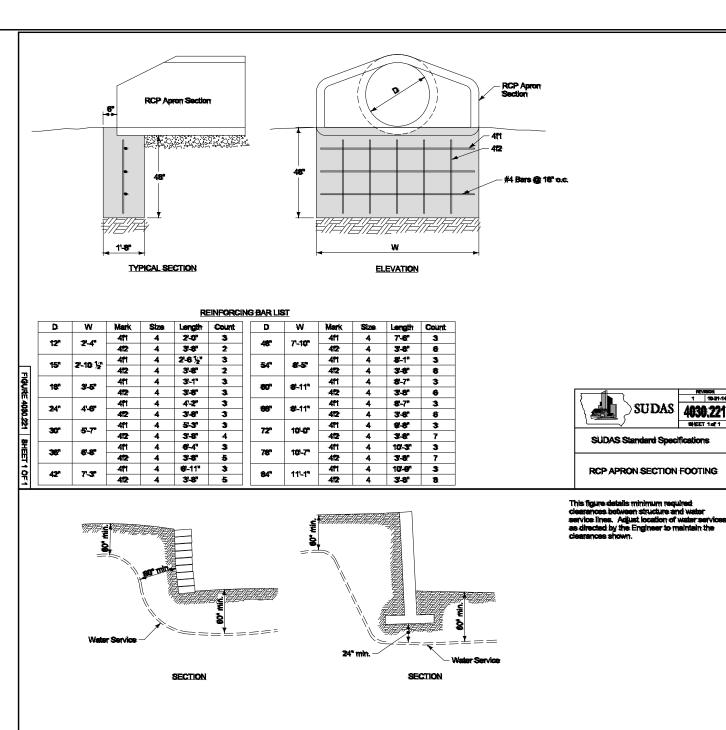

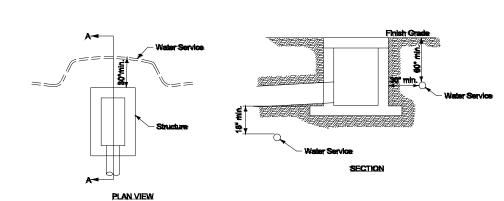



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ENGINEERING & ENVIRONMENTAL

ILLINOIS IOWA WISCONSIN OWNER/DEVELOPER:

CITY OF FAIRBANK

116 EAST MAIN STREET
FAIRBANK, IA 50629

PROJECT AND LOCATION:

MAIN STREET IMPROVEMENTS
FAIRBANK, IOWA
BUCHANAN COUNTY
STPN-281-2(10)--2J-10

DRAWN BY: AFC
APPROVED BY: JSB
DATE: 10/27/22
SCALE: AS NOTED

	REVISIONS	
REV. NO.	DESCRIPTION	DATE


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SET TYPE: BID LETTING

JOB NUMBER:


22-1100

SHEET NUMBER:

U.08

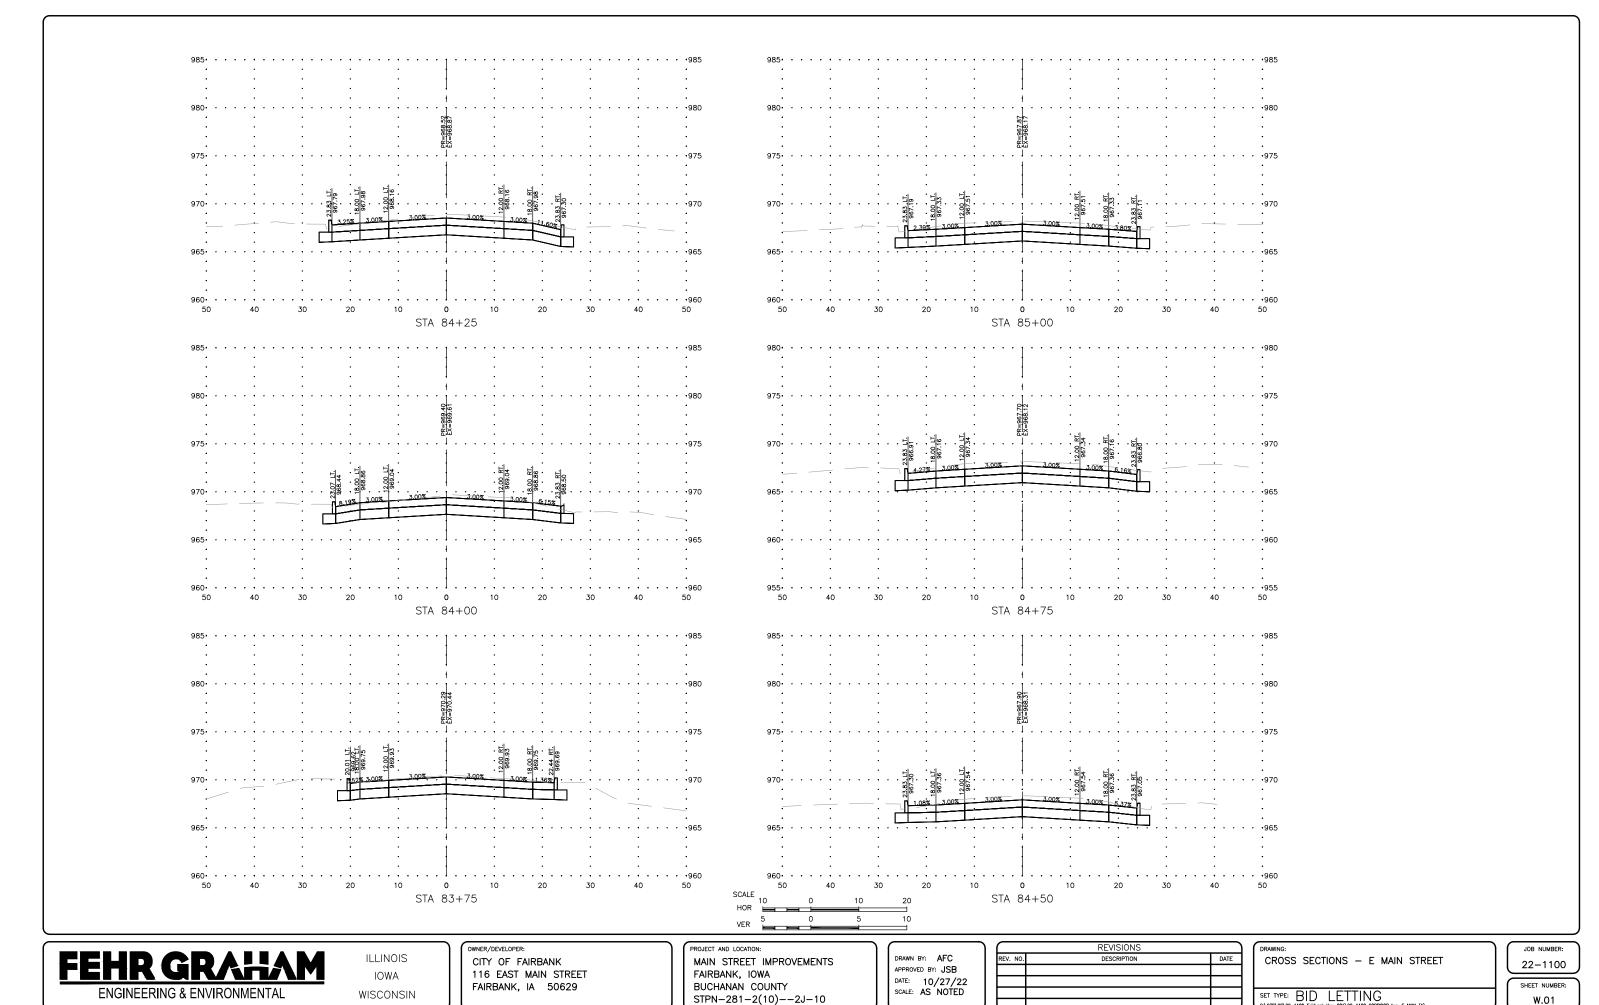

PLOT DATE: 10/31/22 © 2022 FEHR GRAHAM

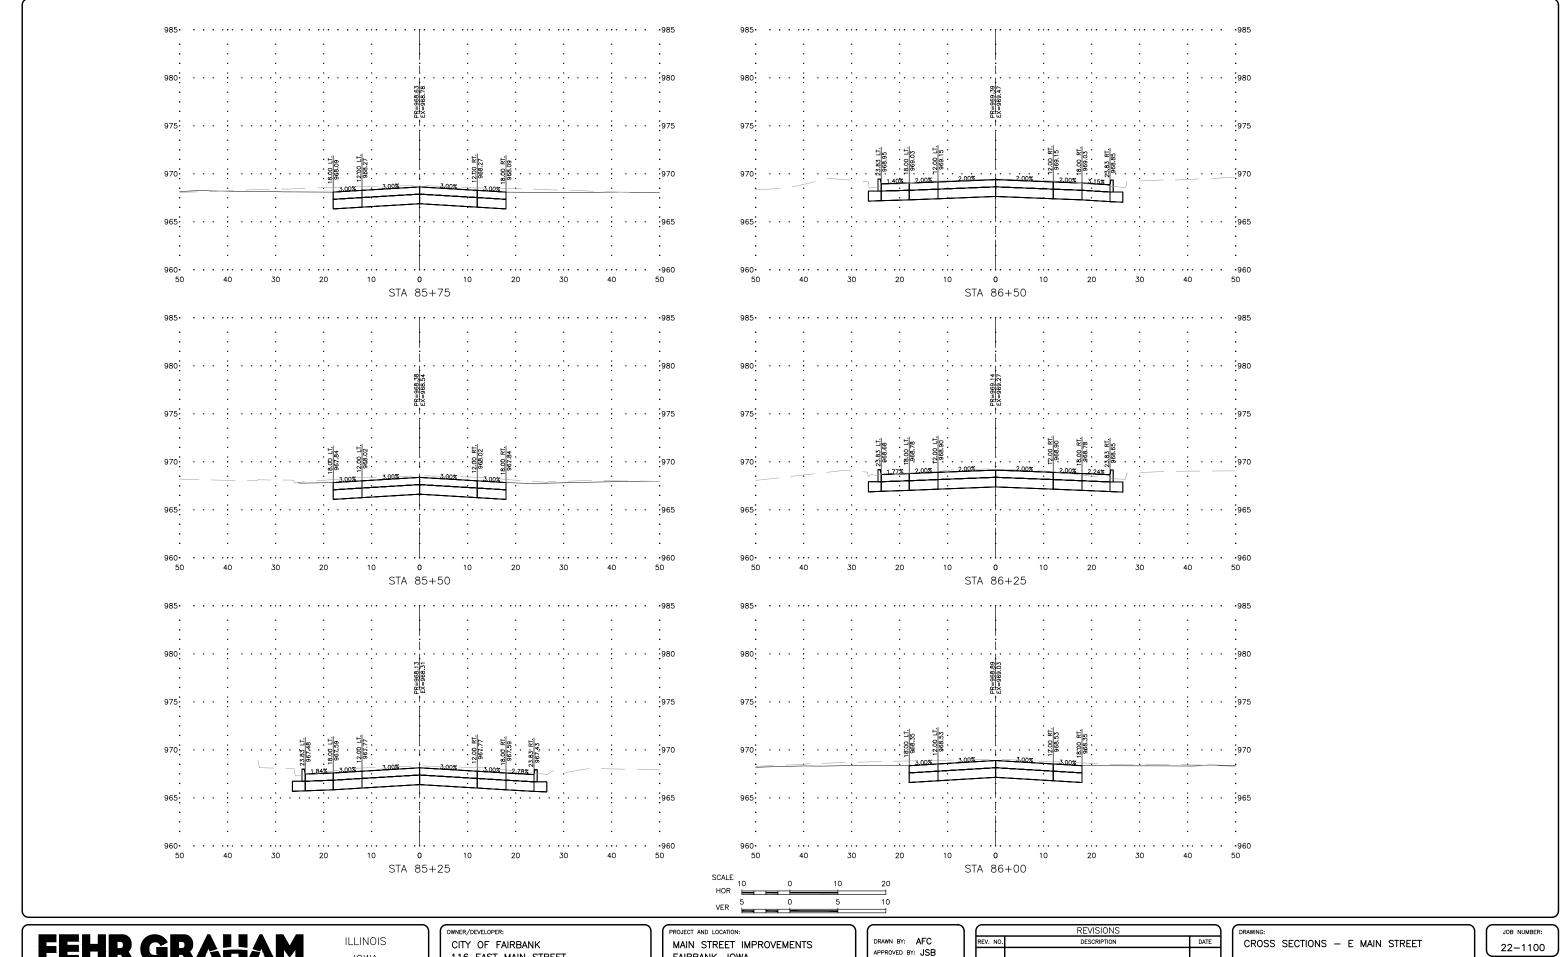

IOWA WISCONSIN 116 EAST MAIN STREET FAIRBANK, IA 50629

FAIRBANK, IOWA BUCHANAN COUNTY STPN-281-2(10)--2J-10


APPROVED BY: JSB DATE: 10/27/22 SCALE: AS NOTED

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REV. NO.	DESCRIPTION	DATE

SET TYPE: BID LETTING

W.02

PLOT DATE: 10/31/22 © 2022 FEHR GRAHAM

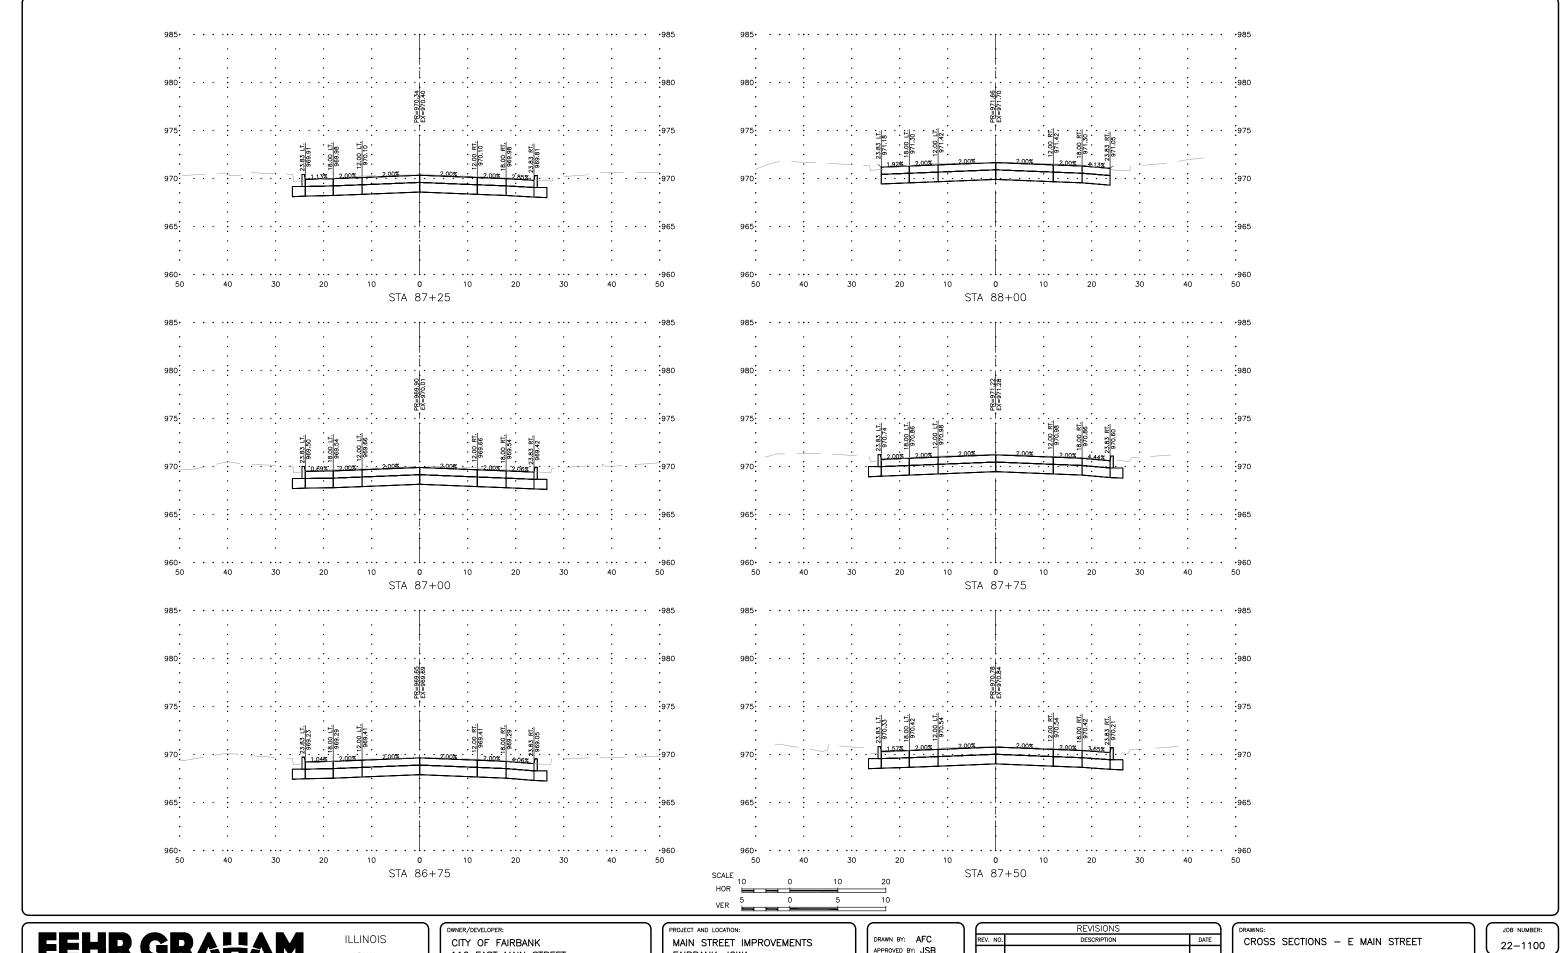


IOWA WISCONSIN 116 EAST MAIN STREET FAIRBANK, IA 50629

FAIRBANK, IOWA BUCHANAN COUNTY STPN-281-2(10)--2J-10

APPROVED BY: JSB DATE: 10/27/22 SCALE: AS NOTED

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SET TYPE: BID LETTING

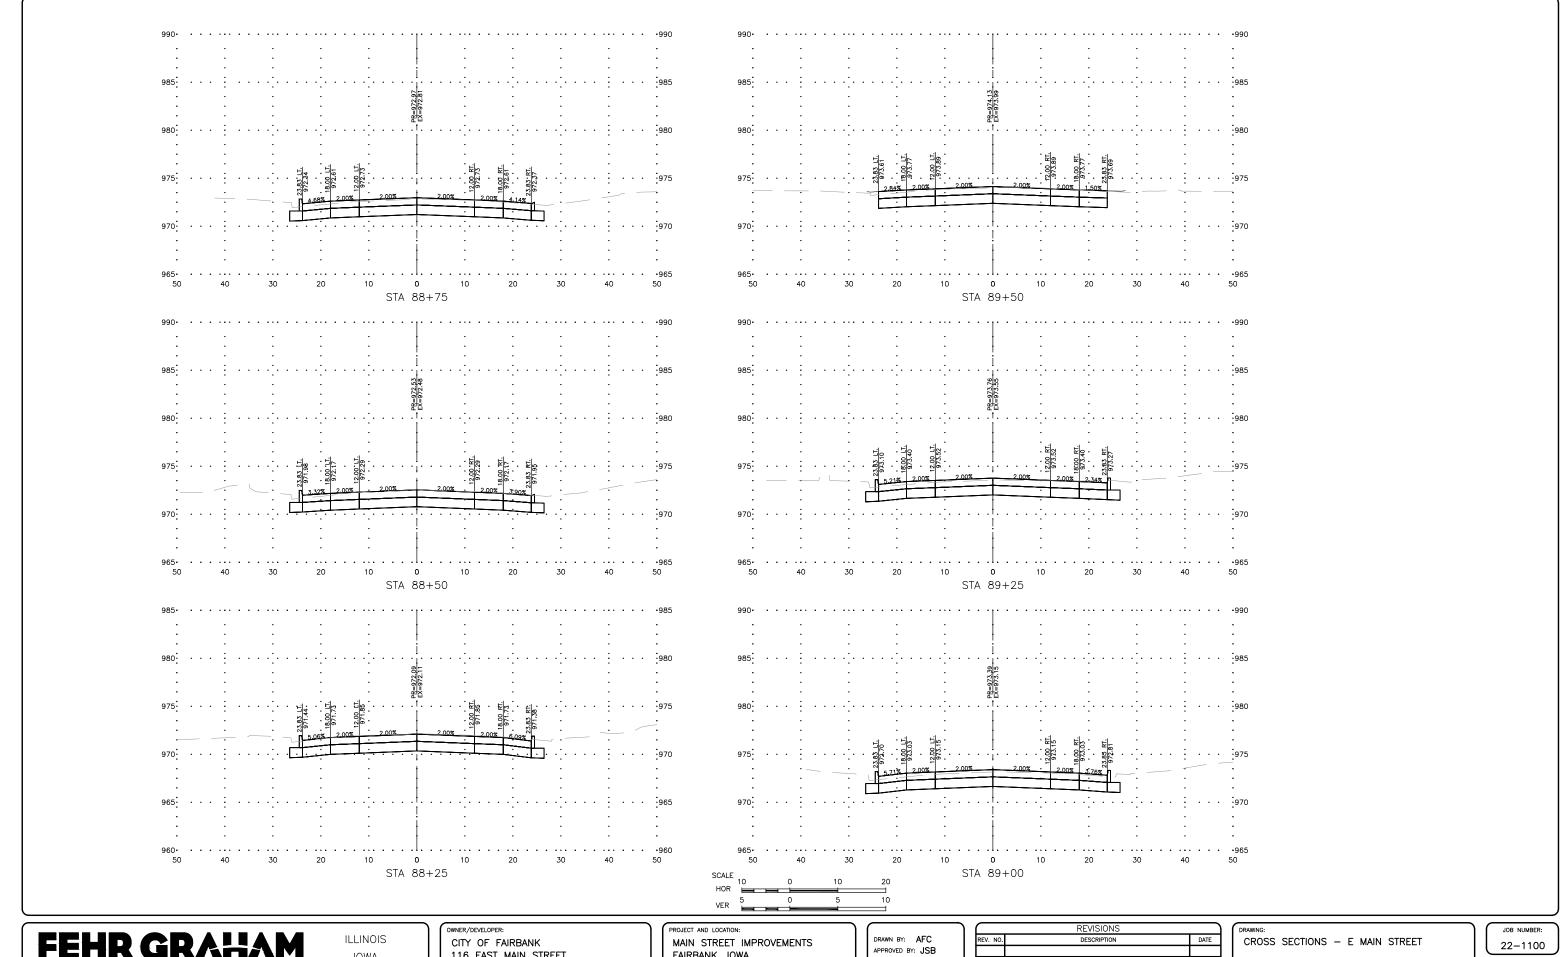


IOWA WISCONSIN 116 EAST MAIN STREET FAIRBANK, IA 50629

FAIRBANK, IOWA BUCHANAN COUNTY STPN-281-2(10)--2J-10

DATE: 10/27/22 SCALE: AS NOTED

REVISIONS		
V. NO.	DESCRIPTION	DATE

SET TYPE: BID LETTING

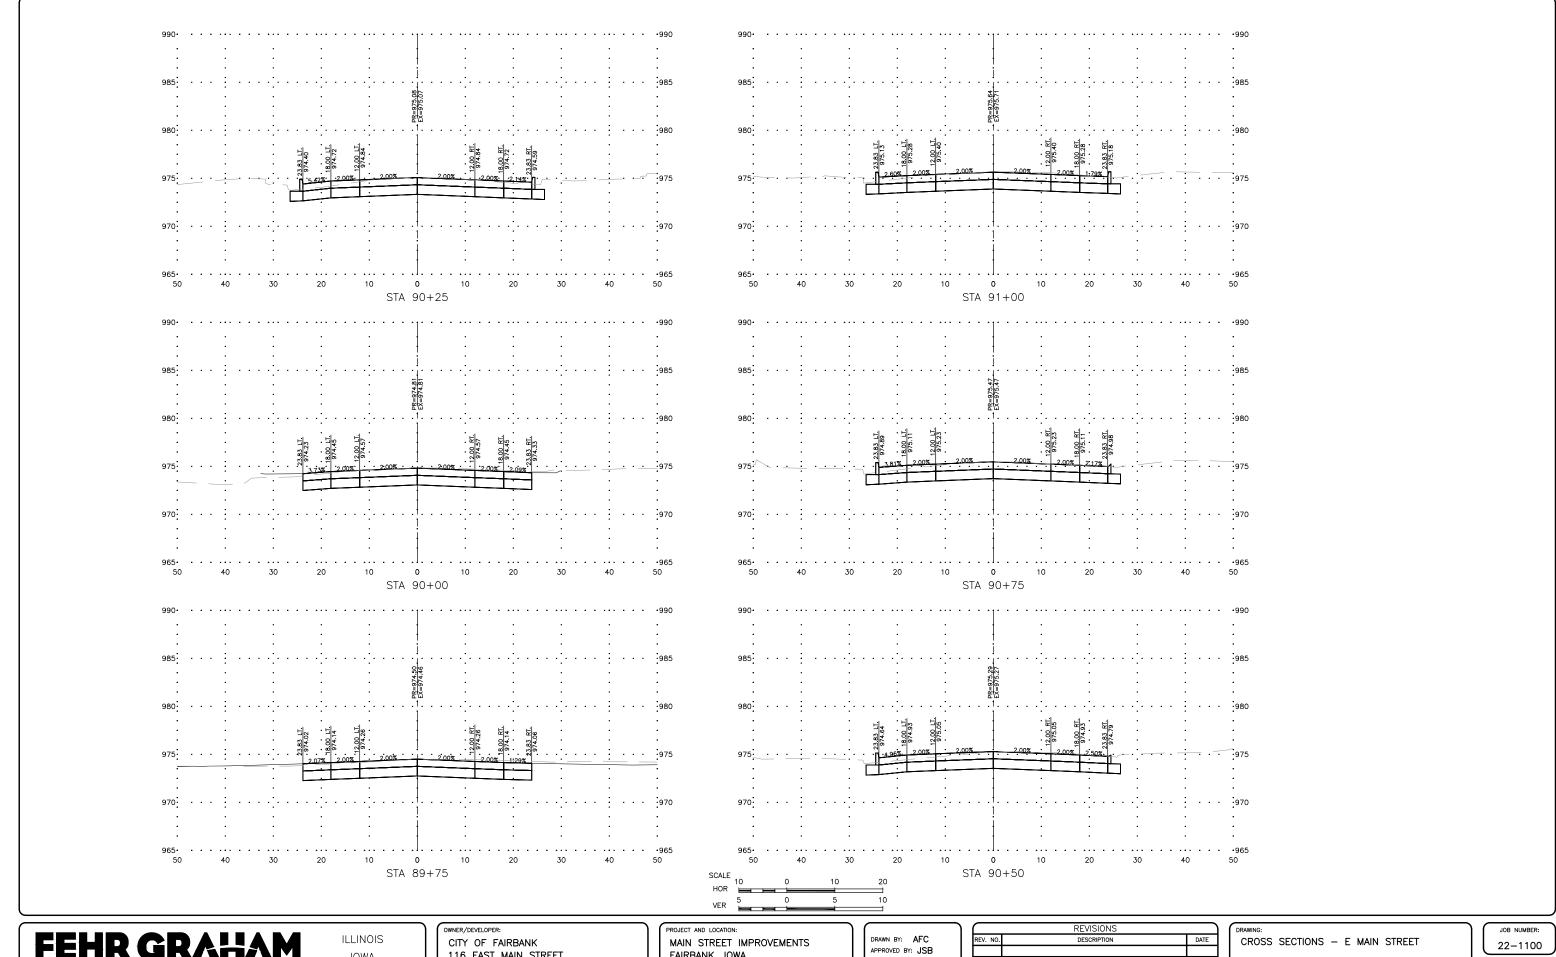


IOWA WISCONSIN 116 EAST MAIN STREET FAIRBANK, IA 50629

FAIRBANK, IOWA BUCHANAN COUNTY STPN-281-2(10)--2J-10

DATE: 10/27/22 SCALE: AS NOTED

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REV. NO.	DESCRIPTION	DATE	

SET TYPE: BID LETTING

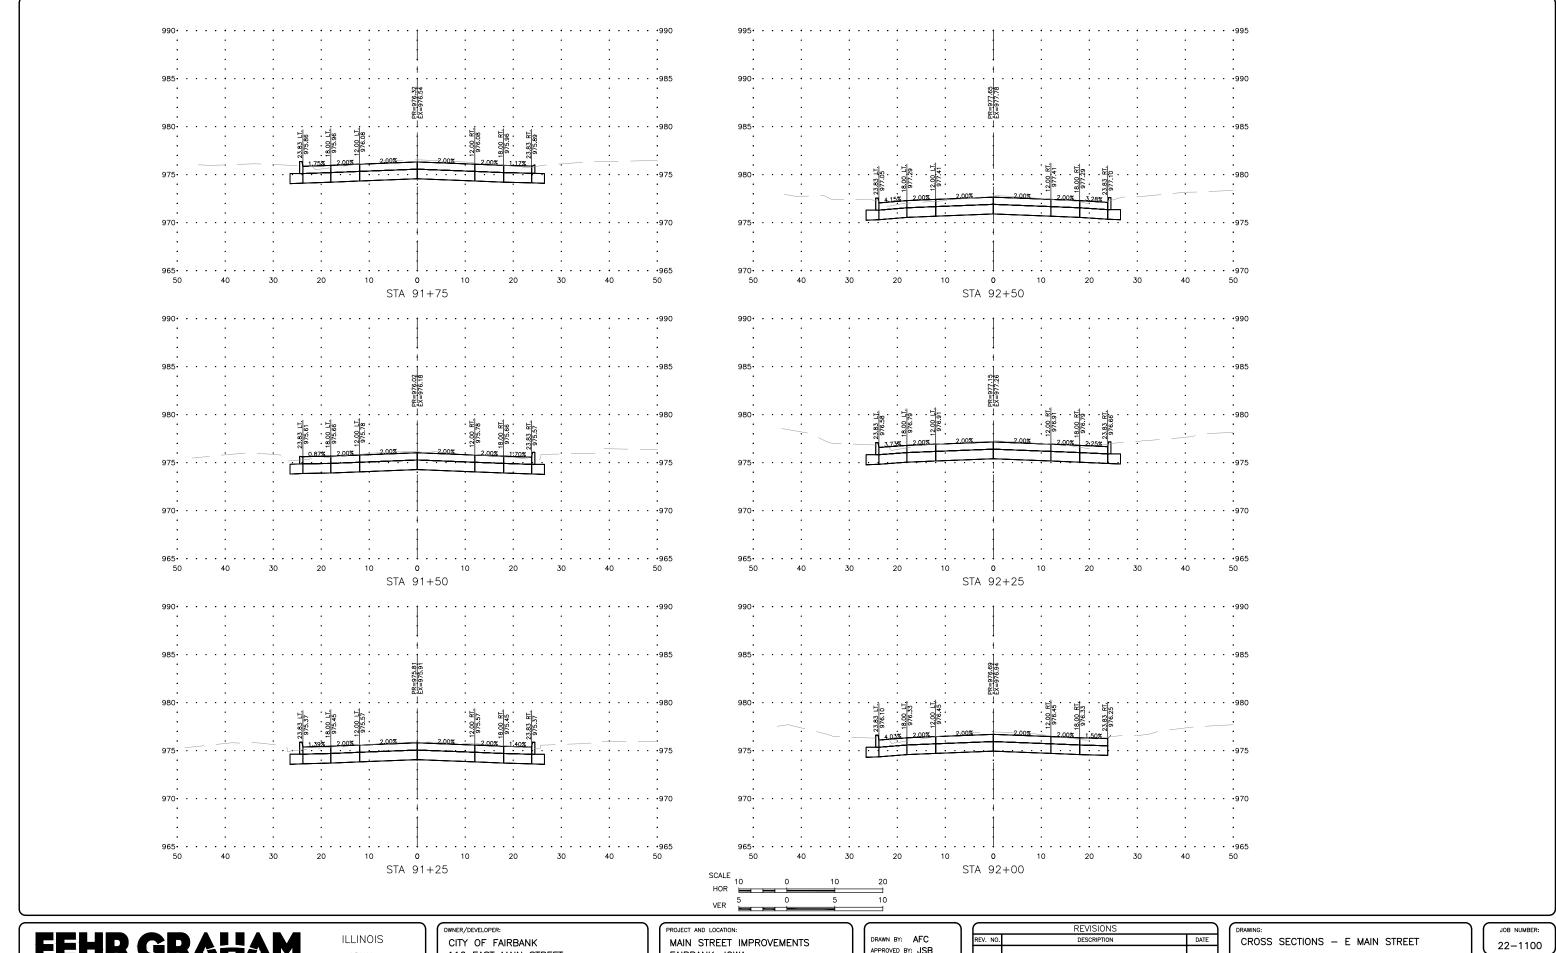


IOWA WISCONSIN 116 EAST MAIN STREET FAIRBANK, IA 50629

FAIRBANK, IOWA BUCHANAN COUNTY STPN-281-2(10)--2J-10

APPROVED BY: JSB DATE: 10/27/22 SCALE: AS NOTED

	REVISIONS	
REV. NO.	DESCRIPTION	DATE

SET TYPE: BID LETTING

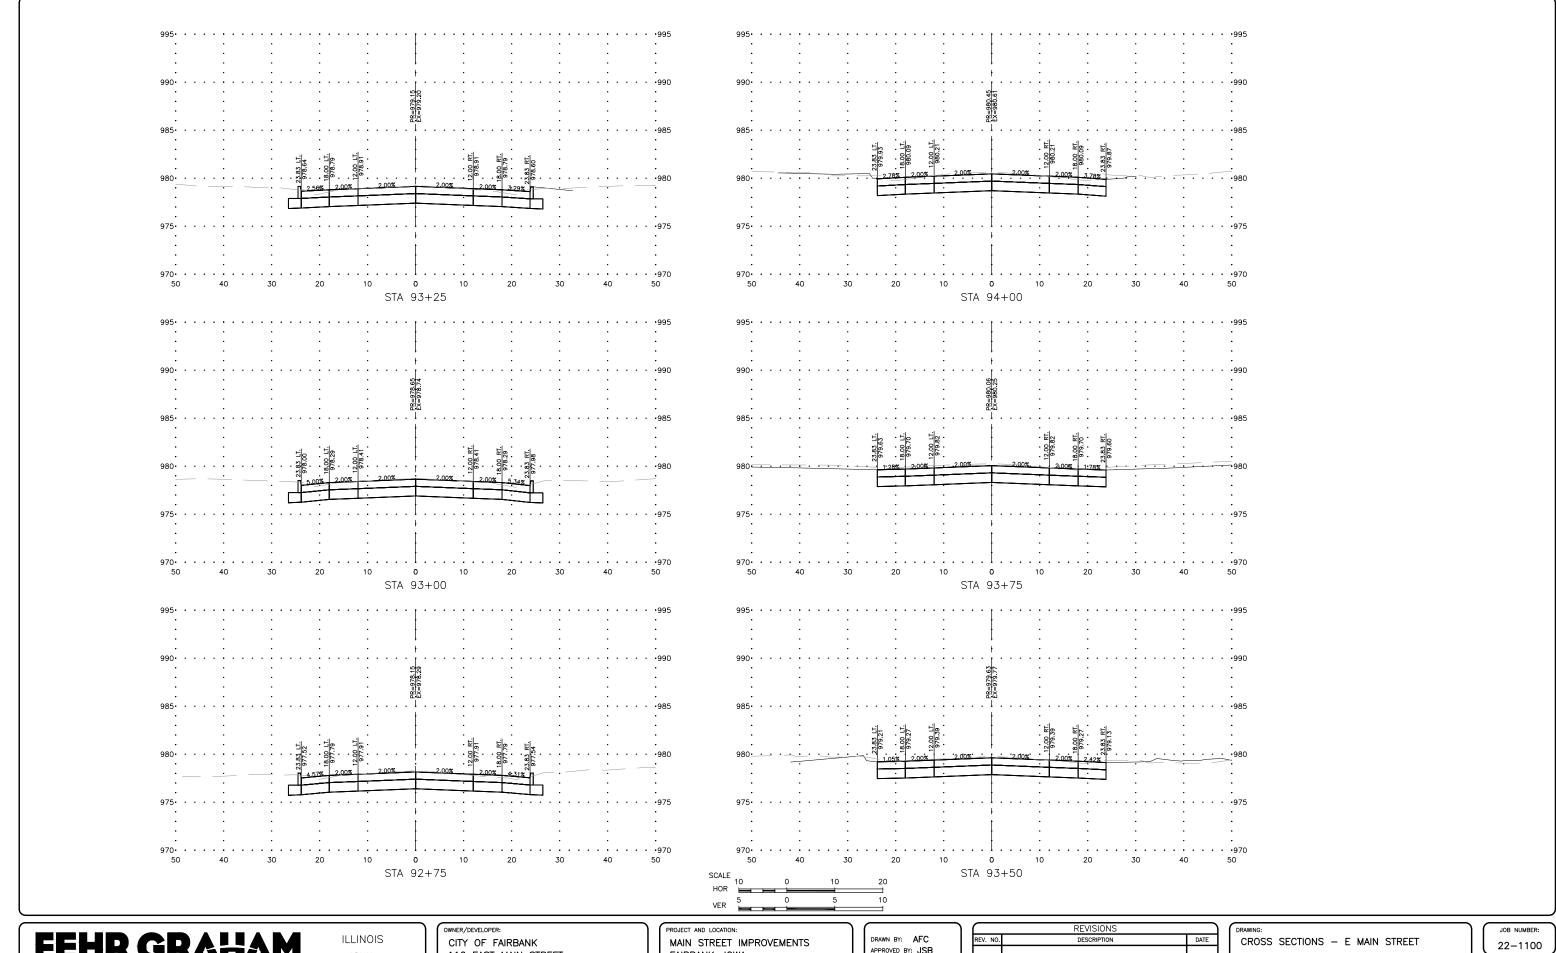

IOWA WISCONSIN


116 EAST MAIN STREET FAIRBANK, IA 50629

FAIRBANK, IOWA BUCHANAN COUNTY STPN-281-2(10)--2J-10

APPROVED BY: JSB DATE: 10/27/22 SCALE: AS NOTED

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SET TYPE: BID LETTING

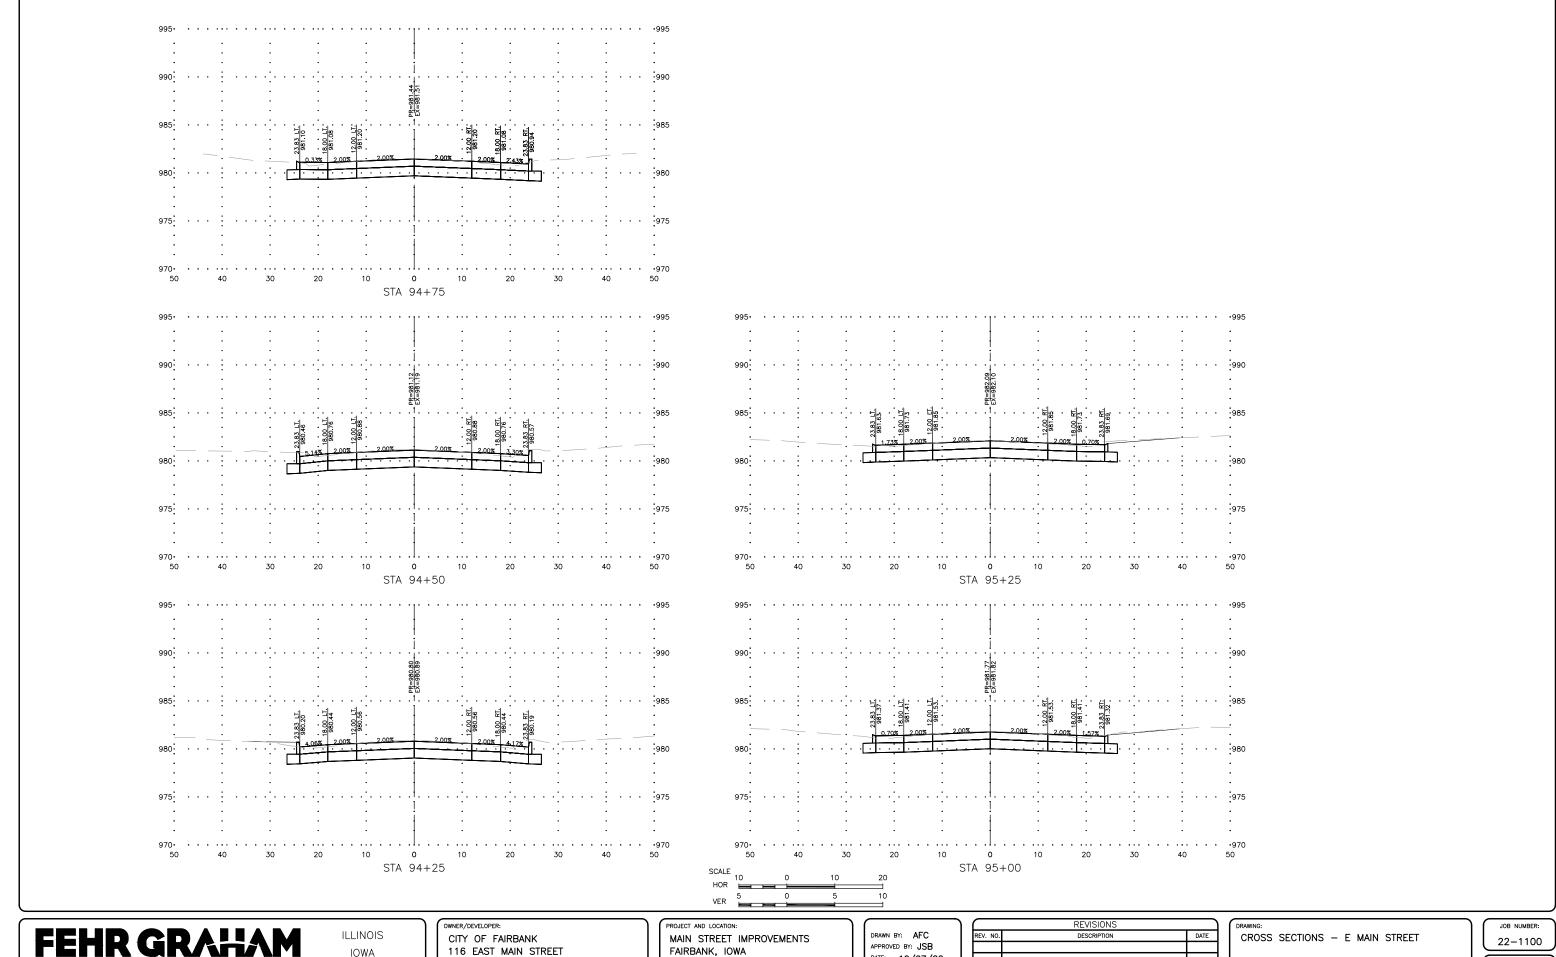

IOWA WISCONSIN FAIRBANK, IA 50629

BUCHANAN COUNTY STPN-281-2(10)--2J-10


DATE: 10/27/22 SCALE: AS NOTED

	REVISIONS	
REV. NO.	DESCRIPTION	DATE

SET TYPE: BID LETTING

W.08

PLOT DATE: 10/31/22 © 2022 FEHR GRAHAM

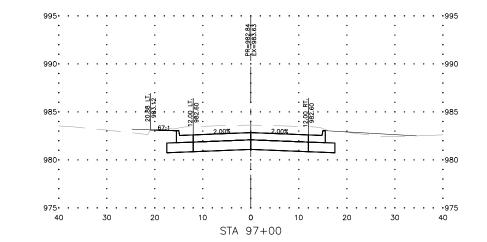



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ENGINEERING & ENVIRONMENTAL

ILLINOIS IOWA WISCONSIN OWNER/DEVELOPER:

CITY OF FAIRBANK

116 EAST MAIN STREET
FAIRBANK, IA 50629

PROJECT AND LOCATION:

MAIN STREET IMPROVEMENTS
FAIRBANK, IOWA
BUCHANAN COUNTY
STPN-281-2(10)--2J-10


DRAWN BY: AFC
APPROVED BY: JSB
DATE: 10/27/22
SCALE: AS NOTED

	REVISIONS	
REV. NO.	DESCRIPTION	DATE

CROSS SECTIONS — 4TH STREET

SET TYPE: BID LETTING

22-1100 SHEET NUMBER:

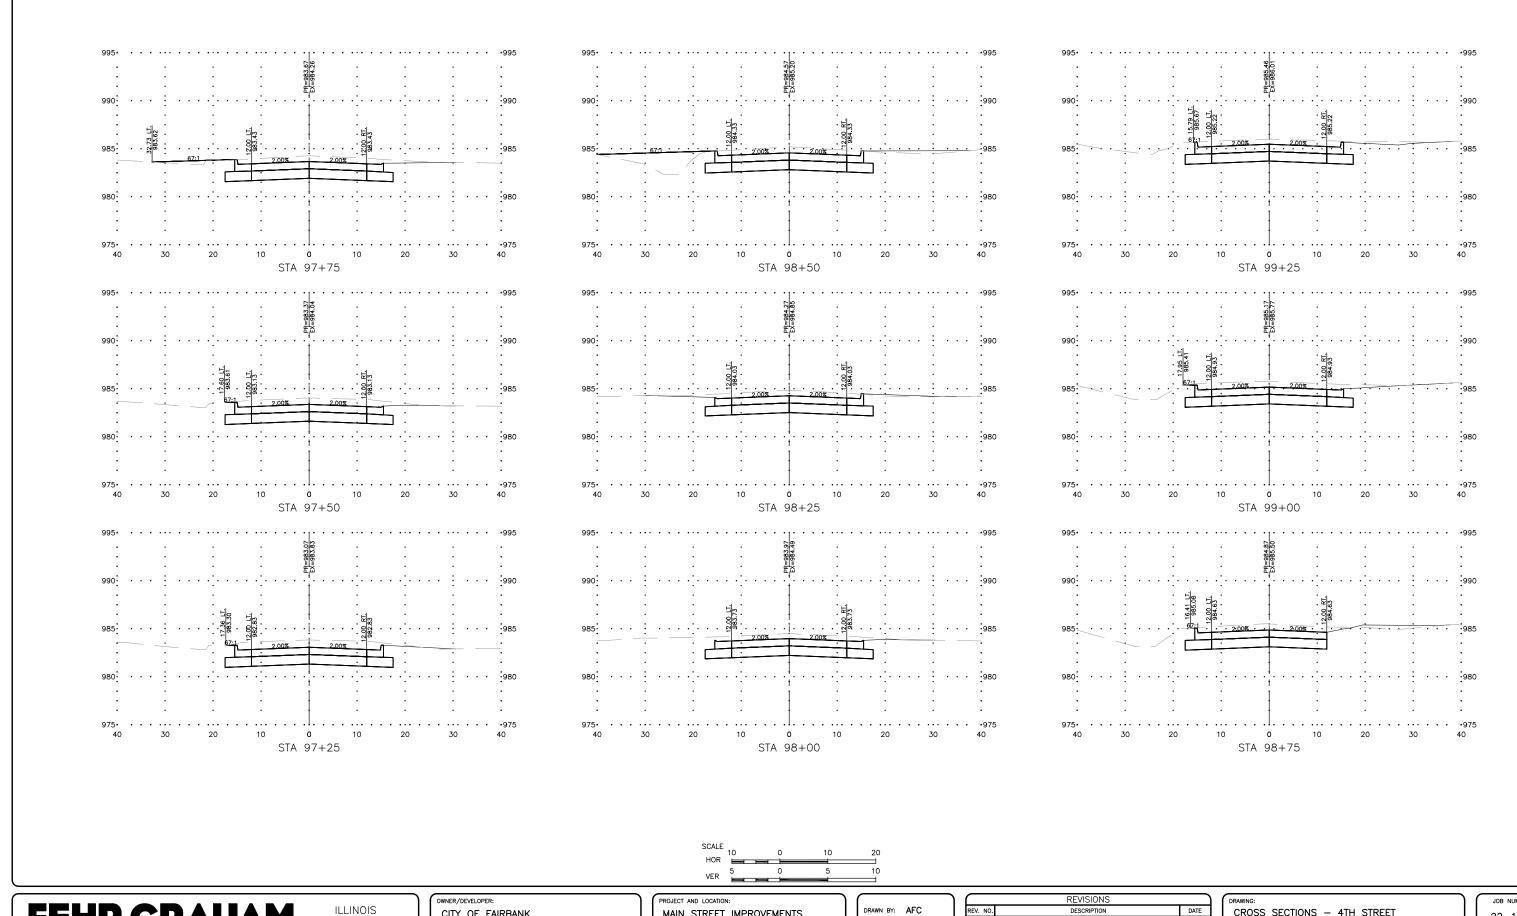

ILLINOIS IOWA WISCONSIN CITY OF FAIRBANK 116 EAST MAIN STREET FAIRBANK, IA 50629 MAIN STREET IMPROVEMENTS
FAIRBANK, IOWA
BUCHANAN COUNTY
STPN-281-2(10)--2J-10

DRAWN BY: AFC
APPROVED BY: JSB
DATE: 10/27/22
SCALE: AS NOTED

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REV. NO.	DESCRIPTION	DATE	

DRAWING:

CROSS SECTIONS — 4TH STREET

22-1100

W.10

PLOT DATE: 10/31/22 © 2022 FEHR GRAHAM

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SET TYPE: BID LETTING

6\C30\22\22=1100 Fairbank Hwy 28\\22=1100 CORRIDOR.dwg. 4TH (10)